
TE RAPA GATEWAY DEVELOPMENT WAREHOUSE & OFFICE BUILDINGS: LOT 23 HAMILTON JV INDUSTRIAL PARK

ID	SHEET	31 Aug 2018 Developed Design								
A000	Index & Locality Plan	Α								
A001	Accessibility Plan	Α								
A100	Proposed Site Plan	Α								
A101	Site Plan	Α								
A102	Site Works Details	Α								
A200	Floor Plan: Warehouse	Α								
A201	Groud Floor Plan: Office	Α								
A202	First Floor Plan: Office	Α								
A203	Roof Plan	Α								
A300	Elevations	A								
A301	Sections: Warehouse	Α								
A302	Sections: Office	Α								
A400	Stairs	Α								
A401	Stairs	Α								
A402	Internal Elevations: Ground Floor Office	Α								
A500	Reflected Ceiling Plan	A								
A501	Floor Finishes Plan	Α								
A600	Window Schedule	Α								
A601	Door Schedule	Α								
A602	Plumbing & Drainage Plan	Α								
A700	Construction Details: Warehouse	A								
A701	Construction Details: Office	A								
A702	Construction Details: Warehouse	A							_	_
A703	Construction Details: Warehouse	A				\perp				+
A704	Construction Details: Warehouse	A				_				_
A705	Construction Details: Office	A								-
A706	Construction Details: Office	A				_				+
A707 A708	Construction Details: Office Construction Details: Office	A								-
A708 A709	Construction Details: Office Construction Details: Office	A							_	+
A709 A710	Construction Details: Office Construction Details: Office	A								+
A710 A711	Construction Details: Office Construction Details	A				+				+
A711	Construction Details: Warehouse	A								\perp

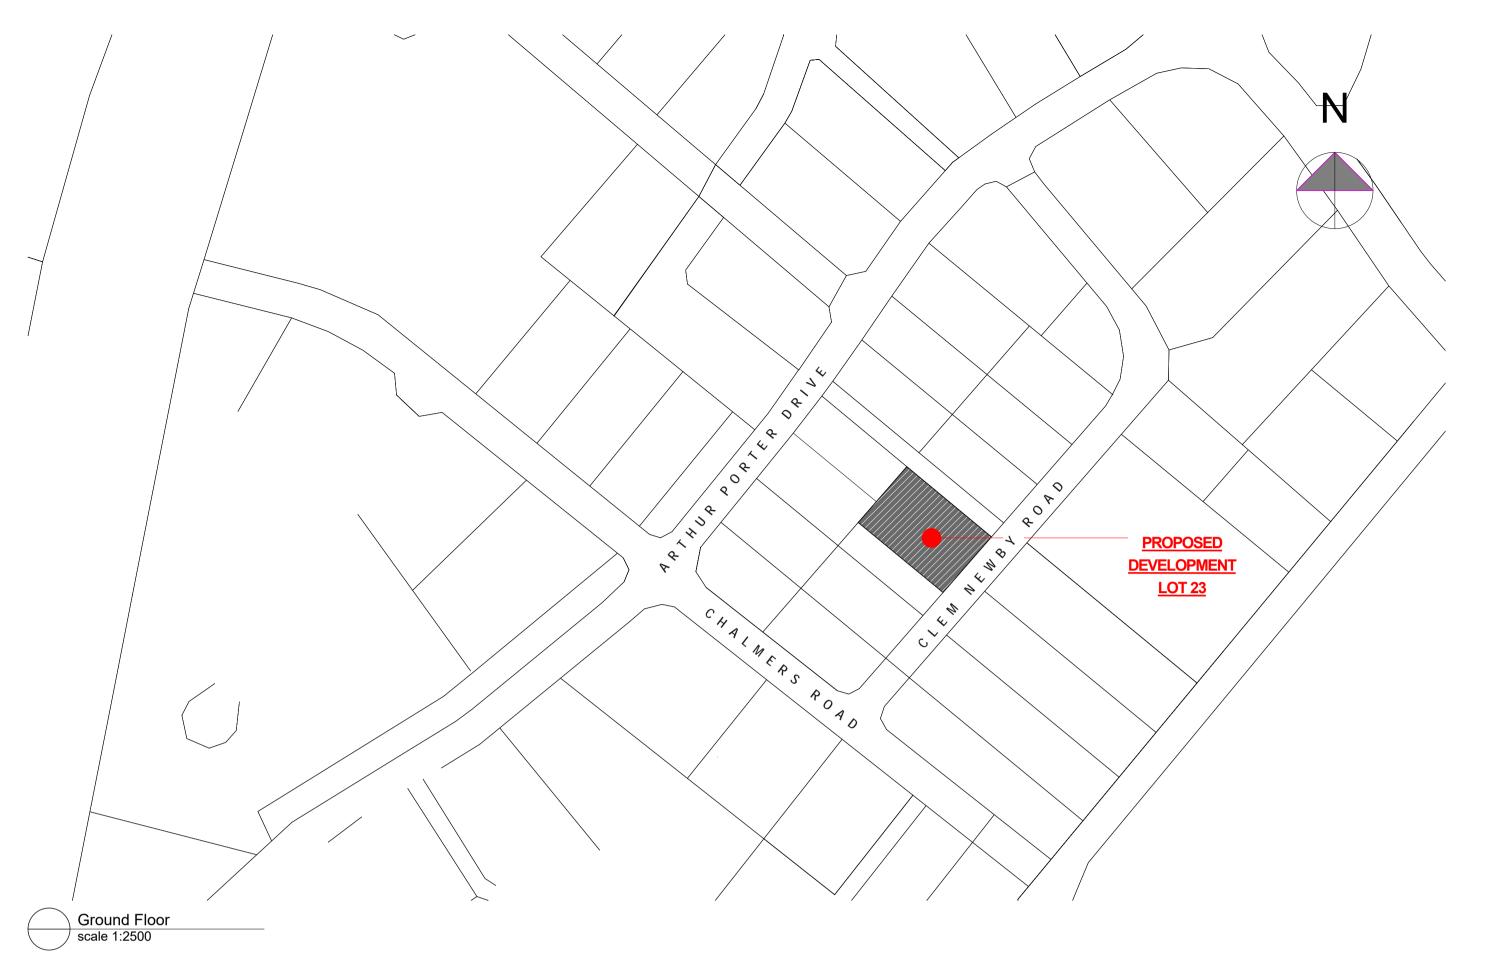





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job no.	CPL0471.00
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drawn	
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date	8/31/2018

TE RAPA GATEWAY
WAREHOUSE &
OFFICE
DEVELOPMENT
LOT 23
(NZ WINDOWS)
HAMILTON JV
INDUSTRIAL PARK

dwg title


Index & Locality Plan


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DEVELOPED DESIGN

scale
AS SHOWN @ A1






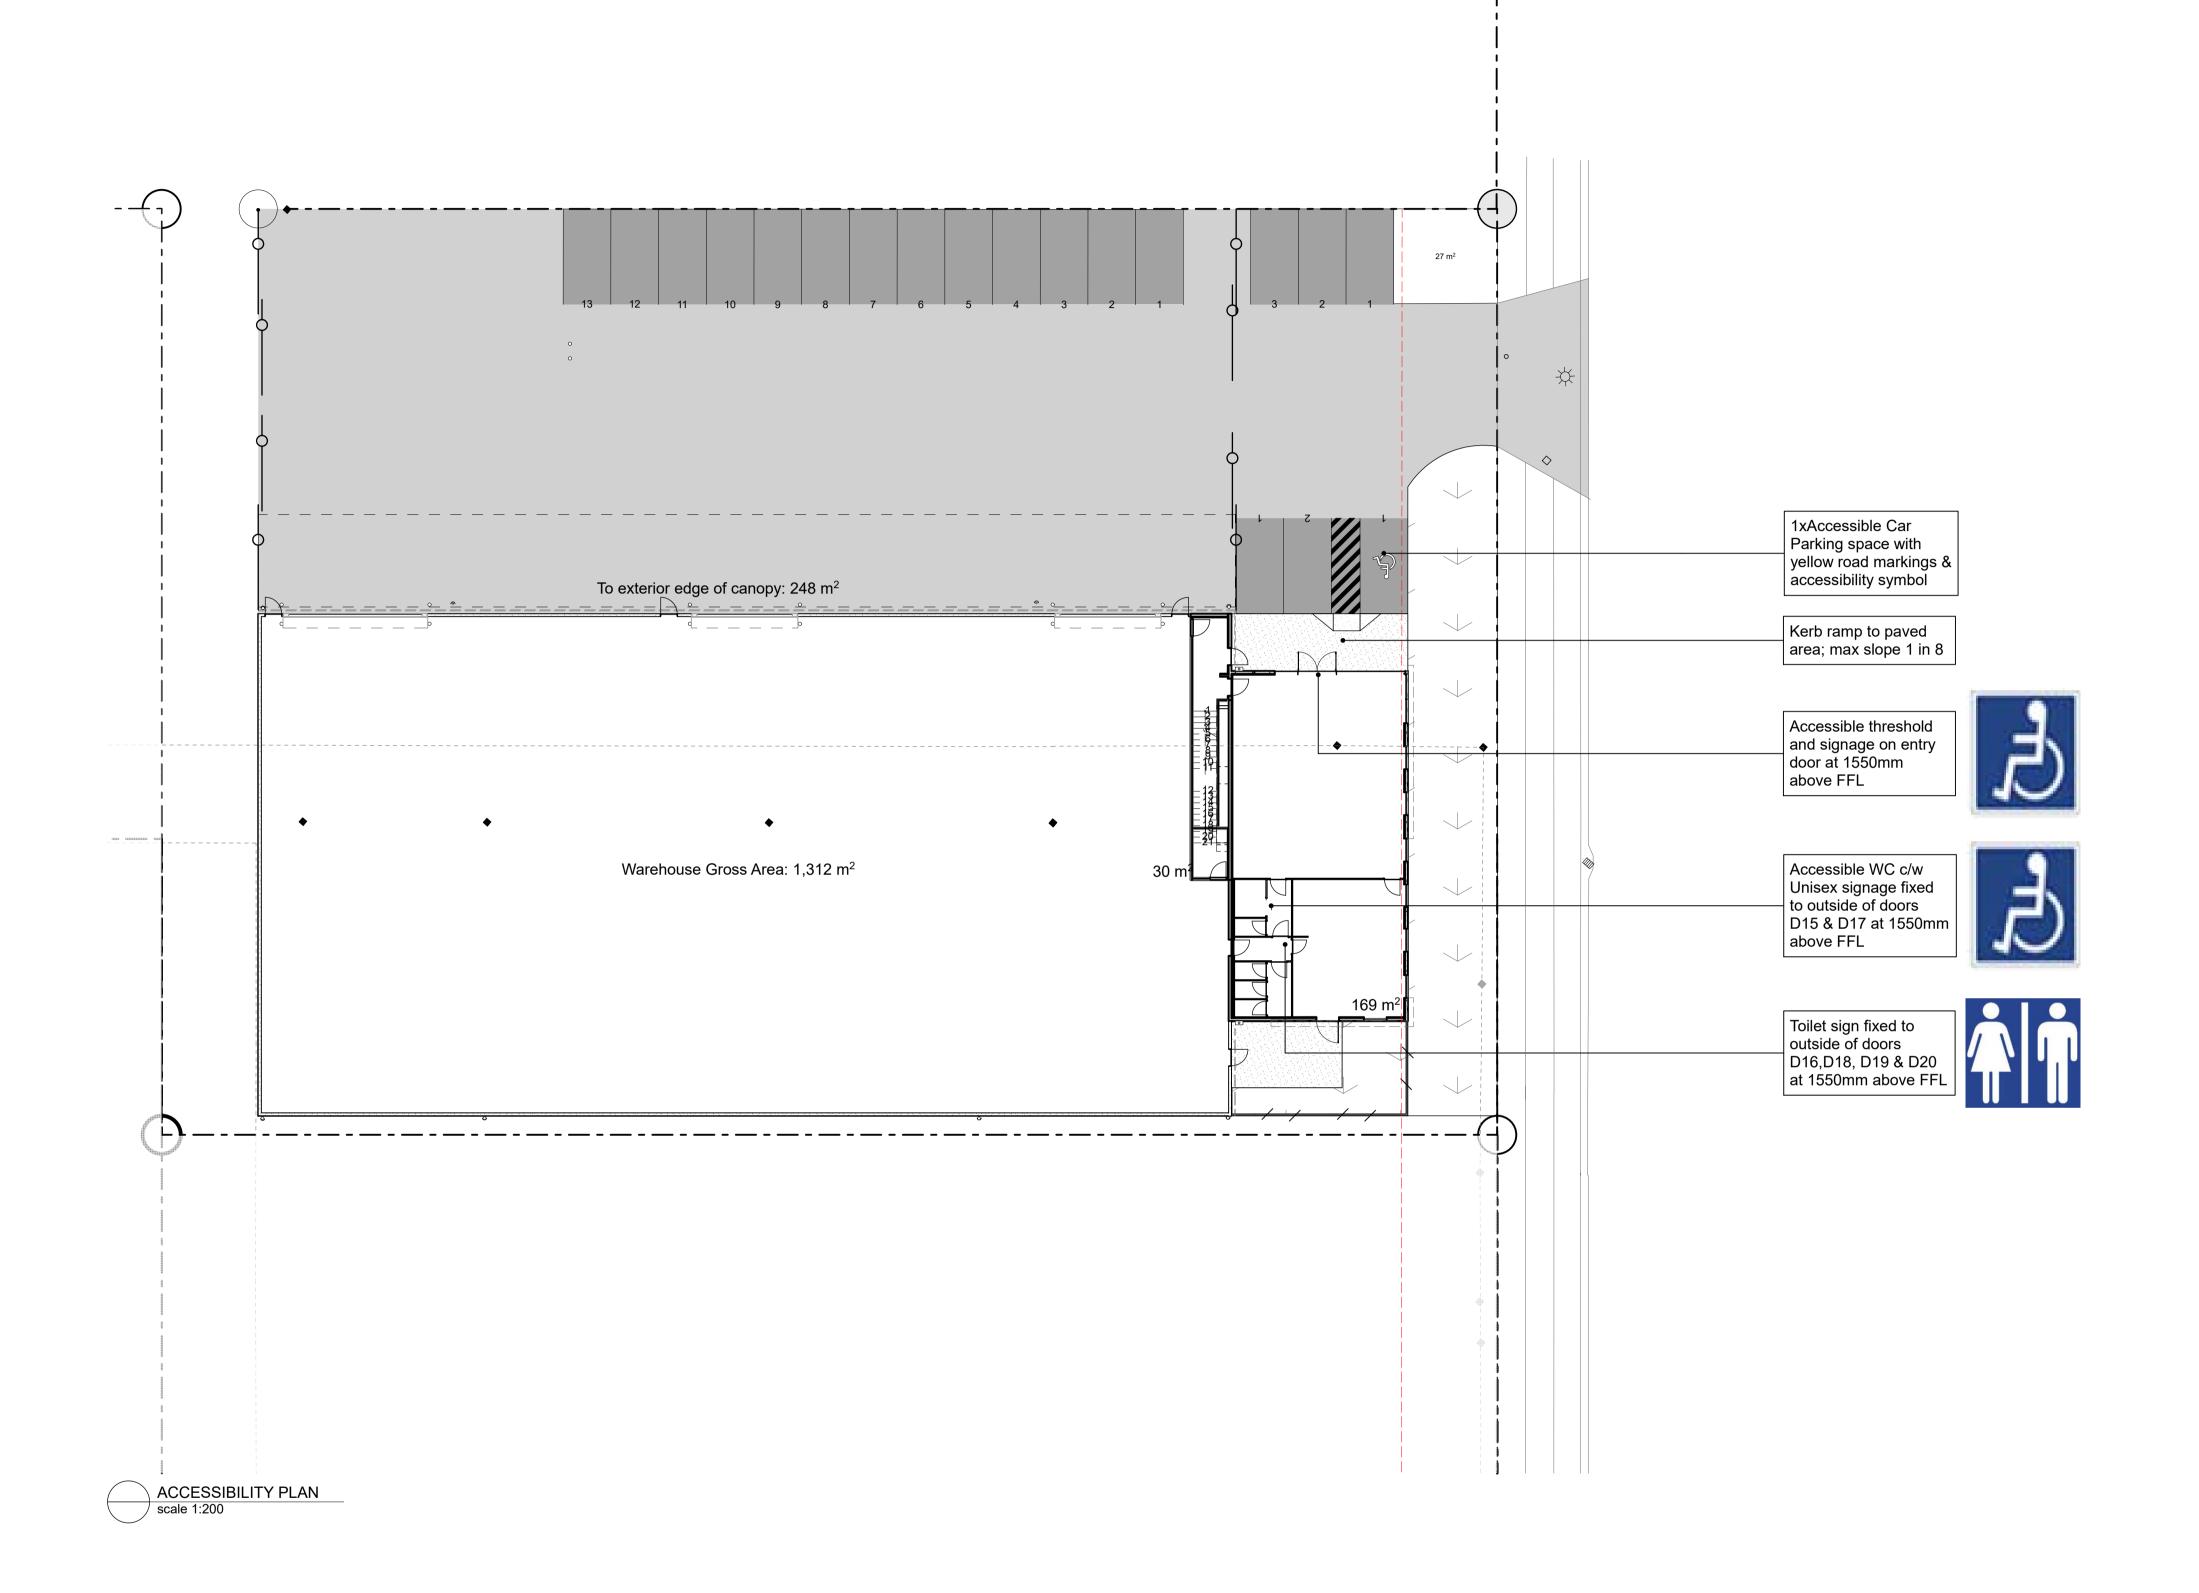

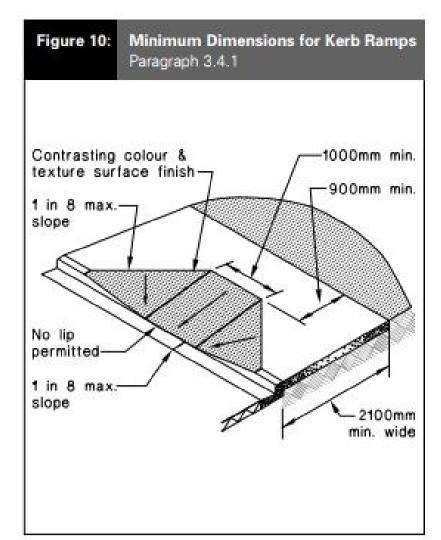KERB RAMP

not to scale

NOTE: Refer A200, A201 & A601 for Accessible Door widths and details

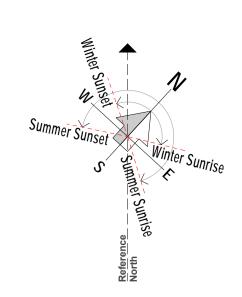

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TE RAPA GATEWAY
WAREHOUSE &
OFFICE
DEVELOPMENT
LOT 23
(NZ WINDOWS)
HAMILTON JV
INDUSTRIAL PARK

dwg title


Accessibility Plan

status

DEVELOPED DESIGN

scale
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1 dwg No



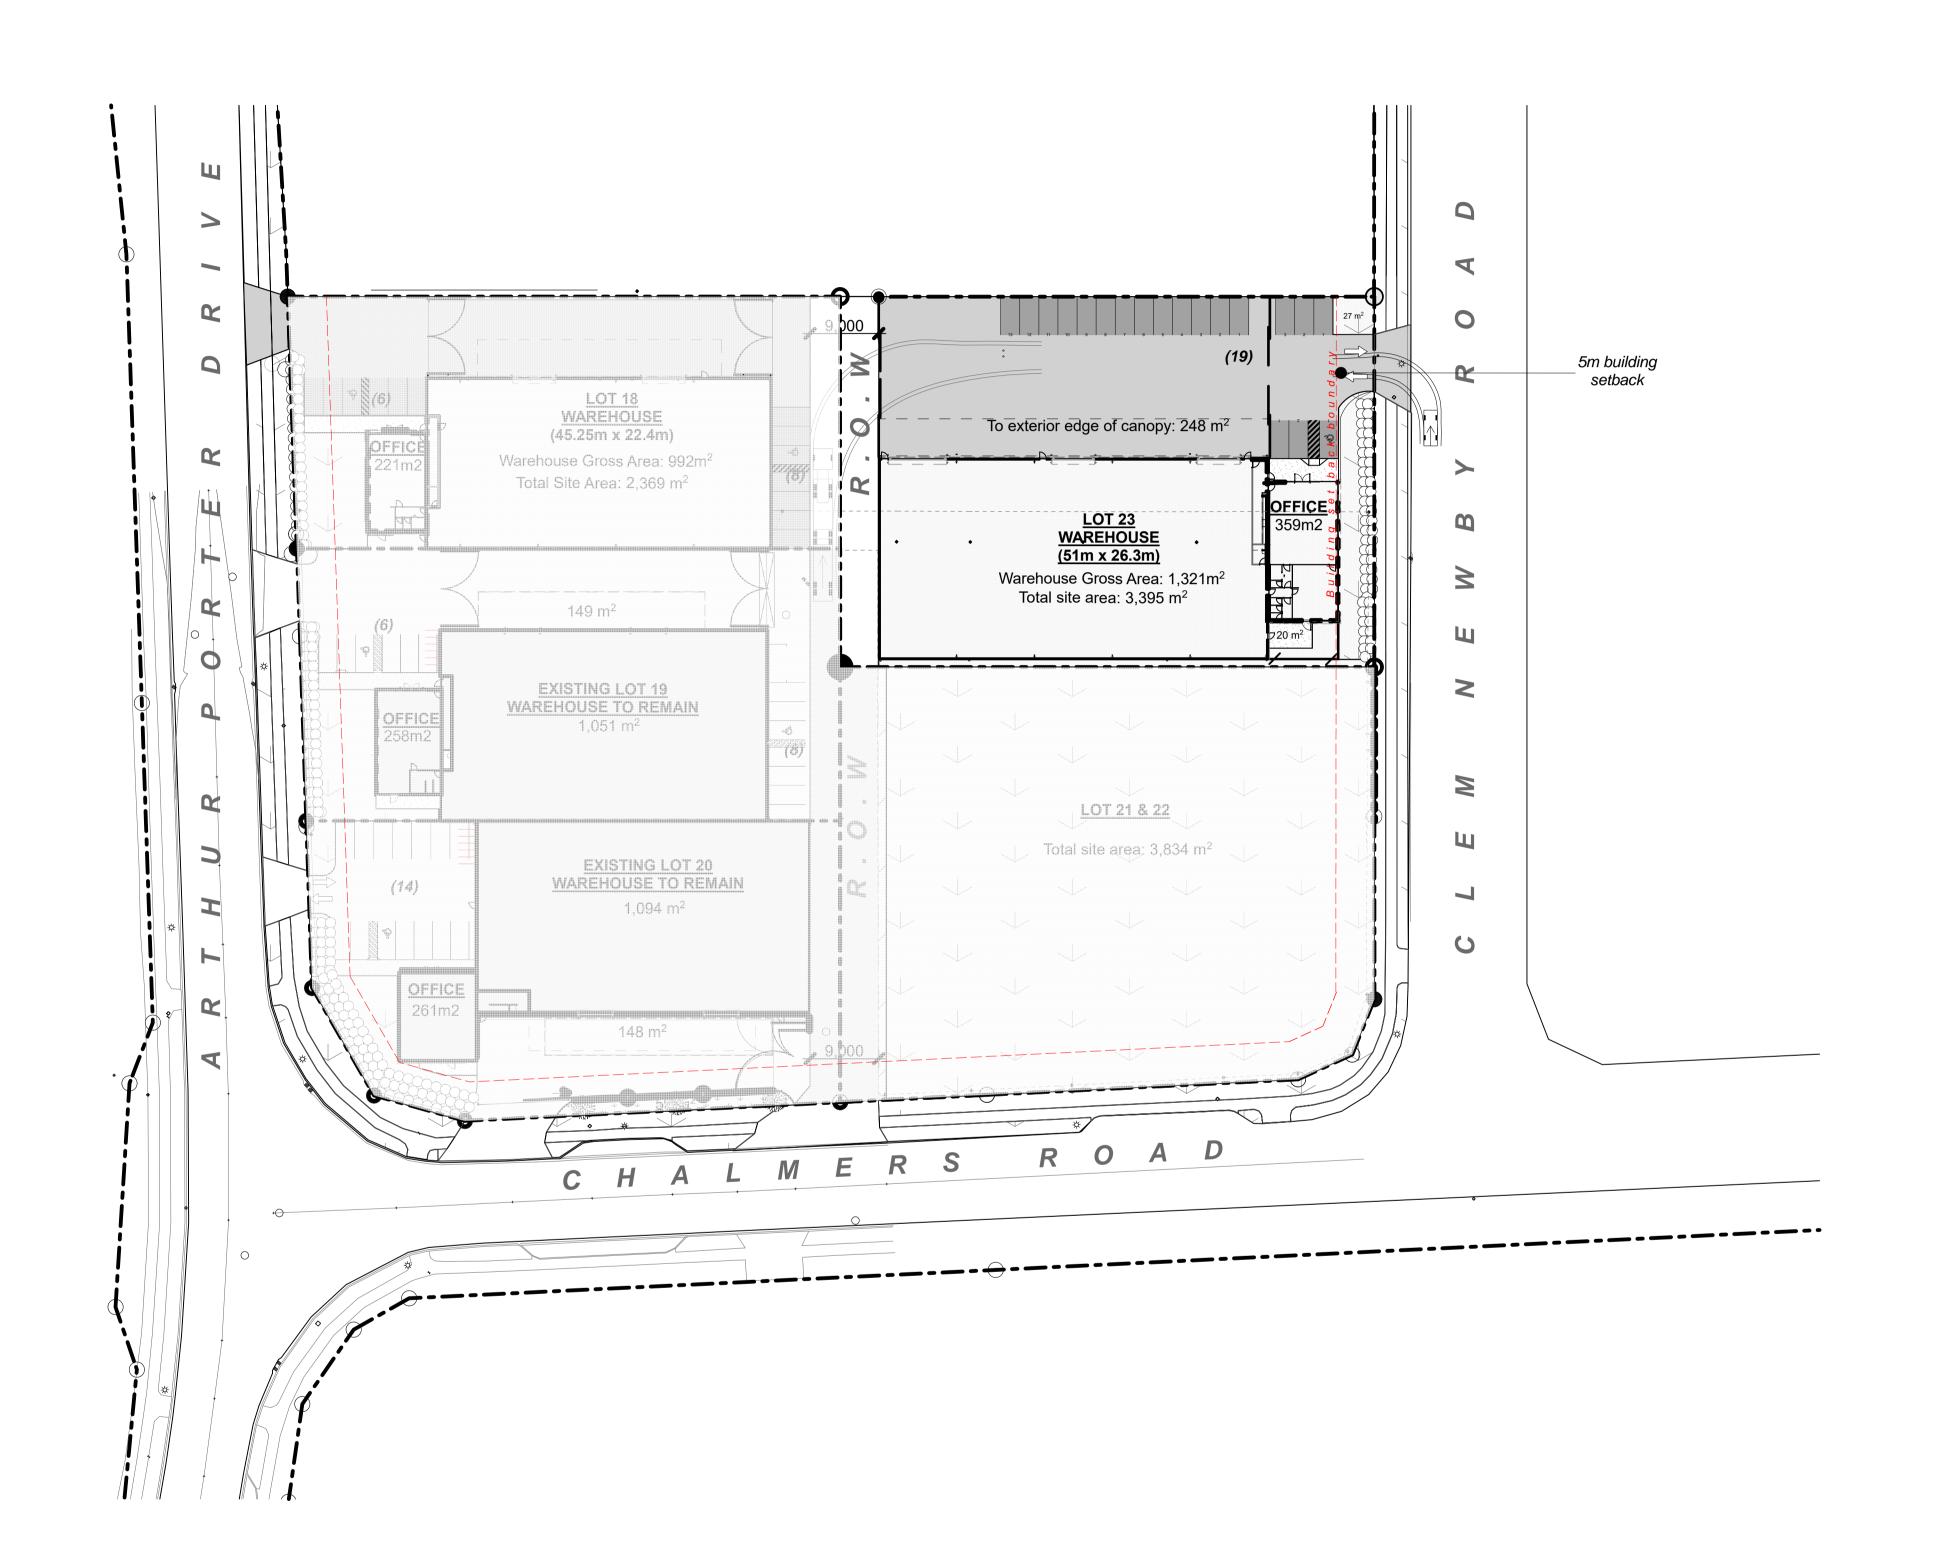

LOT 23

TOTAL SCHEDULE OF AREAS

Site Area Gross	3,395m ²
Warehouse Gross Warehouse Net	1,321m² 1,299m²
Office Gross Office Net	359m² 340m²
Canopy	248m²
Parking	19
Total Built Area Gross Total Built Area Net Warehouse + 2 story office	1,680m² 1,639m²
Total Site Coverage Gross Total Site Coverage Net	49.5% 48.3%


SITE COVERAGE

Site Area:	3,395m ²	
Permeable Area: (20% of entire site= 680m²	211m ²	6.2%
Building Coverage:	1,680m2	49.5%

PARKING REQUIREMENTS

CPD Parking Warehouse Office Accessible Cycle Racks	1 pe 1 pe 1 foi	nts: er 150m² er 40m² r up to 20 carparks er 10 staff
Warehouse Office	1,321m² 359m²	(9 Required) (9 Required)
Total Carpark		19 19

Exposure Zone: Wind Zone: Earthquake Zone:	B High 1
Arthur Porter Drive Northgate Hamilton 3200	
Lots 23 DP ??	

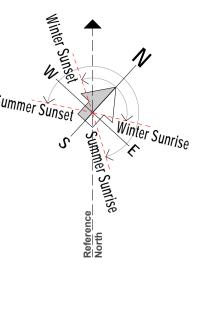

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TE RAPA GATEWAY
WAREHOUSE &
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DEVELOPMENT
LOT 23
(NZ WINDOWS)
HAMILTON JV
INDUSTRIAL PARK

dwg title


Proposed Site Plan


status

DEVELOPED DESIGN

scale
AS SHOWN @ A1



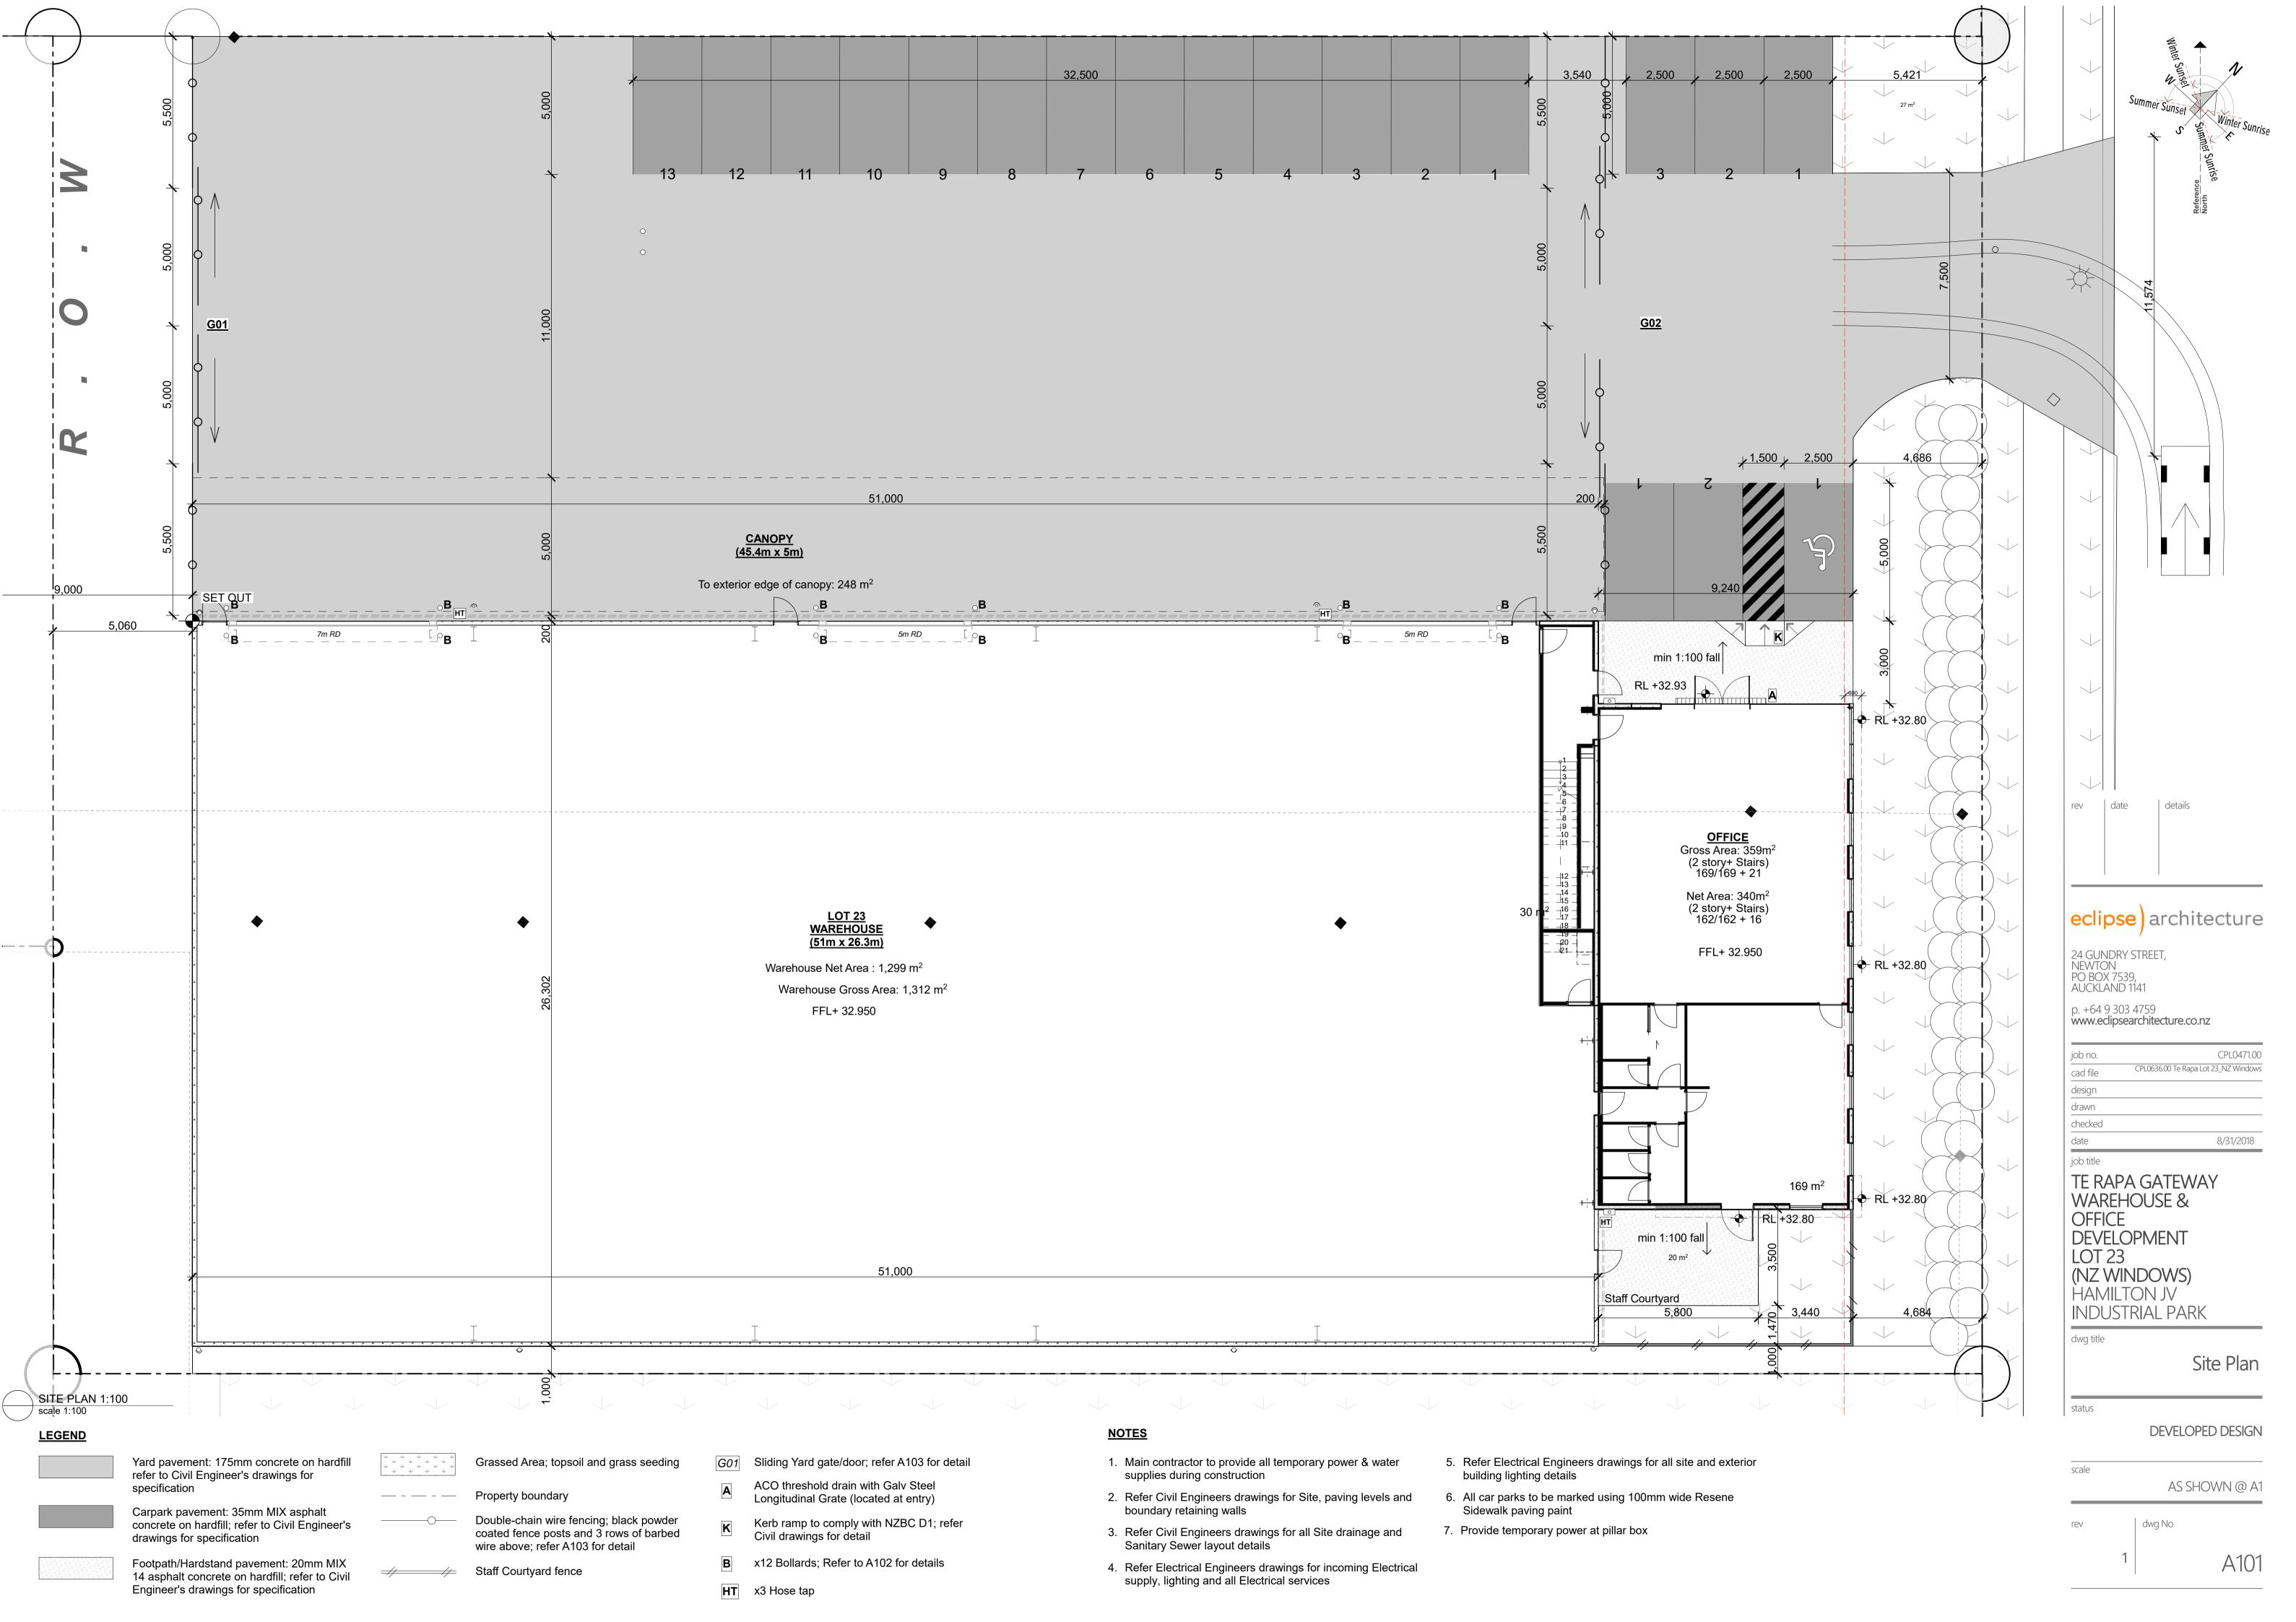

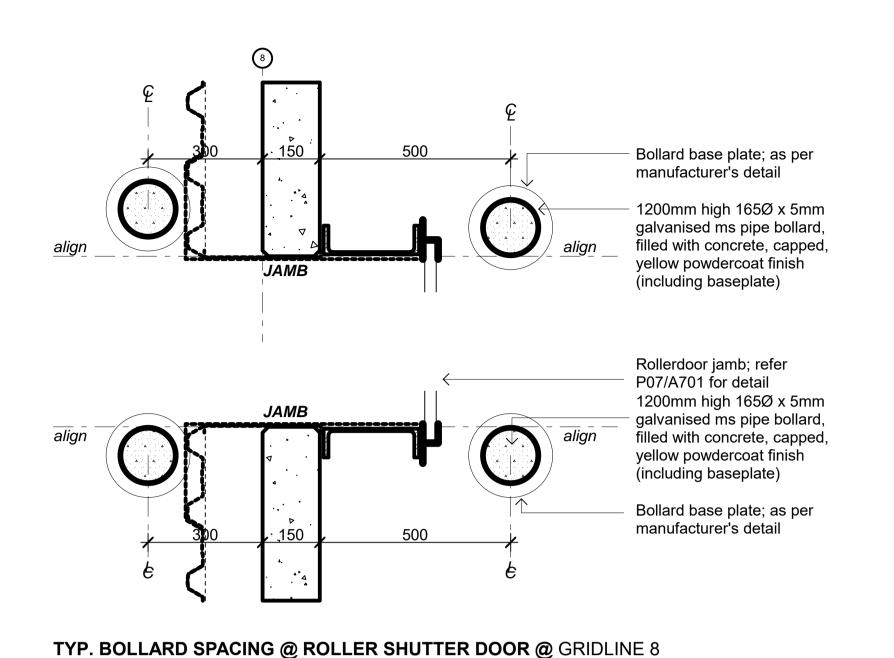


scale 1:10


300 Bollard base plate; as per manufacturer's detail 1200mm high 165Ø x 5mm galvanised ms pipe bollard, filled with concrete, capped, yellow powdercoat finish JAMB (including baseplate) Rollerdoor jamb; refer P06/A701 for detail 1200mm high 165Ø x 5mm galvanised ms pipe bollard, filled with concrete, capped, yellow powdercoat finish (including baseplate) Bollard base plate; as per manufacturer's detail


_{*} 165 _{*} NOTE: - All bollards to be painted - Refer Plans for locations 165Ø x 5mm galvanised ms pipe bollard, filled with concrete, capped, yellow powdervoat finish (including baseplate) Bollard bolted to concrete slab as recommended by manufacturer Concrete paving - refer Civil Engineer's drawings 4 4 4 4

TYP. BOLLARD SPACING @ ROLLER SHUTTER DOOR @ GRIDLINE 1

TYP. BOLLARD ELEVATION @ WAREHOUSE scale 1:10

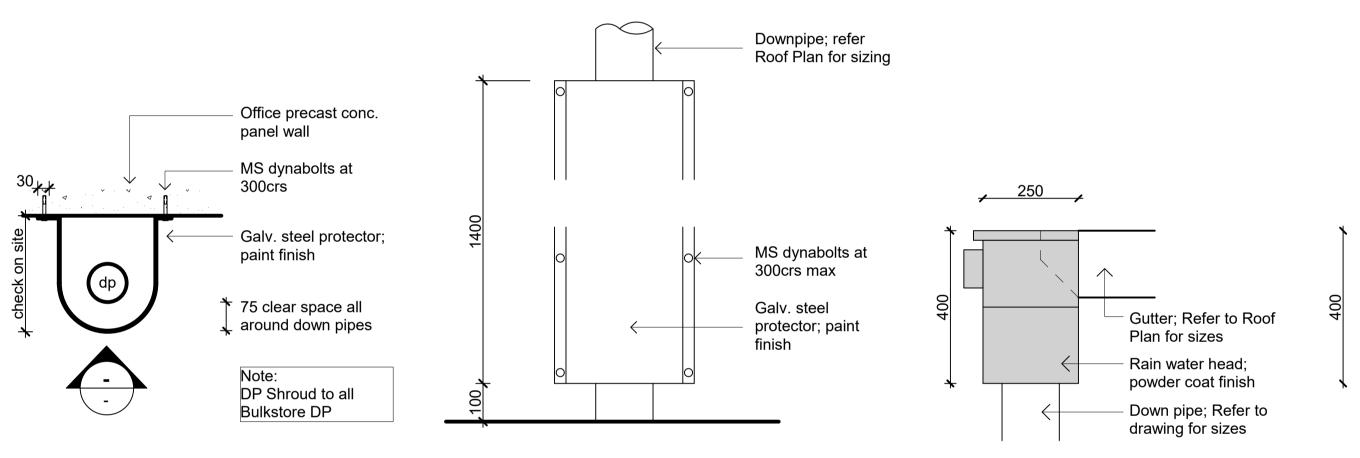

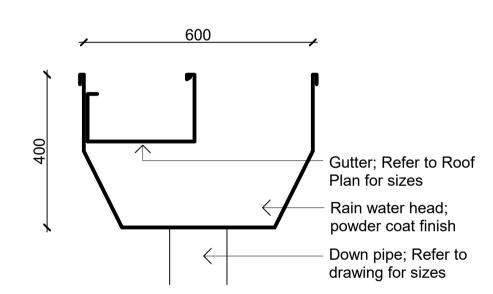

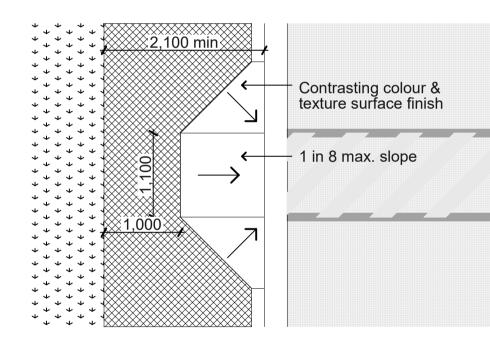


TYP. DOWNPIPE SHROUD PLAN TYP. DOWNPIPE SHROUD ELEVATION scale 1:10 scale 1:10


CALDER STEWART STANDARD RWH #2 **ELEVATION DETAIL** scale 1:10

CALDER STEWART STANDARD RWH #2 SECTION DETAIL scale 1:10

KERB CROSSING DETAIL scale 1:50

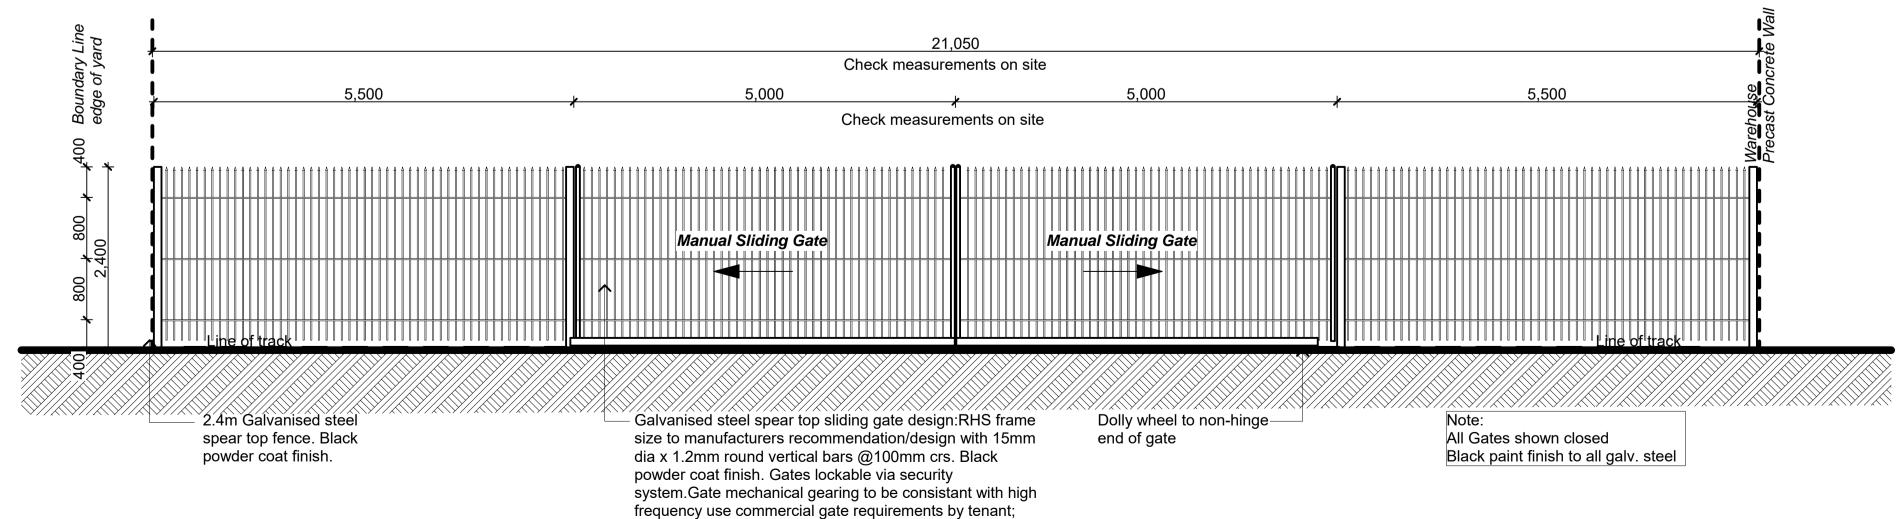

scale 1:10

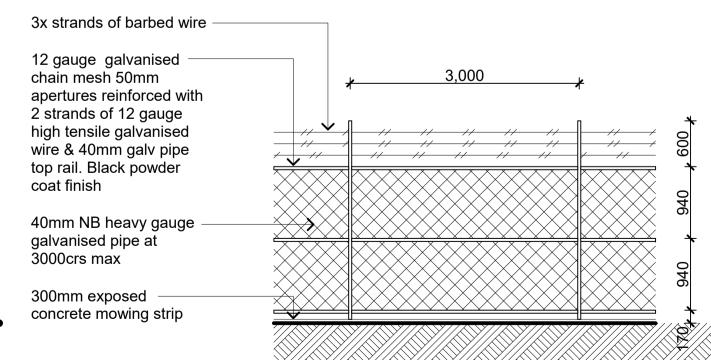

GATE G01 & G02 TYPICAL ELEVATION scale 1:50

TYP. FENCE ELEVATION scale 1:50

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TE RAPA GATEWAY WAREHOUSE & OFFICE DEVELOPMENT LOT 23 (NZ WINDOWS) HAMILTON JV INDUSTRIAL PARK


dwg title

Site Works Details

status **DEVELOPED DESIGN**

scale AS SHOWN @ A1

> dwg No A102

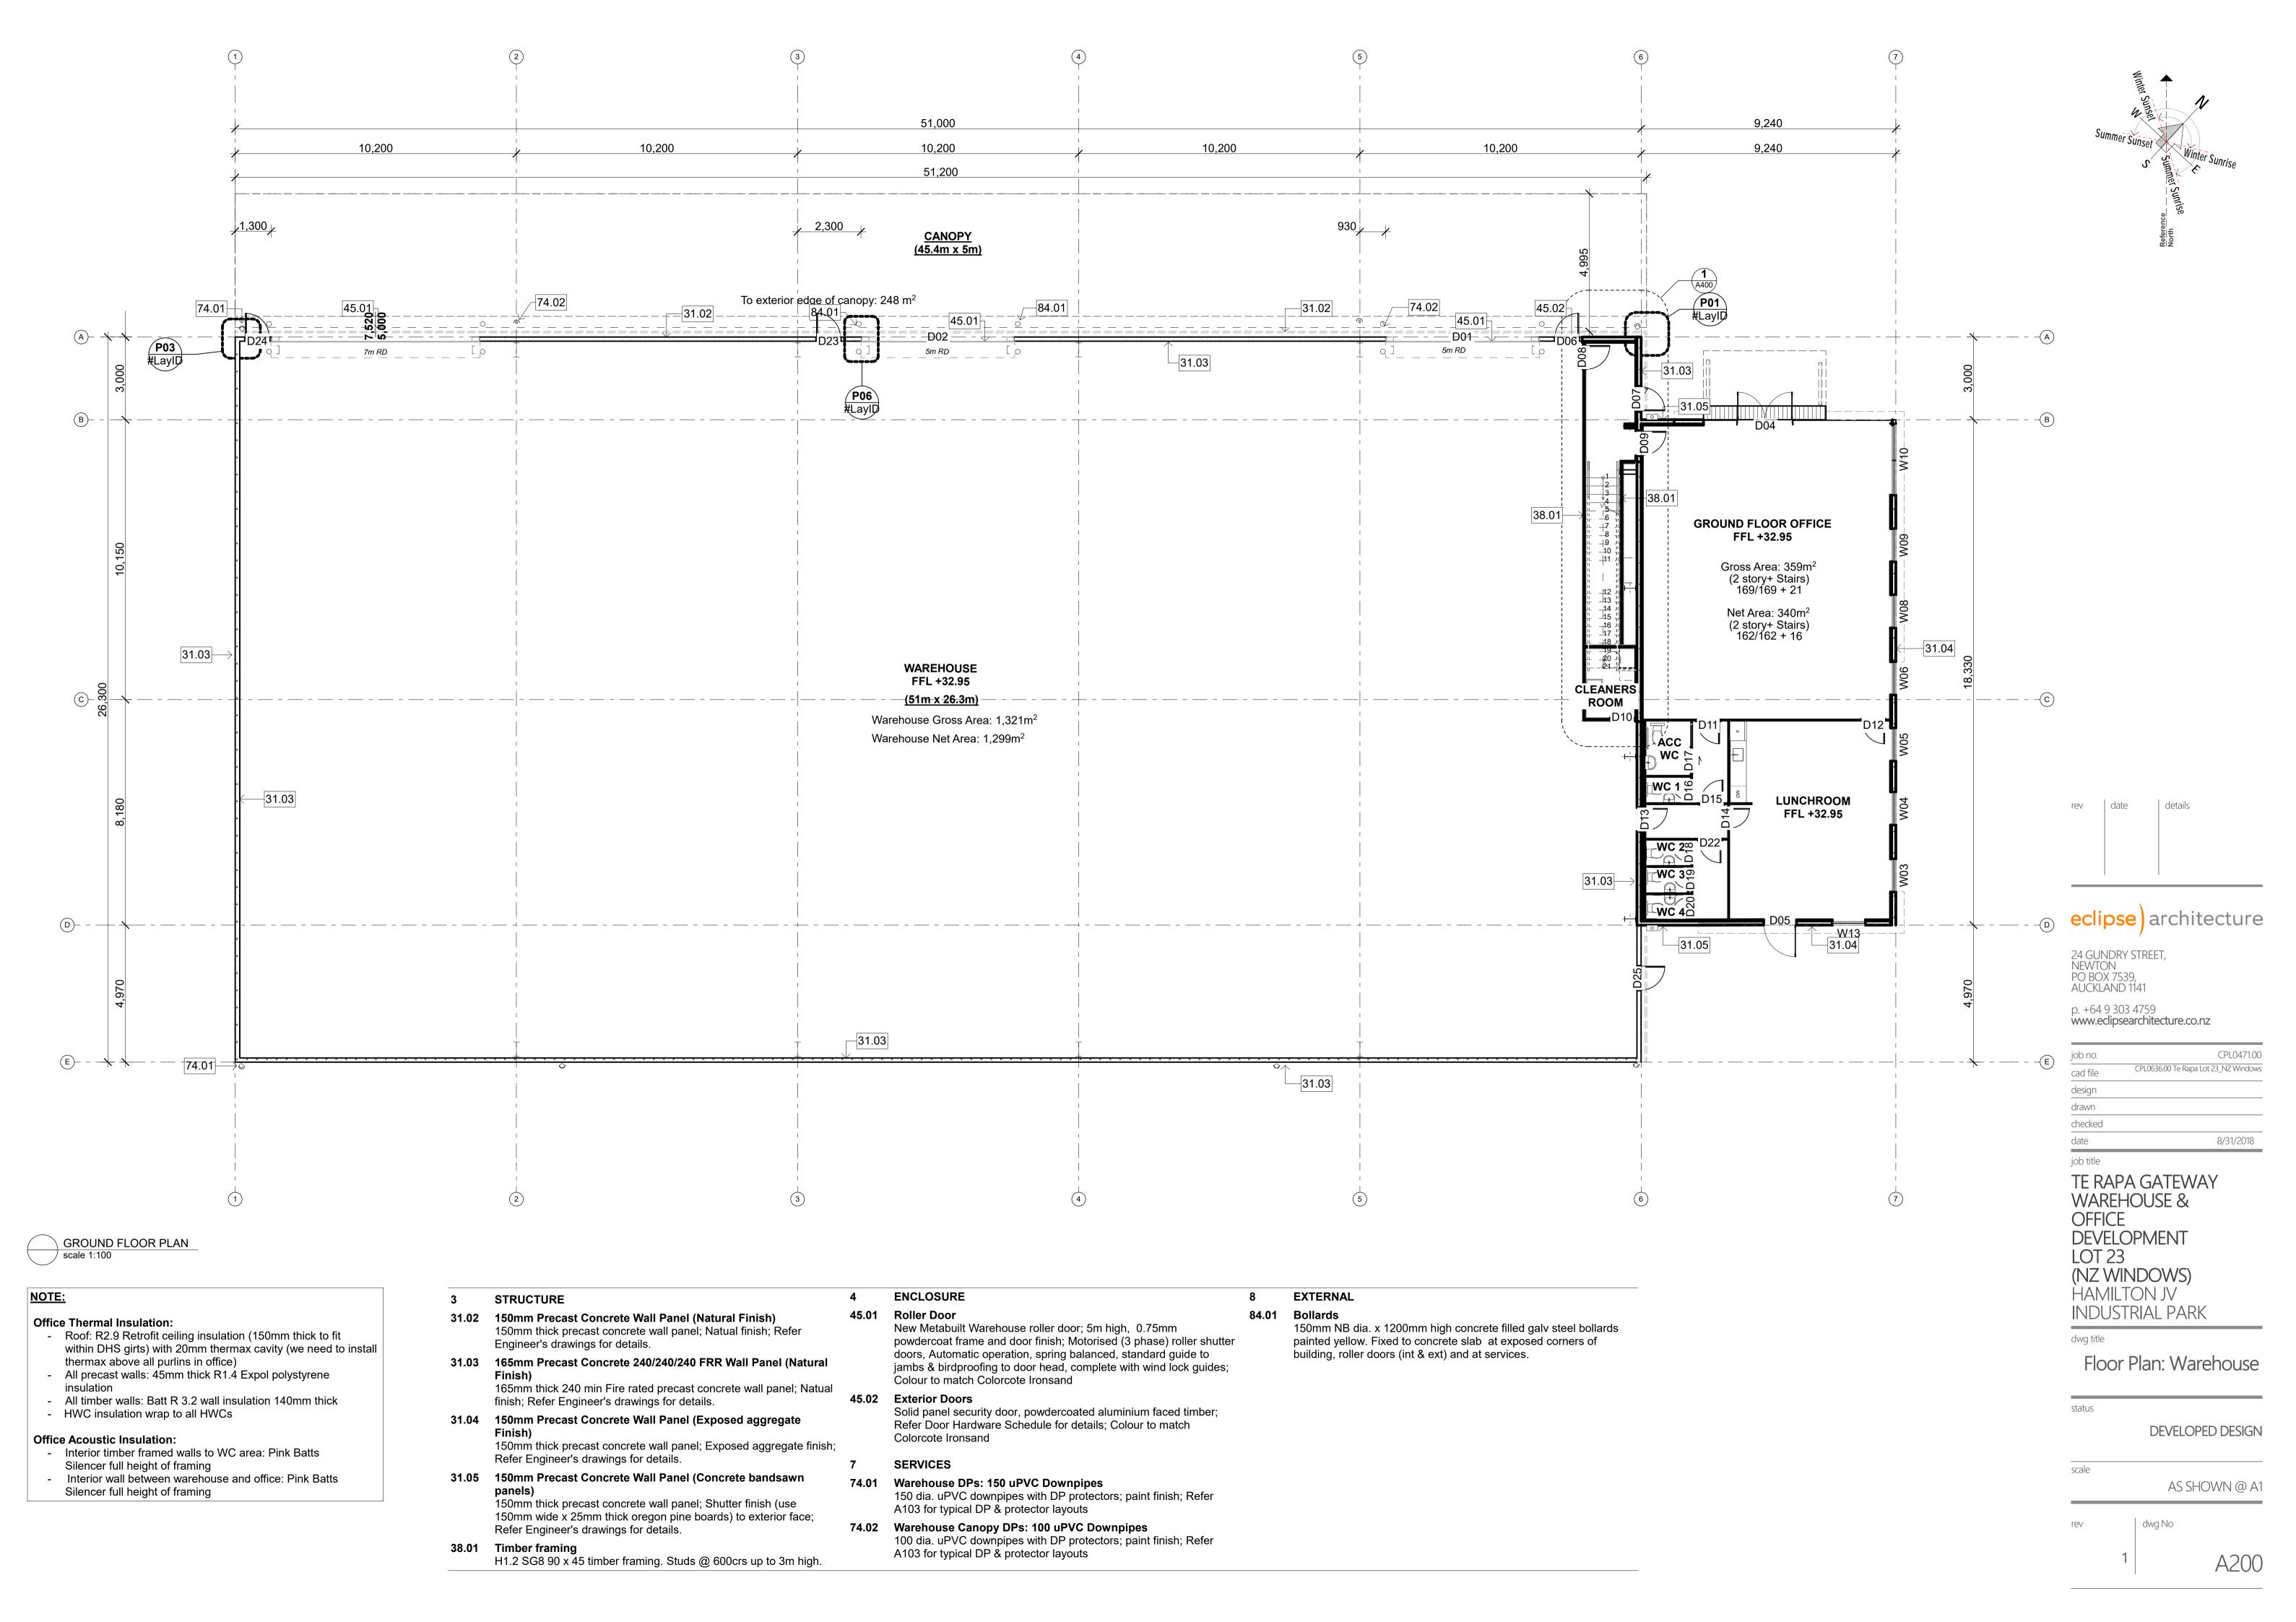

GROUND FLOOR PLAN OFFICE scale 1:50



31.02 150mm Precast Concrete Wall Panel (Natural Finish)
150mm thick precast concrete wall panel; Natual finish; Refer
Engineer's drawings for details.

31.04 150mm Precast Concrete Wall Panel (Exposed aggregate Finish)

150mm thick precast concrete wall panel; Exposed aggregate finish; Refer Engineer's drawings for details.

31.05 150mm Precast Concrete Wall Panel (Concrete bandsawn panels)

150mm thick precast concrete wall panel; Shutter finish (use 150mm wide x 25mm thick oregon pine boards) to exterior face; Refer Engineer's drawings for details.

4 ENCLOSURE

42.06 Office Wall: Profiled Metal Cladding

0.55mm BMT Colorcote ZinaCore Calder Stewart Euro-Tray Double Standing Seam cladding; Colour: Ironsand

45.03 Shopfront glazing

Powdercoated 125mm Front Glazed Firvie Suite aluminium tinted double glazed joinery; Colour to match colorcote Ironsand

INTERIOR

51.01 13mm GIB Standard on timber framing

13mm GIB Standard on 90x45mm timber framing; Level 4 stopped & selaed, paint finish

51.02 13mm GIB Standard on timber strapping on precast wall 13mm GIB Standard on 90x45mm timber strapping on DPC on precast concrete wall; Level 4 stopped & selaed, paint finish. 140mm further strapping to bathroom area.

51.03 13mm GIB Aqualine on timber framing
13mm GIB Aqualine on timber framing; Level 4 stopped & selaed,

paint finish
51.07 GBTL 60 fire rated system (60/60/60)

13mm GIB Fyreline to each side of the frame on 90x45mm timber framing; Level 4 stopped & selaed, paint finish

51.08 R1.4 wall insulation with timber strapping on PC conc wall 45mm thick R1.48 Expol-x polystyrene insulation with timber strapping on PC conc wall

51.09 R3.2 wall insulation on timber framing 140mm thick batt R3.2 on timber framing

51.11 Pink Batts Silencer

Pink Batts Silencer wall acoustic insulation

51.12 16mm Plywood lining16mm Plywood Lining; Polyurethane finish

7 SERVICES

74.03 Office DPs: 100 uPVC Downpipes


100 dia. uPVC downpipes with DP protectors; paint finish; Refer A103 for typical DP & protector layouts

74.14 Channel Drain

ACO threshold drain with Galv Steel Longitudinal Grate (located at entry)

NOTE:

Refer to A402 for lining details of bathroom area

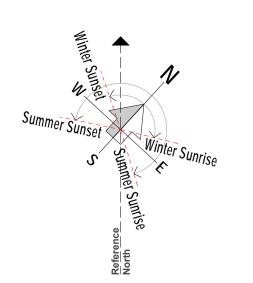

date	details

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TE RAPA GATEWAY
WAREHOUSE &
OFFICE
DEVELOPMENT
LOT 23
(NZ WINDOWS)
HAMILTON JV

INDUSTRIAL PARK

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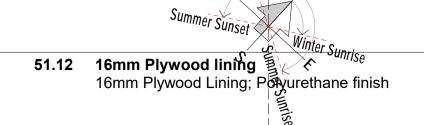
Groud Floor Plan: Office

status

DEVELOPED DESIGN

AS SHOWN @ A1

rev dwg No
1 A201



STRUCTURE

31.02 150mm Precast Concrete Wall Panel (Natural Finish)
150mm thick precast concrete wall panel; Natual finish; Refer
Engineer's drawings for details.

31.04 150mm Precast Concrete Wall Panel (Exposed aggregate Finish)
150mm thick precast concrete wall panel; Exposed aggregate finish; Refer Engineer's drawings for details.

31.05 150mm Precast Concrete Wall Panel (Concrete bandsawn panels)
150mm thick precast concrete wall panel; Shutter finish (use 150mm wide x 25mm thick oregon pine boards) to exterior face;

Refer Engineer's drawings for details.

ENCLOSURE

42.06 Office Wall: Profiled Metal Cladding
0.55mm BMT Colorcote ZinaCore Calder Stewart Euro-Tray Double
Standing Seam cladding; Colour: Ironsand

45.03 Shopfront glazing
Powdercoated 125mm Front Glazed Firvie Suite aluminium tinted double glazed joinery; Colour to match colorcote Ironsand

5 INTERIOR

51.01 13mm GIB Standard on timber framing13mm GIB Standard on 90x45mm timber framing; Level 4 stopped& selaed, paint finish

51.02 13mm GIB Standard on timber strapping on precast wall 13mm GIB Standard on 90x45mm timber strapping on DPC on precast concrete wall; Level 4 stopped & selaed, paint finish. 140mm further strapping to bathroom area.

51.07 GBTL 60 fire rated system (60/60/60)
13mm GIB Fyreline to each side of the frame on 90x45mm timber framing; Level 4 stopped & selaed, paint finish

51.08 R1.4 wall insulation with timber strapping on PC conc wall 45mm thick R1.48 Expol-x polystyrene insulation with timber strapping on PC conc wall

51.09 R3.2 wall insulation on timber framing 140mm thick batt R3.2 on timber framing

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TE RAPA GATEWA
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LOT 23
(NZ WINDOWS)
HAMILTON JV
INDUSTRIAL PARK

dwg title

First Floor Plan: Office


status

DEVELOPED DESIGN

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AS SHOWN @ A1

A202

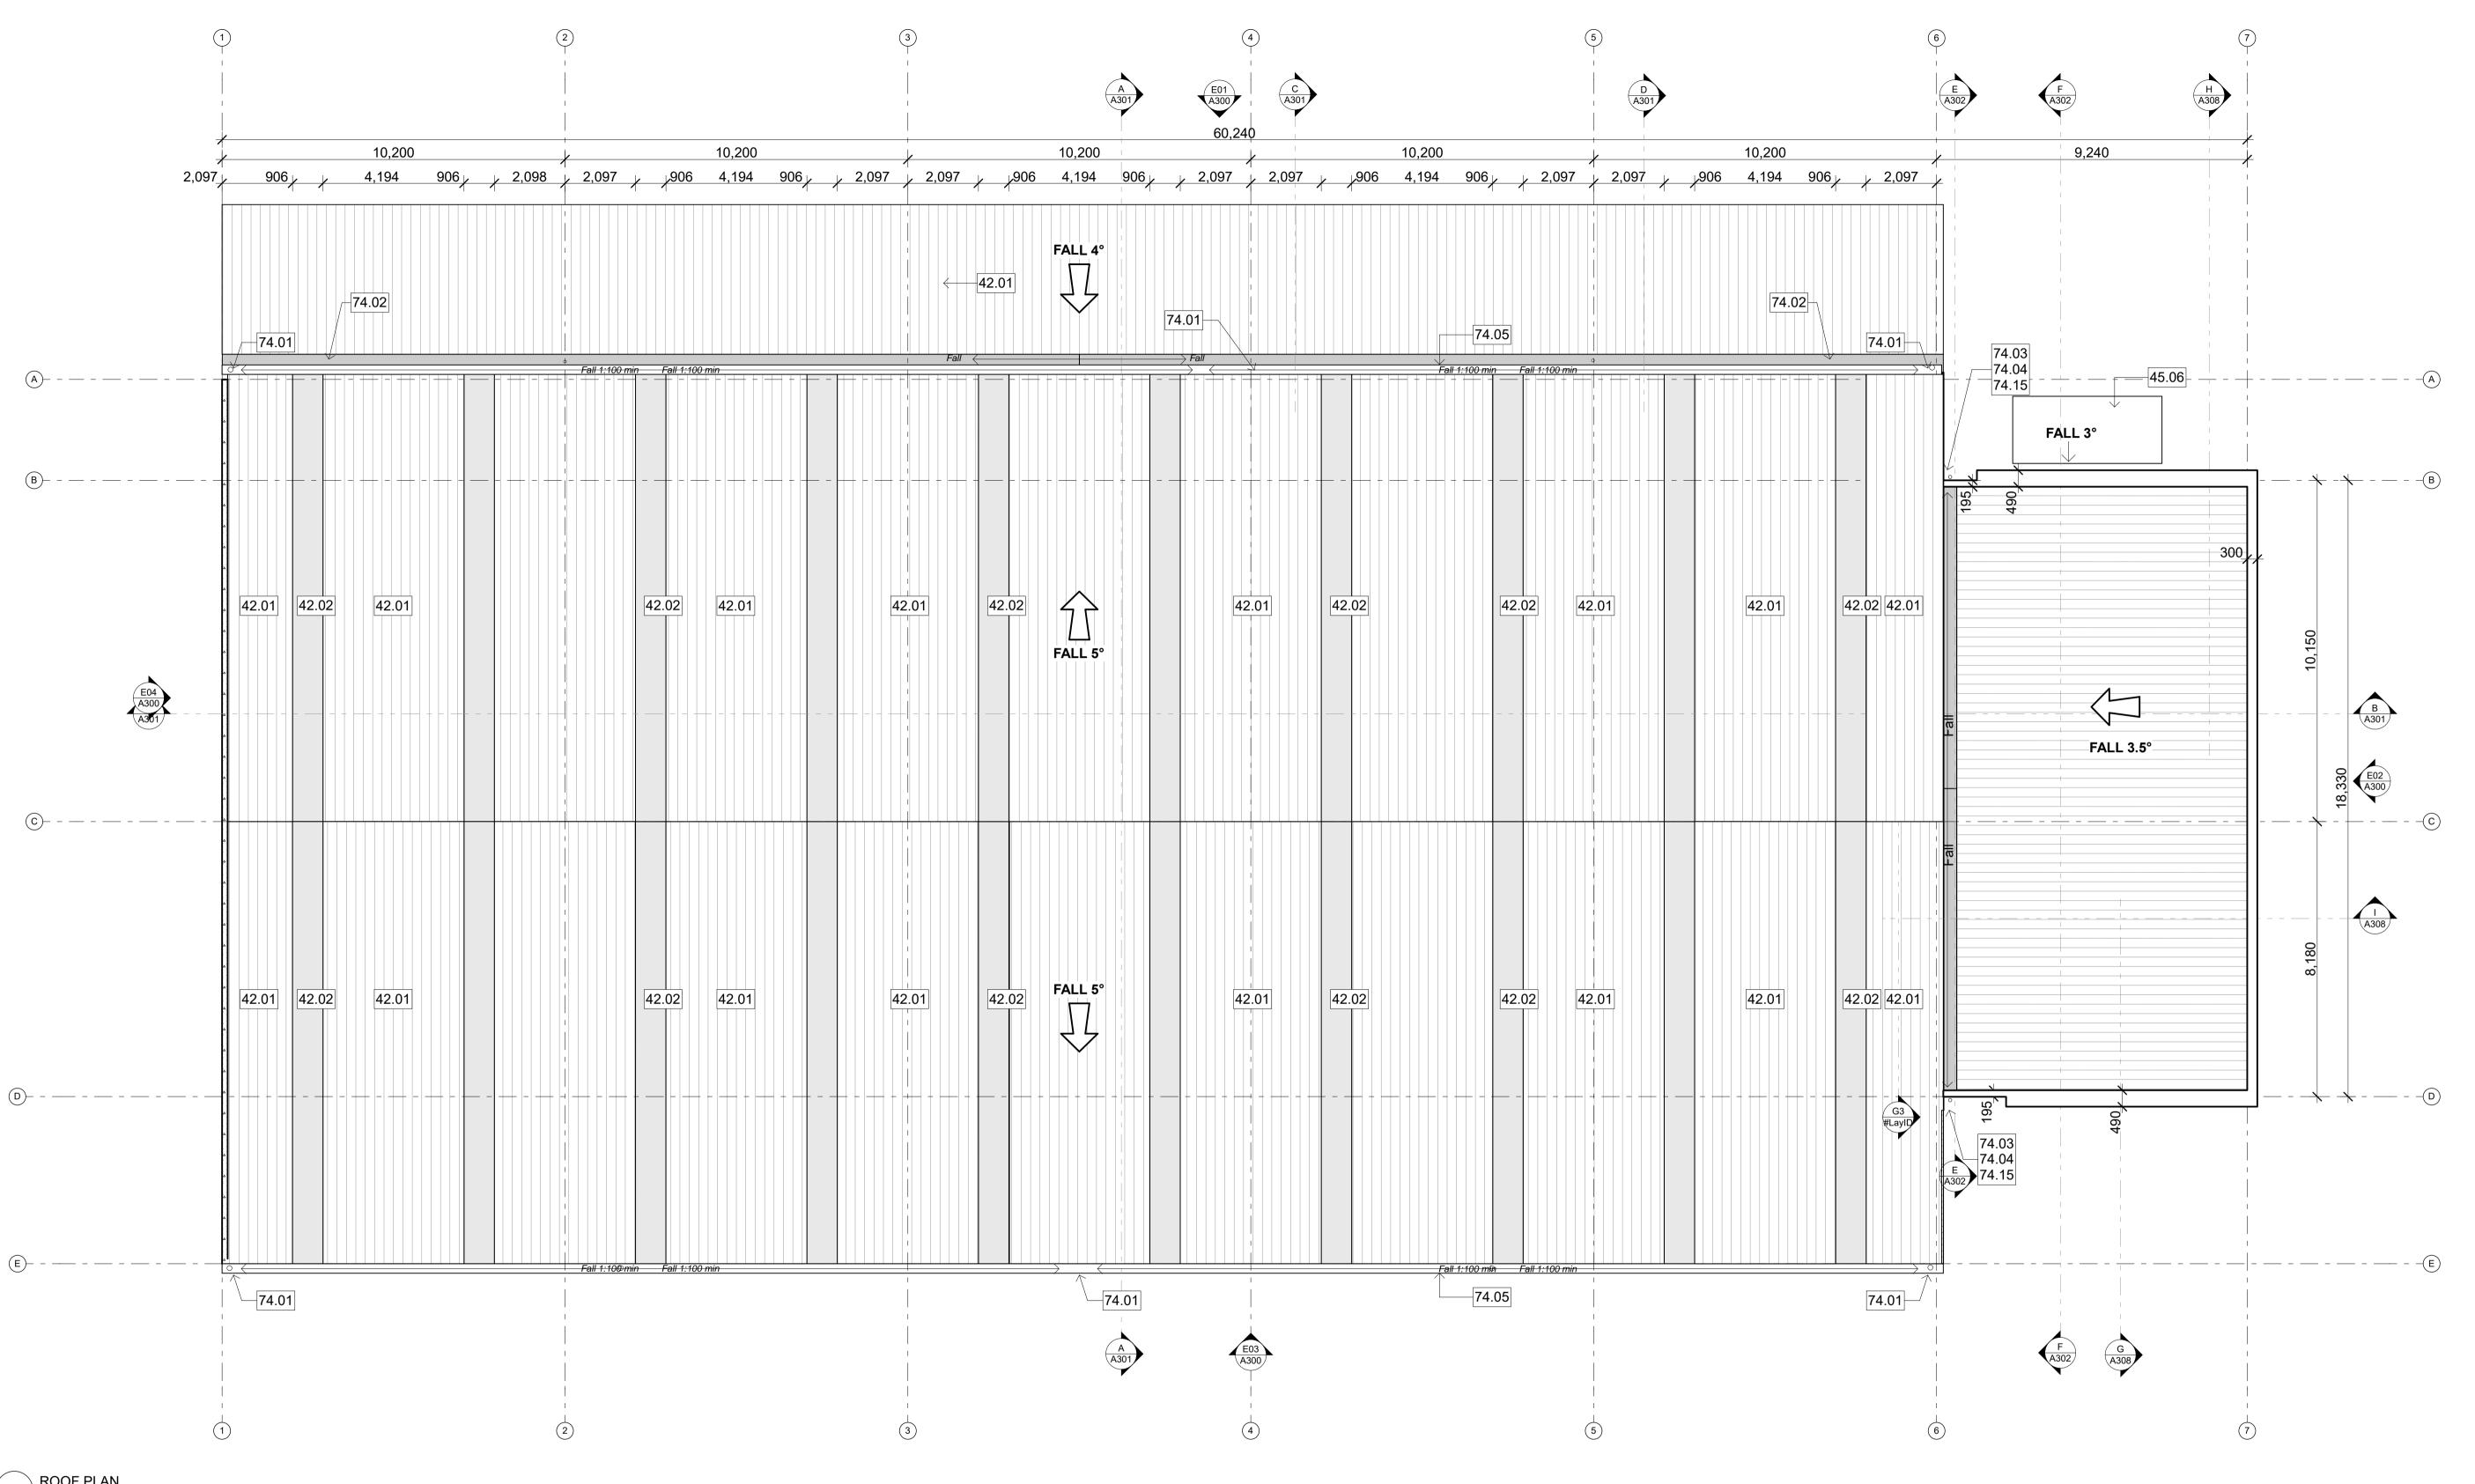

ROOF PLAN scale 1:100

ENCLOSURE

Warehouse Roof: Profiled Metal Roofing 0.55mm BMT Colorcote ZinaCore Calder Stewart Mega 5 metal roofing over building paper over white sisalation and wire netting; Colour: Ironsand

42.02 Warehouse clearlite: Translucent Profiled Roofing Alsynite clearlite roof lights: Topglass GC Hi Line / Topspan (profile

to best match metal roofing profile) 45.06 Office Entry Canopy

Euroglass Canopy Structure

SERVICES

74.01 Warehouse DPs: 150 uPVC Downpipes 150 dia. uPVC downpipes with DP protectors; paint finish; Refer A103 for typical DP & protector layouts

74.02 Warehouse Canopy DPs: 100 uPVC Downpipes 100 dia. uPVC downpipes with DP protectors; paint finish; Refer A103 for typical DP & protector layouts

74.03 Office DPs: 100 uPVC Downpipes

100 dia. uPVC downpipes with DP protectors; paint finish; Refer A103 for typical DP & protector layouts

74.04 Rainwater Head

0.75mm Colorcote ZinaCore RWH Colorcote ZinaCore to match wall cladding colour; Refer to 35/A711 for office RWH details & 36/A711 for warehouse RWH details

74.05 Calder Stewart 300 Box External Gutter Colorcote ZinaCore Calder Stewart 300 Box external gutter with external gutter brackets fixed at 600mm CRS max laid to fall; finish to match gutter

74.15 Scupper

Ardex scupper 10276 (BT 301) 210x85 opening; Refer to 35/A711 &

36/A712 for details

GENERAL

- Drawing to be read in conjunction with plans & elevations for final DP

- Provide Certifix design & build proprietary cable-based Fall Arrest & roof ladder access system to roof to Department of Labour, OSH & NZBC D1/AS1 requirements. Design to include anchor points at regular intervals along Warehouse Ridge line. Yellow paint lines across safe zones / boundary.

- All external Gutters to be Calder Stewart 280 mm Box @1:200 fall

- All internal Gutters @1:100 fall

NOTE: Colorcote Zinacore protective coating to **BOTH** top & underside faces of steel - canopy

NOTE:

-DP Finish: All downpipes to be paint finished -Elevation: Refer A300s for DP elevations -Mechanical Roof Penatration:

flashing detail -Provide design & build proprietary cable-based Fall Arrest system to Warehouse, Canopy and Office

Refer Mechanical drawings for

date

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TE RAPA GATEWAY WAREHOUSE & **OFFICE** DEVELOPMENT LOT 23 (NZ WINDOWS) **HAMILTON JV**


INDUSTRIAL PARK dwg title


Roof Plan


status **DEVELOPED DESIGN**

AS SHOWN @ A1



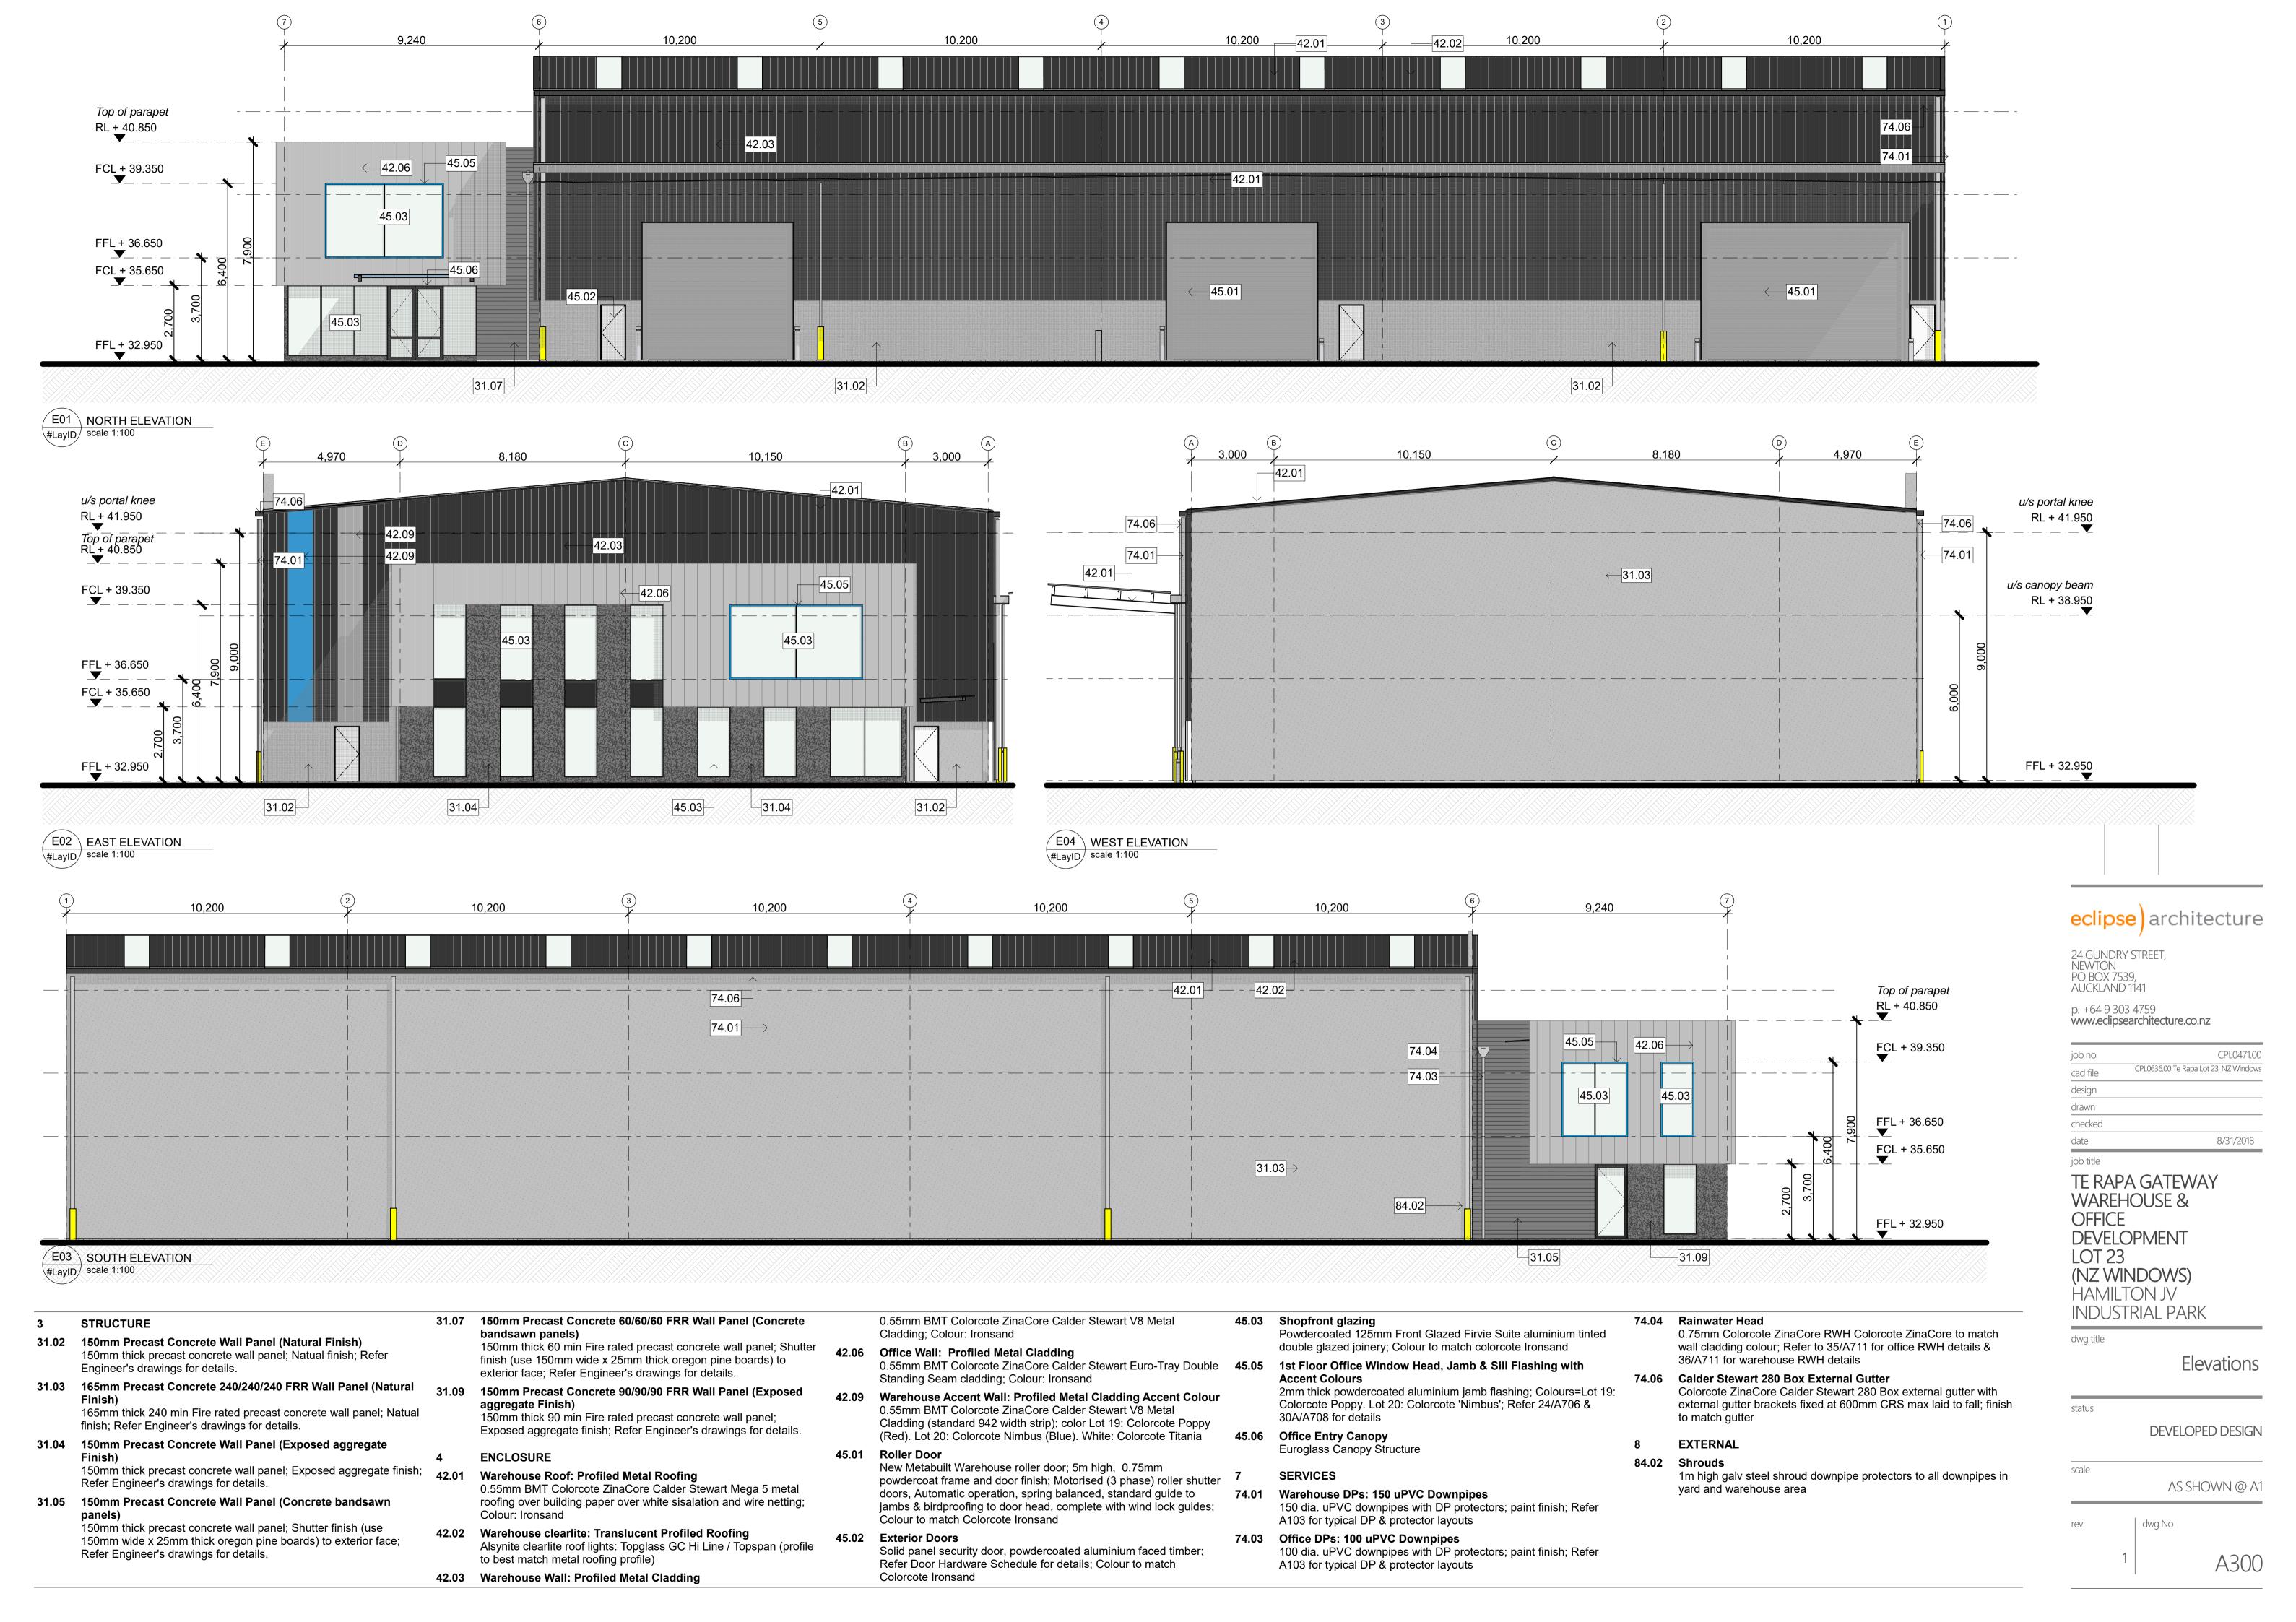

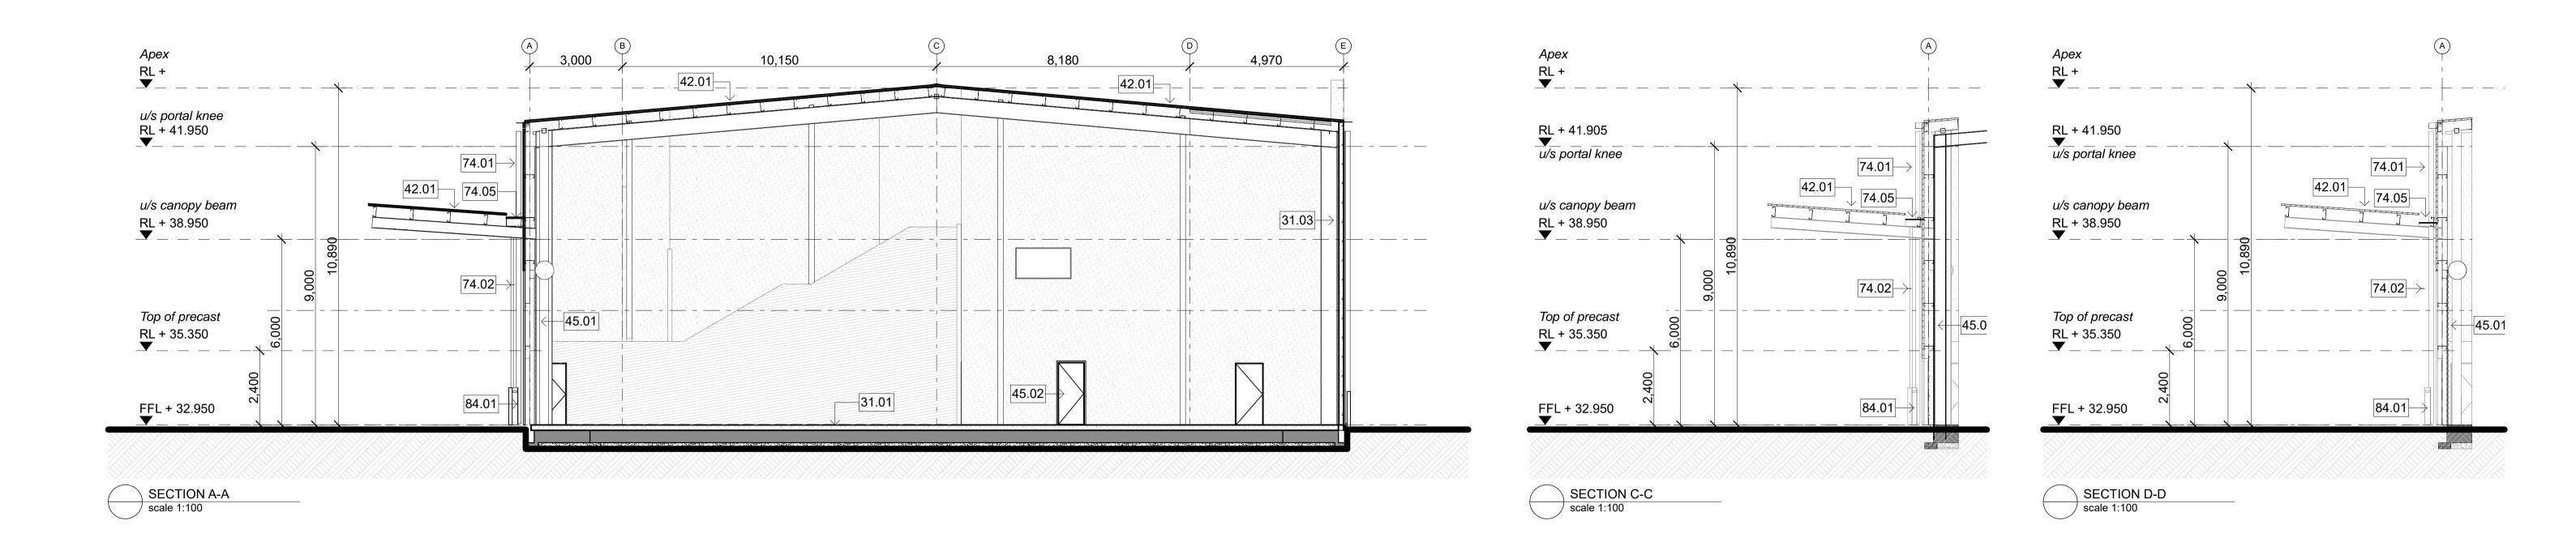

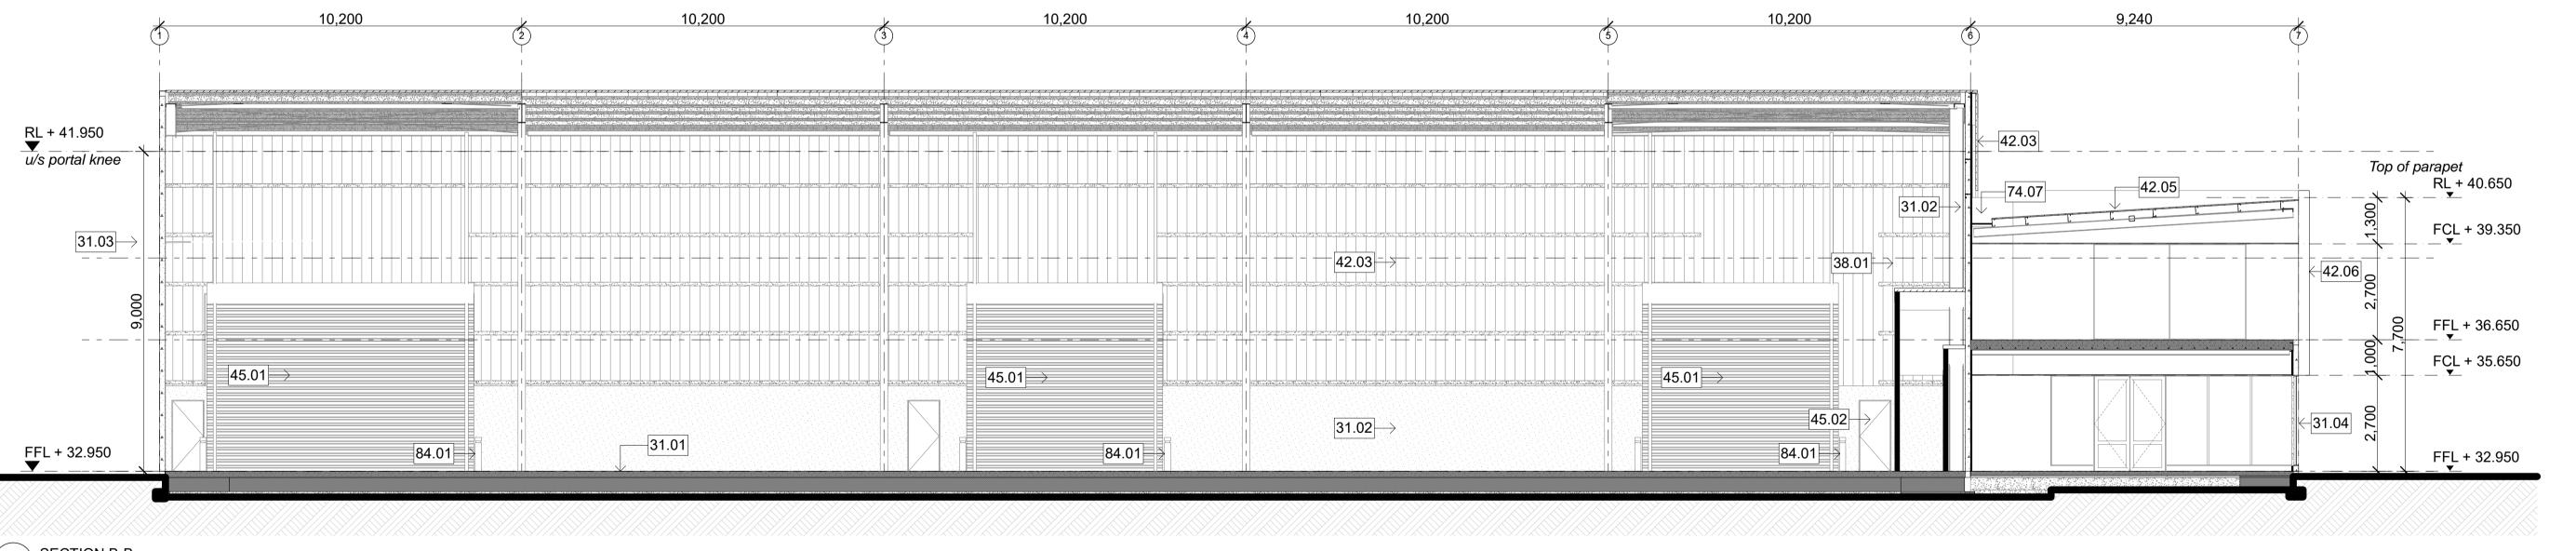

SECTION B-B scale 1:100 **ENCLOSURE** 74.07 Membrane Gutter doors, Automatic operation, spring balanced, standard guide to STRUCTURE 1.5mm Butynol rubber membrane gutter on 19mm H3.2 Plywood on timber framing @ 400crs max; 1:100 min fall jambs & birdproofing to door head, complete with wind lock guides; 42.01 Warehouse Roof: Profiled Metal Roofing 31.01 Concrete Slab Colour to match Colorcote Ironsand 0.55mm BMT Colorcote ZinaCore Calder Stewart Mega 5 metal Concrete floor slab on DPC on sand blinding on metal; Refer roofing over building paper over white sisalation and wire netting; 45.02 **Exterior Doors** Engineer's draw ings for details. **EXTERNAL** Colour: Ironsand Solid panel security door, powdercoated aluminium faced timber; 31.02 150mm Precast Concrete Wall Panel (Natural Finish) Refer Door Hardware Schedule for details; Colour to match 84.01 **Bollards 42.03** Warehouse Wall: Profiled Metal Cladding
0.55mm BMT Colorcote ZinaCore Calder Stewart V8 Metal 150mm thick precast concrete wall panel; Natual finish; Refer Colorcote Ironsand 150mm NB dia. x 1200mm high concrete filled galv steel bollards Engineer's drawings for details. painted yellow. Fixed to concrete slab at exposed corners of Cladding; Colour: Ironsand 31.03 165mm Precast Concrete 240/240/240 FRR Wall Panel (Natural **SERVICES** building, roller doors (int & ext) and at services. Office Roof: Profiled Metal Roofing 74.01 Warehouse DPs: 150 uPVC Downpipes 0.55mm BMT Colorcote ZinaCore Calder Stewart Hi Five metal 165mm thick 240 min Fire rated precast concrete wall panel; Natual 150 dia. uPVC downpipes with DP protectors; paint finish; Refer roofing over building paper over white sizalation and wire netting; finish; Refer Engineer's drawings for details. A103 for typical DP & protector layouts Colour: Ironsand 31.04 150mm Precast Concrete Wall Panel (Exposed aggregate 74.02 Warehouse Canopy DPs: 100 uPVC Downpipes 42.06 Office Wall: Profiled Metal Cladding Finish) 100 dia. uPVC downpipes with DP protectors; paint finish; Refer 0.55mm BMT Colorcote ZinaCore Calder Stewart Euro-Tray Double 150mm thick precast concrete wall panel; Exposed aggregate finish; A103 for typical DP & protector layouts Standing Seam cladding; Colour: Ironsand Refer Engineer's drawings for details. 74.05 Calder Stewart 300 Box External Gutter 45.01 Roller Door 38.01 Timber framing Colorcote ZinaCore Calder Stewart 300 Box external gutter with New Metabuilt Warehouse roller door; 5m high, 0.75mm H1.2 SG8 90 x 45 timber framing. Studs @ 600crs up to 3m high. external gutter brackets fixed at 600mm CRS max laid to fall; finish powdercoat frame and door finish; Motorised (3 phase) roller shutter to match gutter

date details

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TE RAPA GATEWAY
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LOT 23
(NZ WINDOWS)
HAMILTON JV
INDUSTRIAL PARK

dwg title


Sections: Warehouse


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DEVELOPED DESIGN

scale
AS SHOWN @ A1

1 dwg No A301



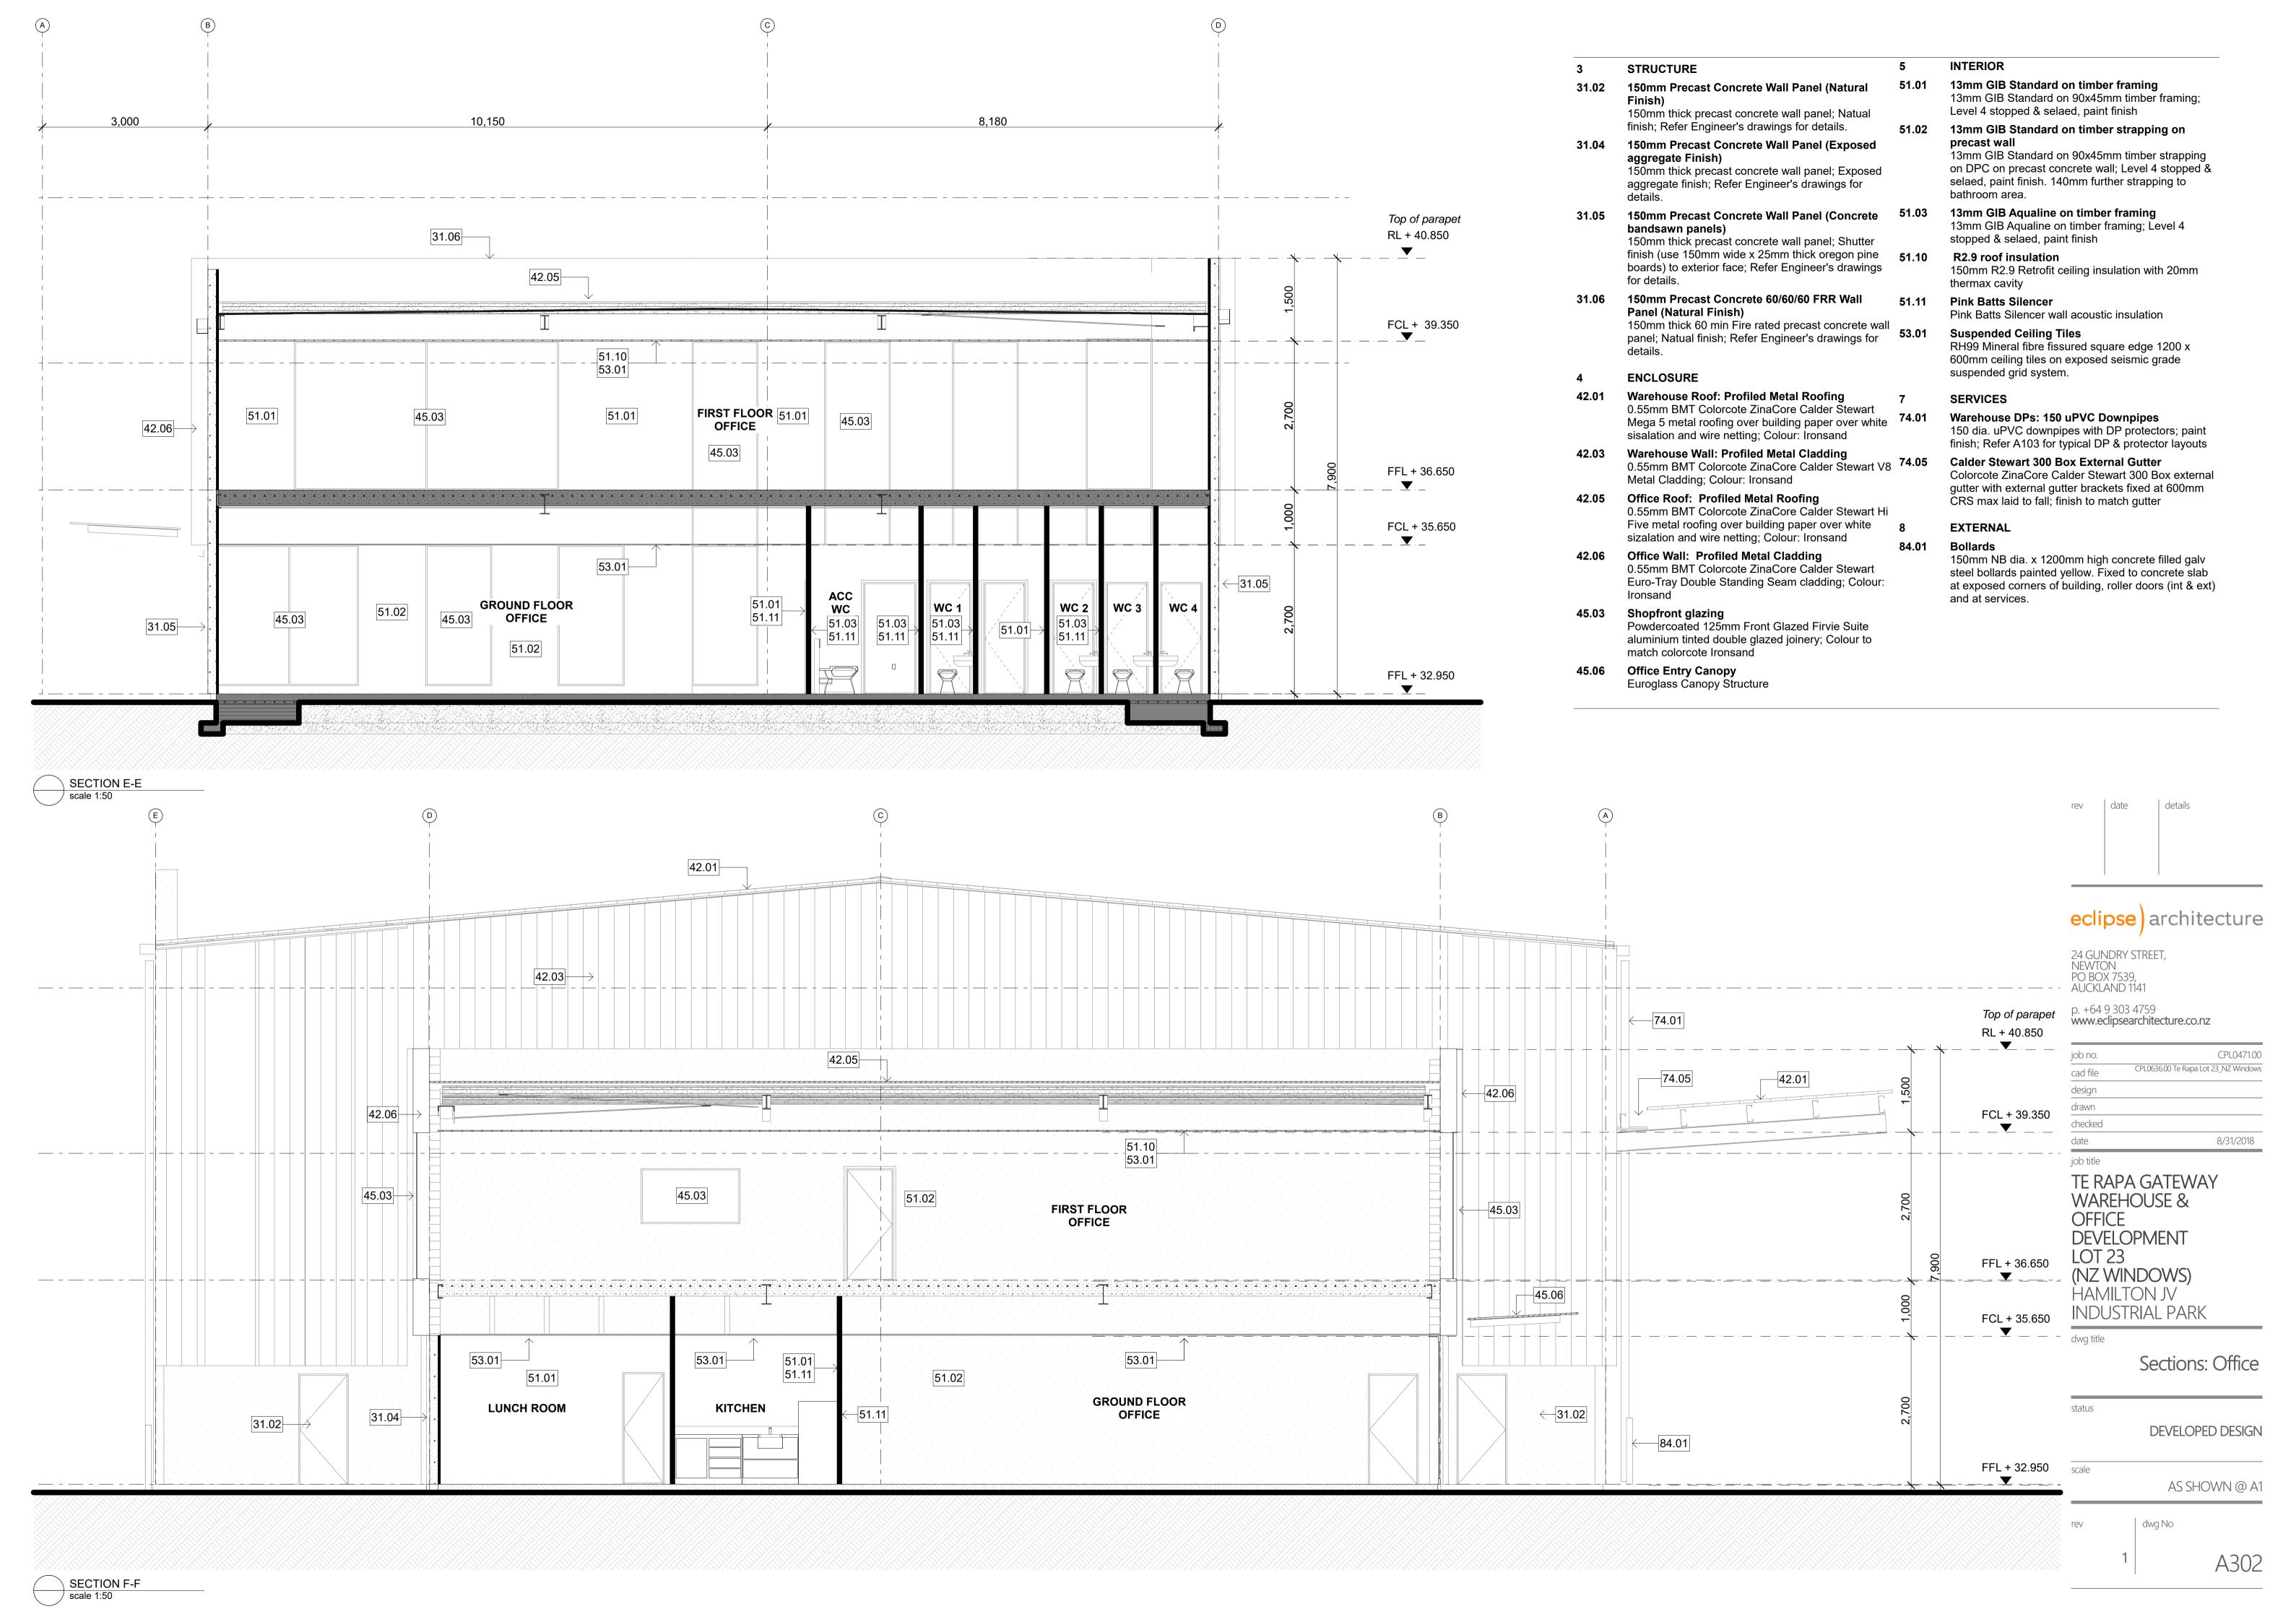

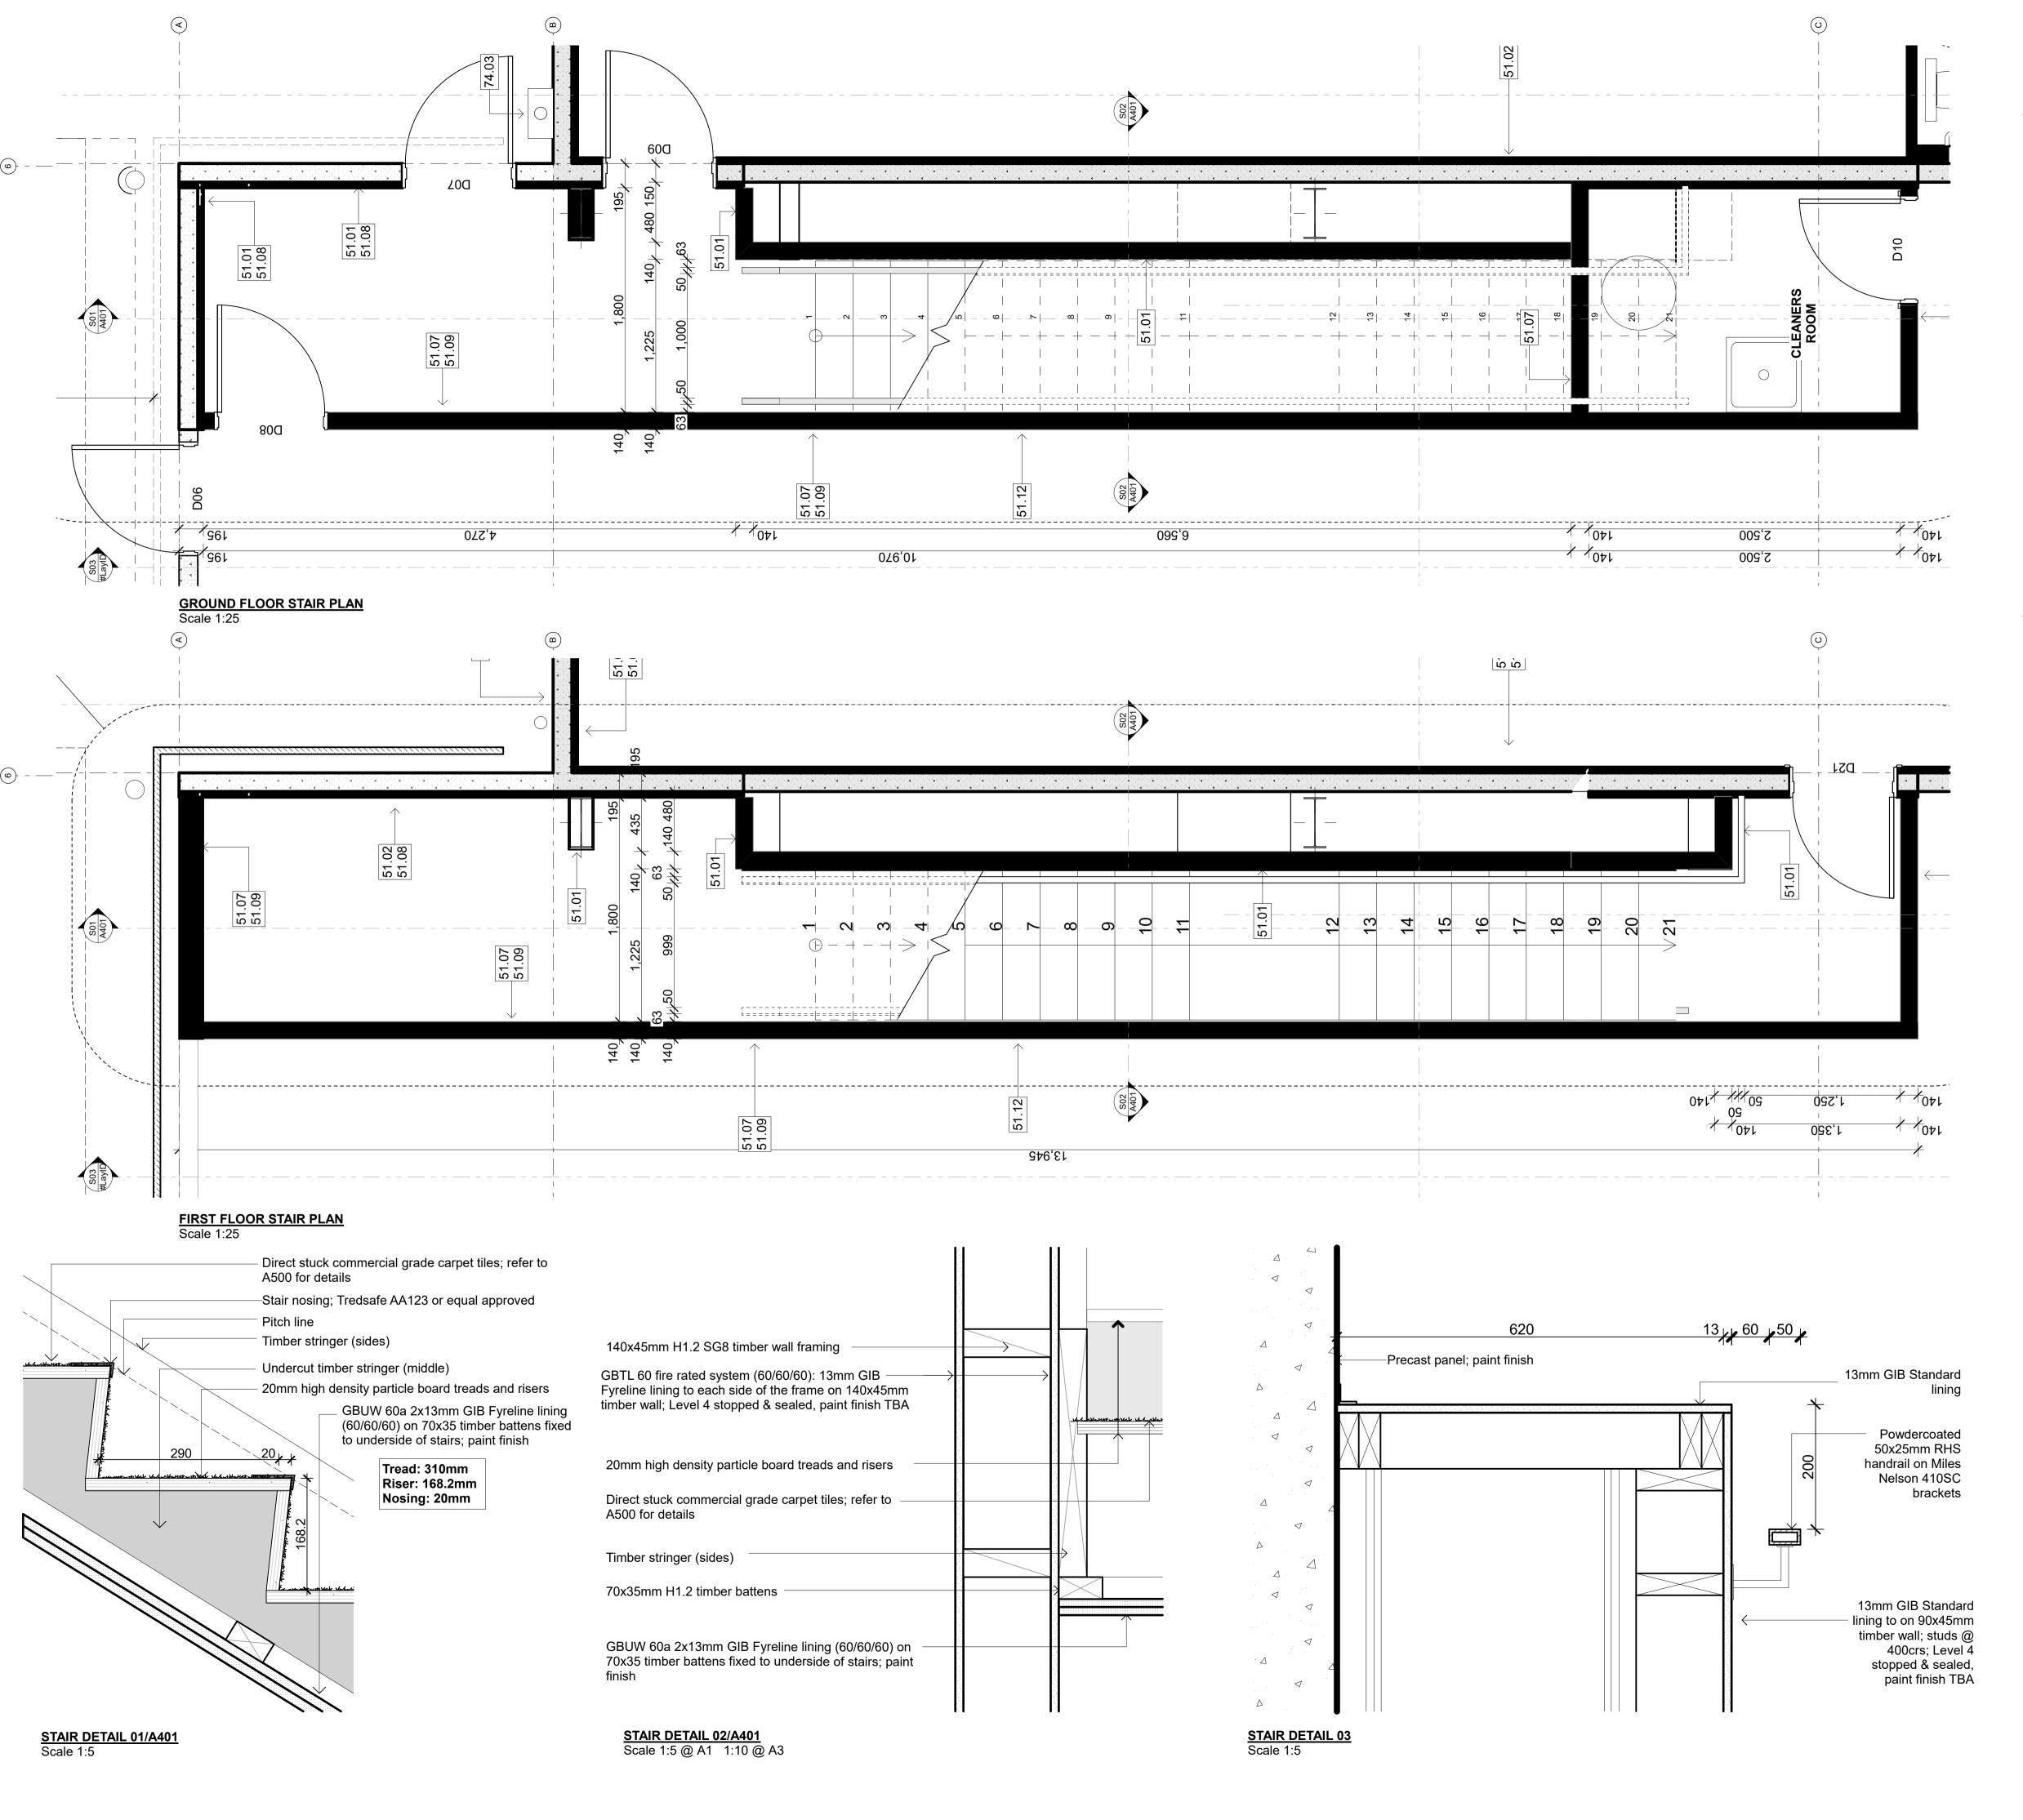3 STRUCTURE

31.05 150mm Precast Concrete Wall Panel (Concrete bandsawn panels)

150mm thick precast concrete wall panel; Shutter finish (use 150mm wide x 25mm thick oregon pine boards) to exterior face; Refer Engineer's drawings for details.

INTERIOR

51.01 13mm GIB Standard on timber framing

13mm GIB Standard on 90x45mm timber framing; Level 4 stopped & selaed, paint finish

51.02 13mm GIB Standard on timber strapping on precast wall 13mm GIB Standard on 90x45mm timber strapping on DPC on precast concrete wall; Level 4 stopped & selaed, paint finish. 140mm further strapping to bathroom area.

51.07 GBTL 60 fire rated system (60/60/60)

13mm GIB Fyreline to each side of the frame on 90x45mm timber framing; Level 4 stopped & selaed, paint finish

51.08 R1.4 wall insulation with timber strapping on PC conc wall 45mm thick R1.48 Expol-x polystyrene insulation with timber strapping on PC conc wall

51.09 R3.2 wall insulation on timber framing 140mm thick batt R3.2 on timber framing

51.12 16mm Plywood lining 16mm Plywood Lining; Polyurethane finish

SERVICES

74.03 Office DPs: 100 uPVC Downpipes

100 dia. uPVC downpipes with DP protectors; paint finish; Refer A103 for typical DP & protector layouts



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TE RAPA GATEWAY
WAREHOUSE &
OFFICE
DEVELOPMENT
LOT 23
(NZ WINDOWS)
HAMILTON JV
INDUSTRIAL PARK

dwg title


Stairs

status

DEVELOPED DESIGN

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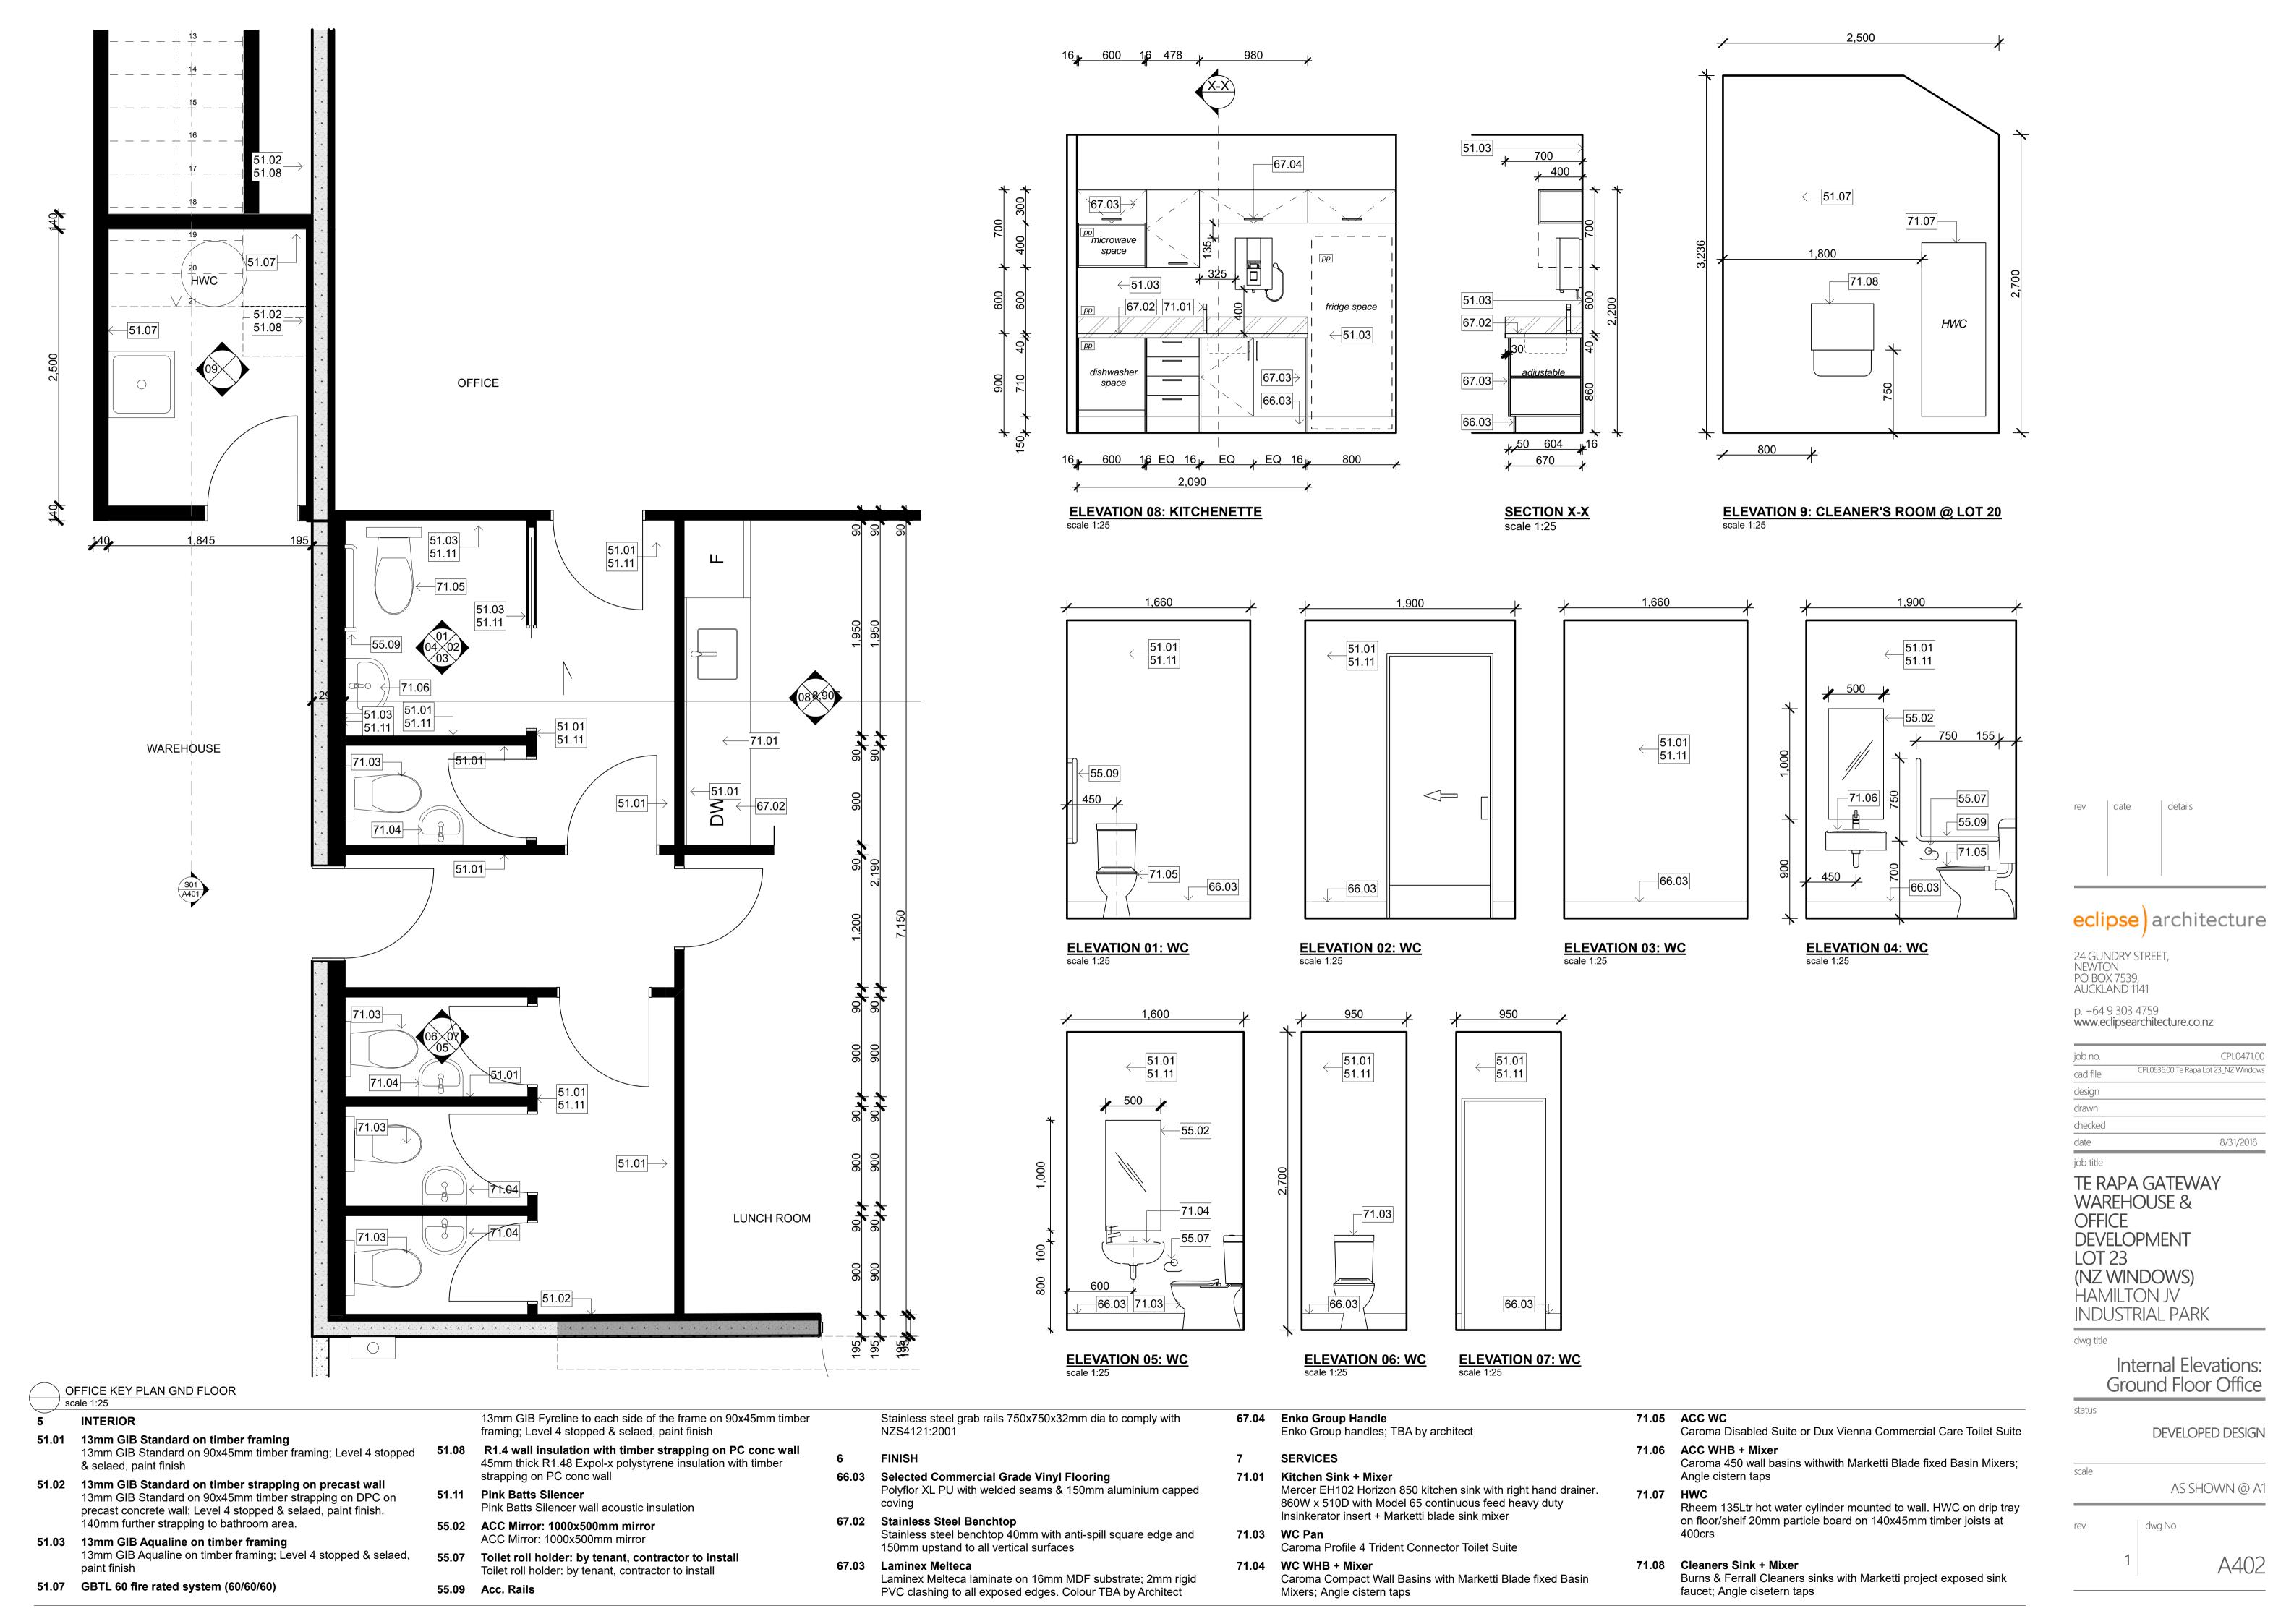
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A401

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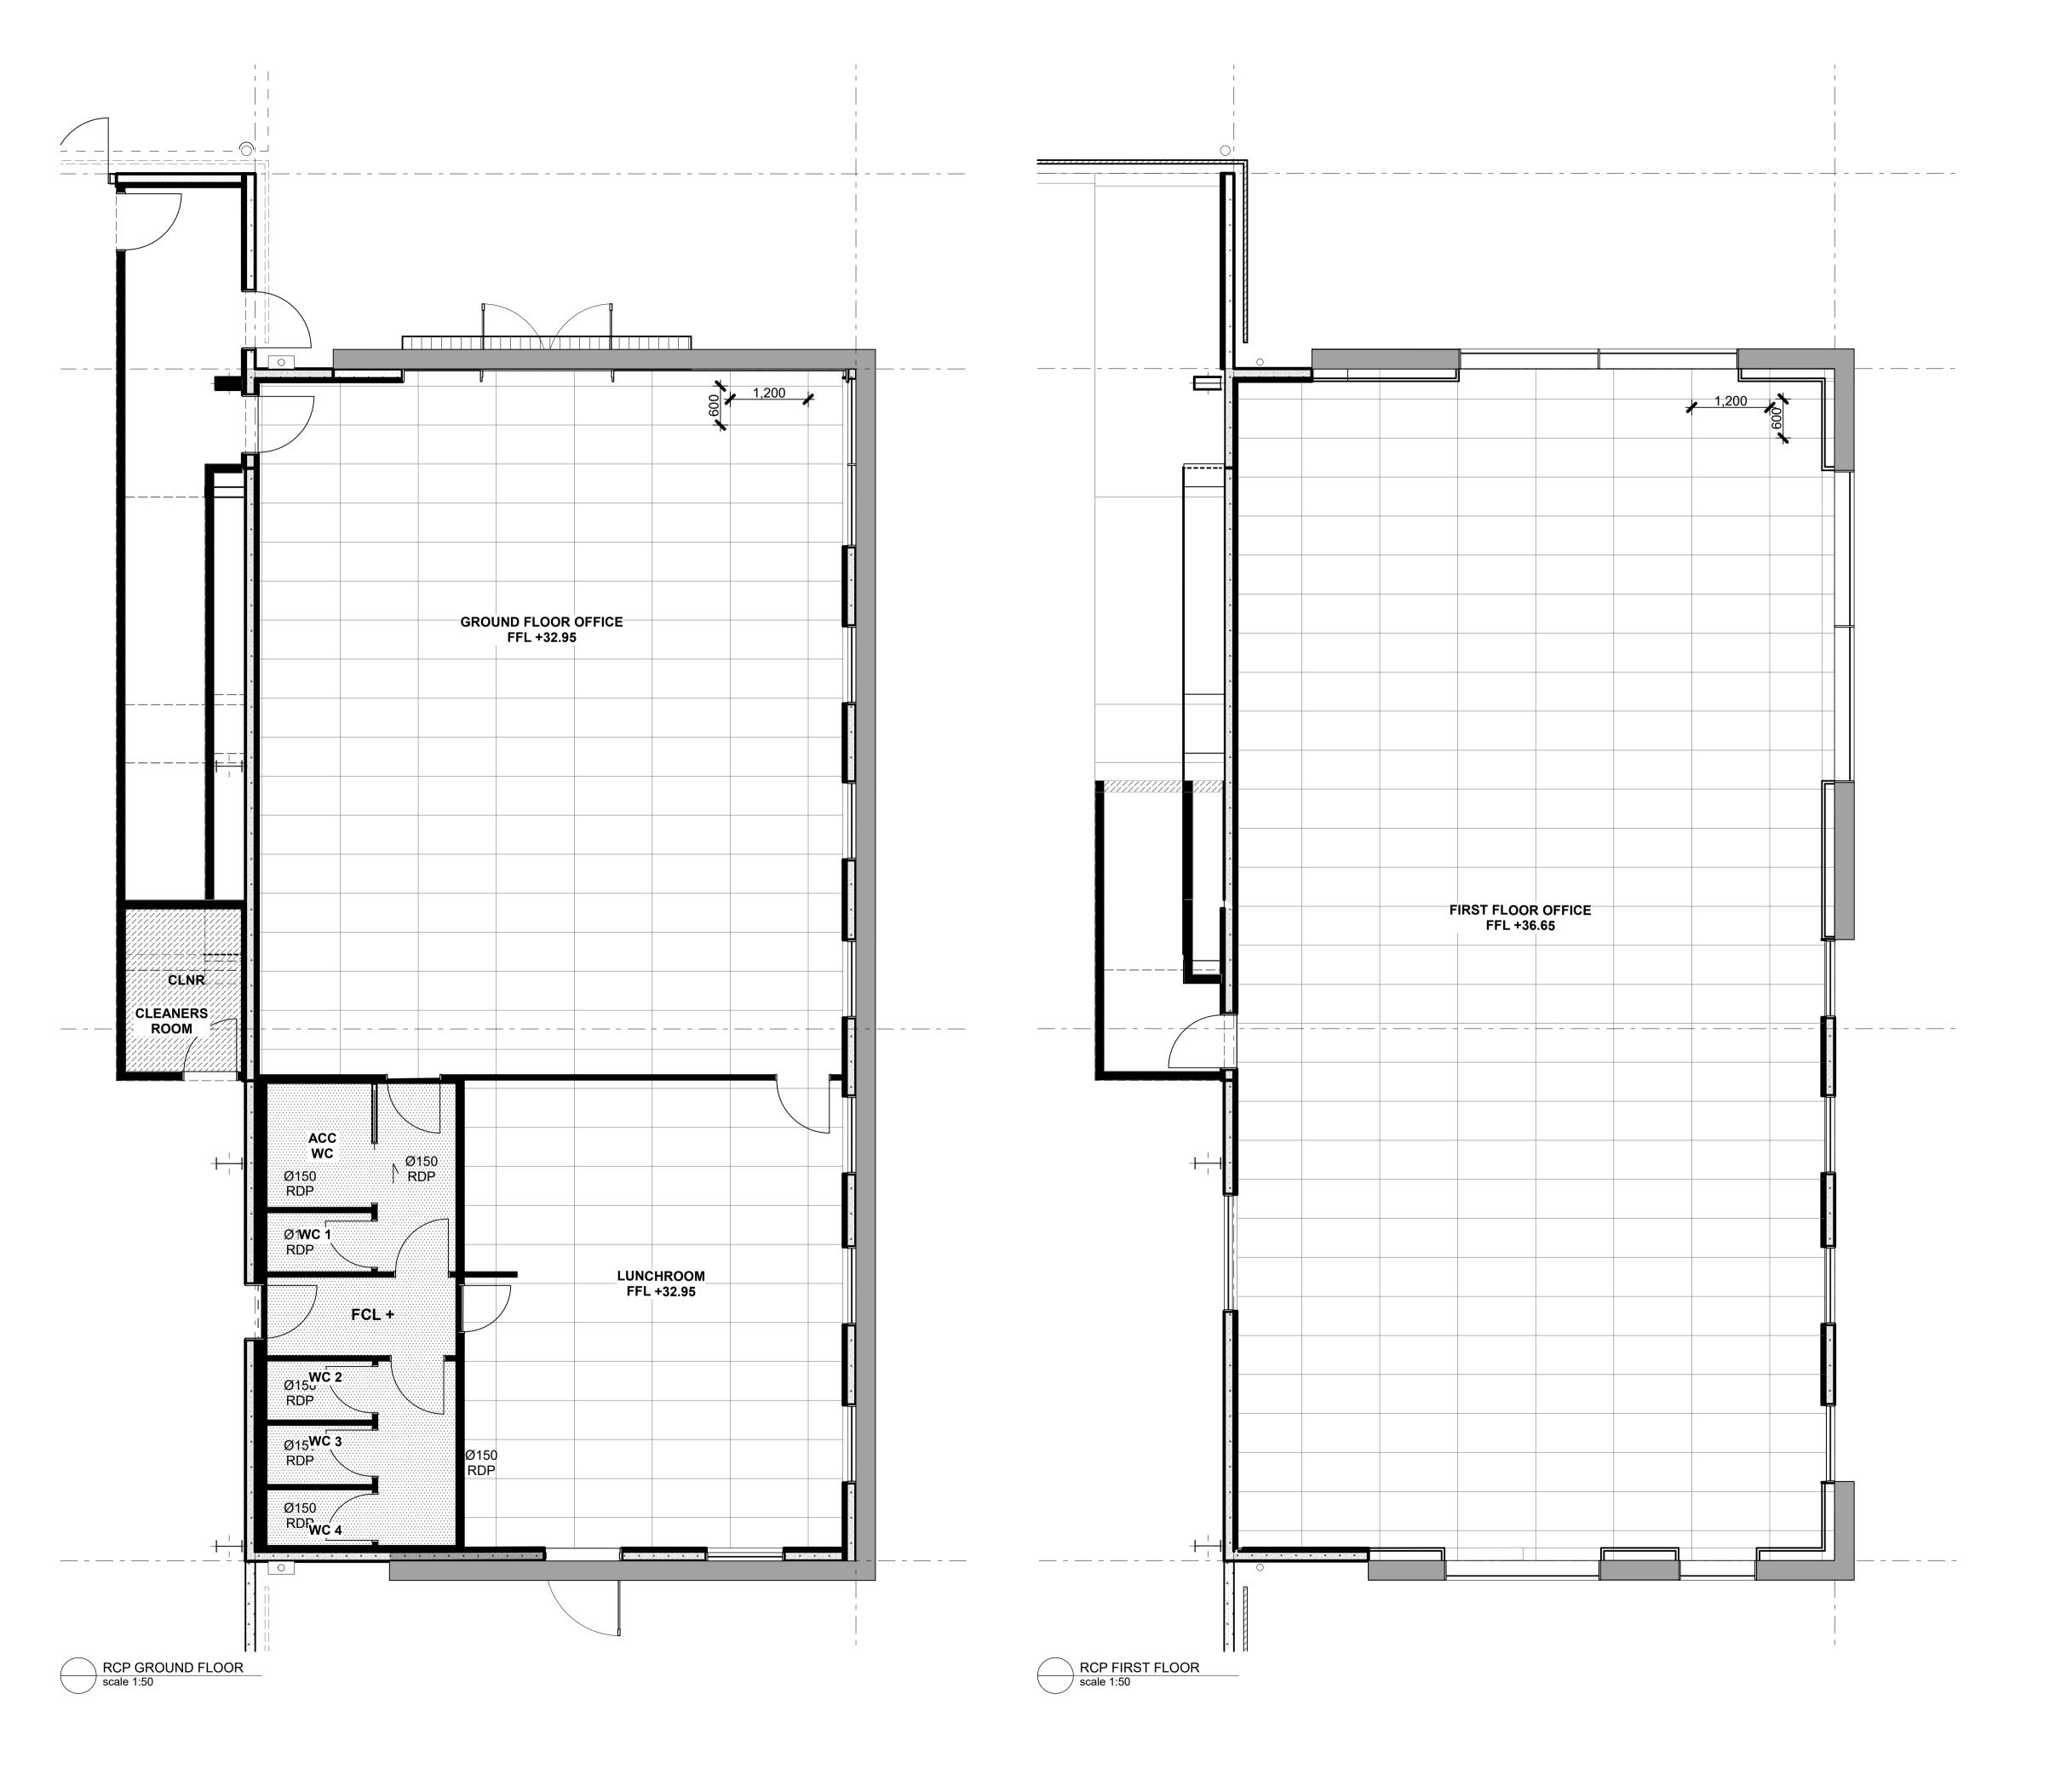
AS SHOWN @ A1

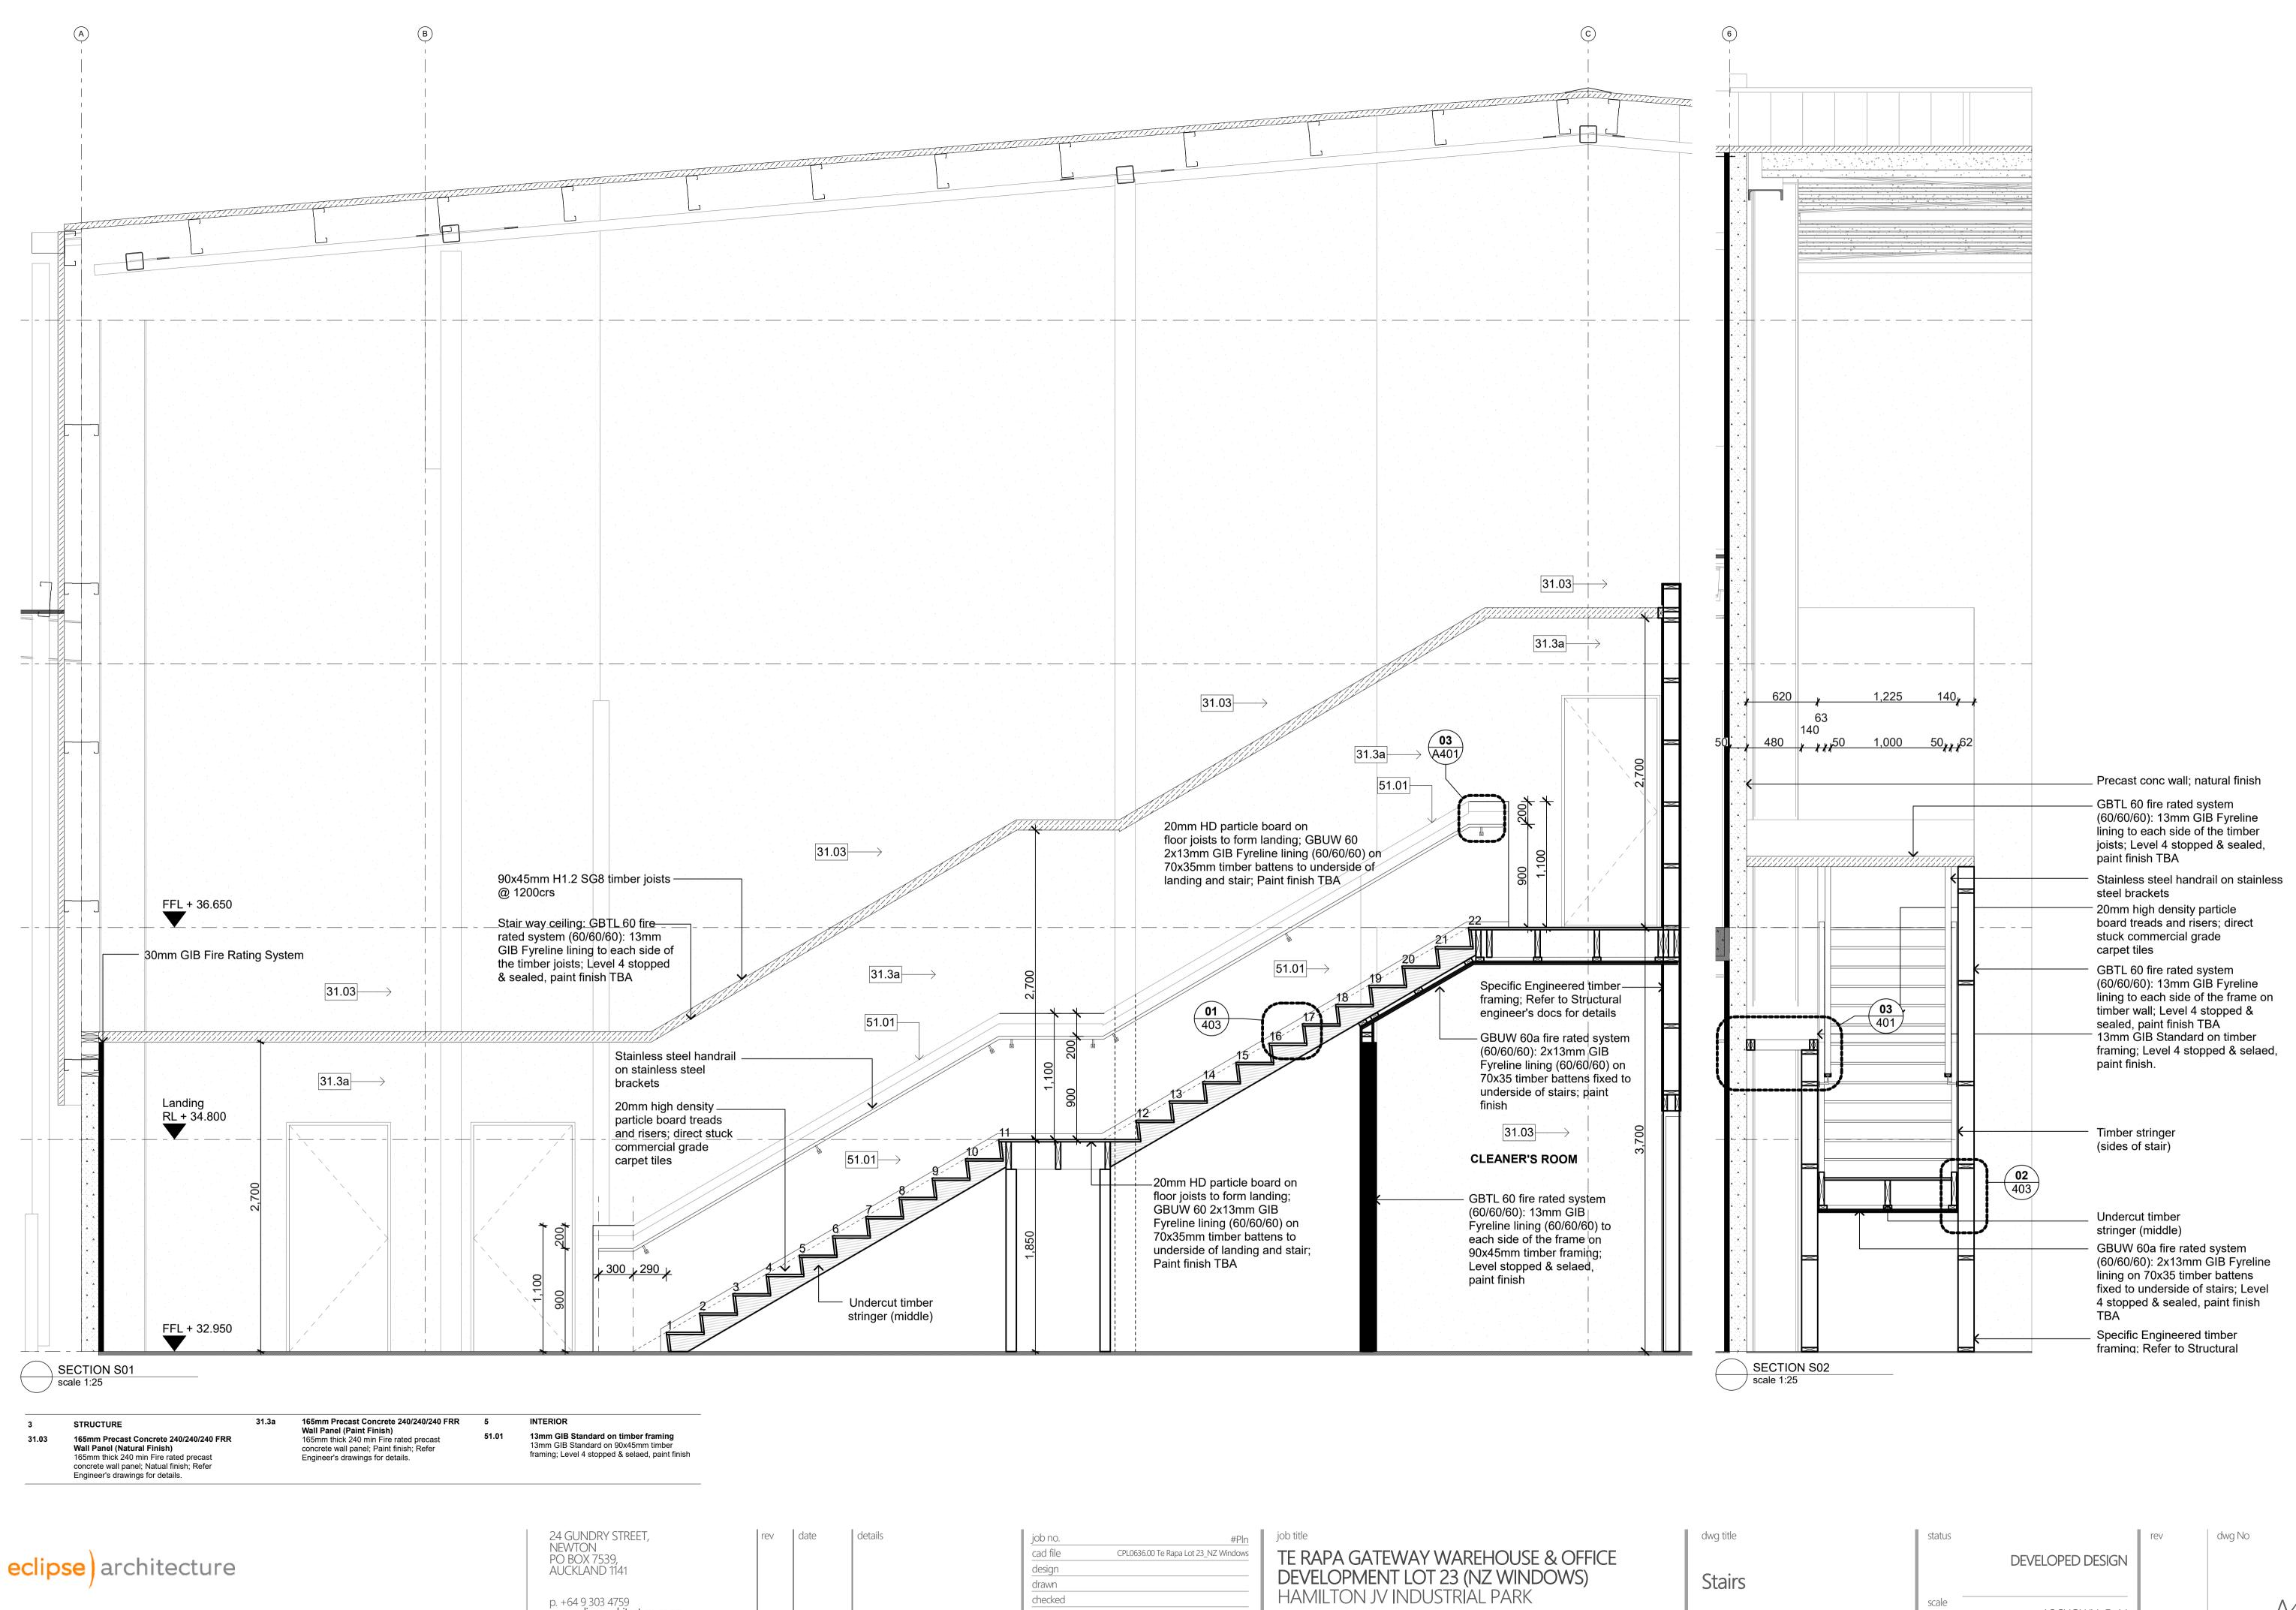


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TE RAPA GATEWAY
WAREHOUSE &
OFFICE
DEVELOPMENT
LOT 23
(NZ WINDOWS)

(NZ WINDOWS)
HAMILTON JV
INDUSTRIAL PARK


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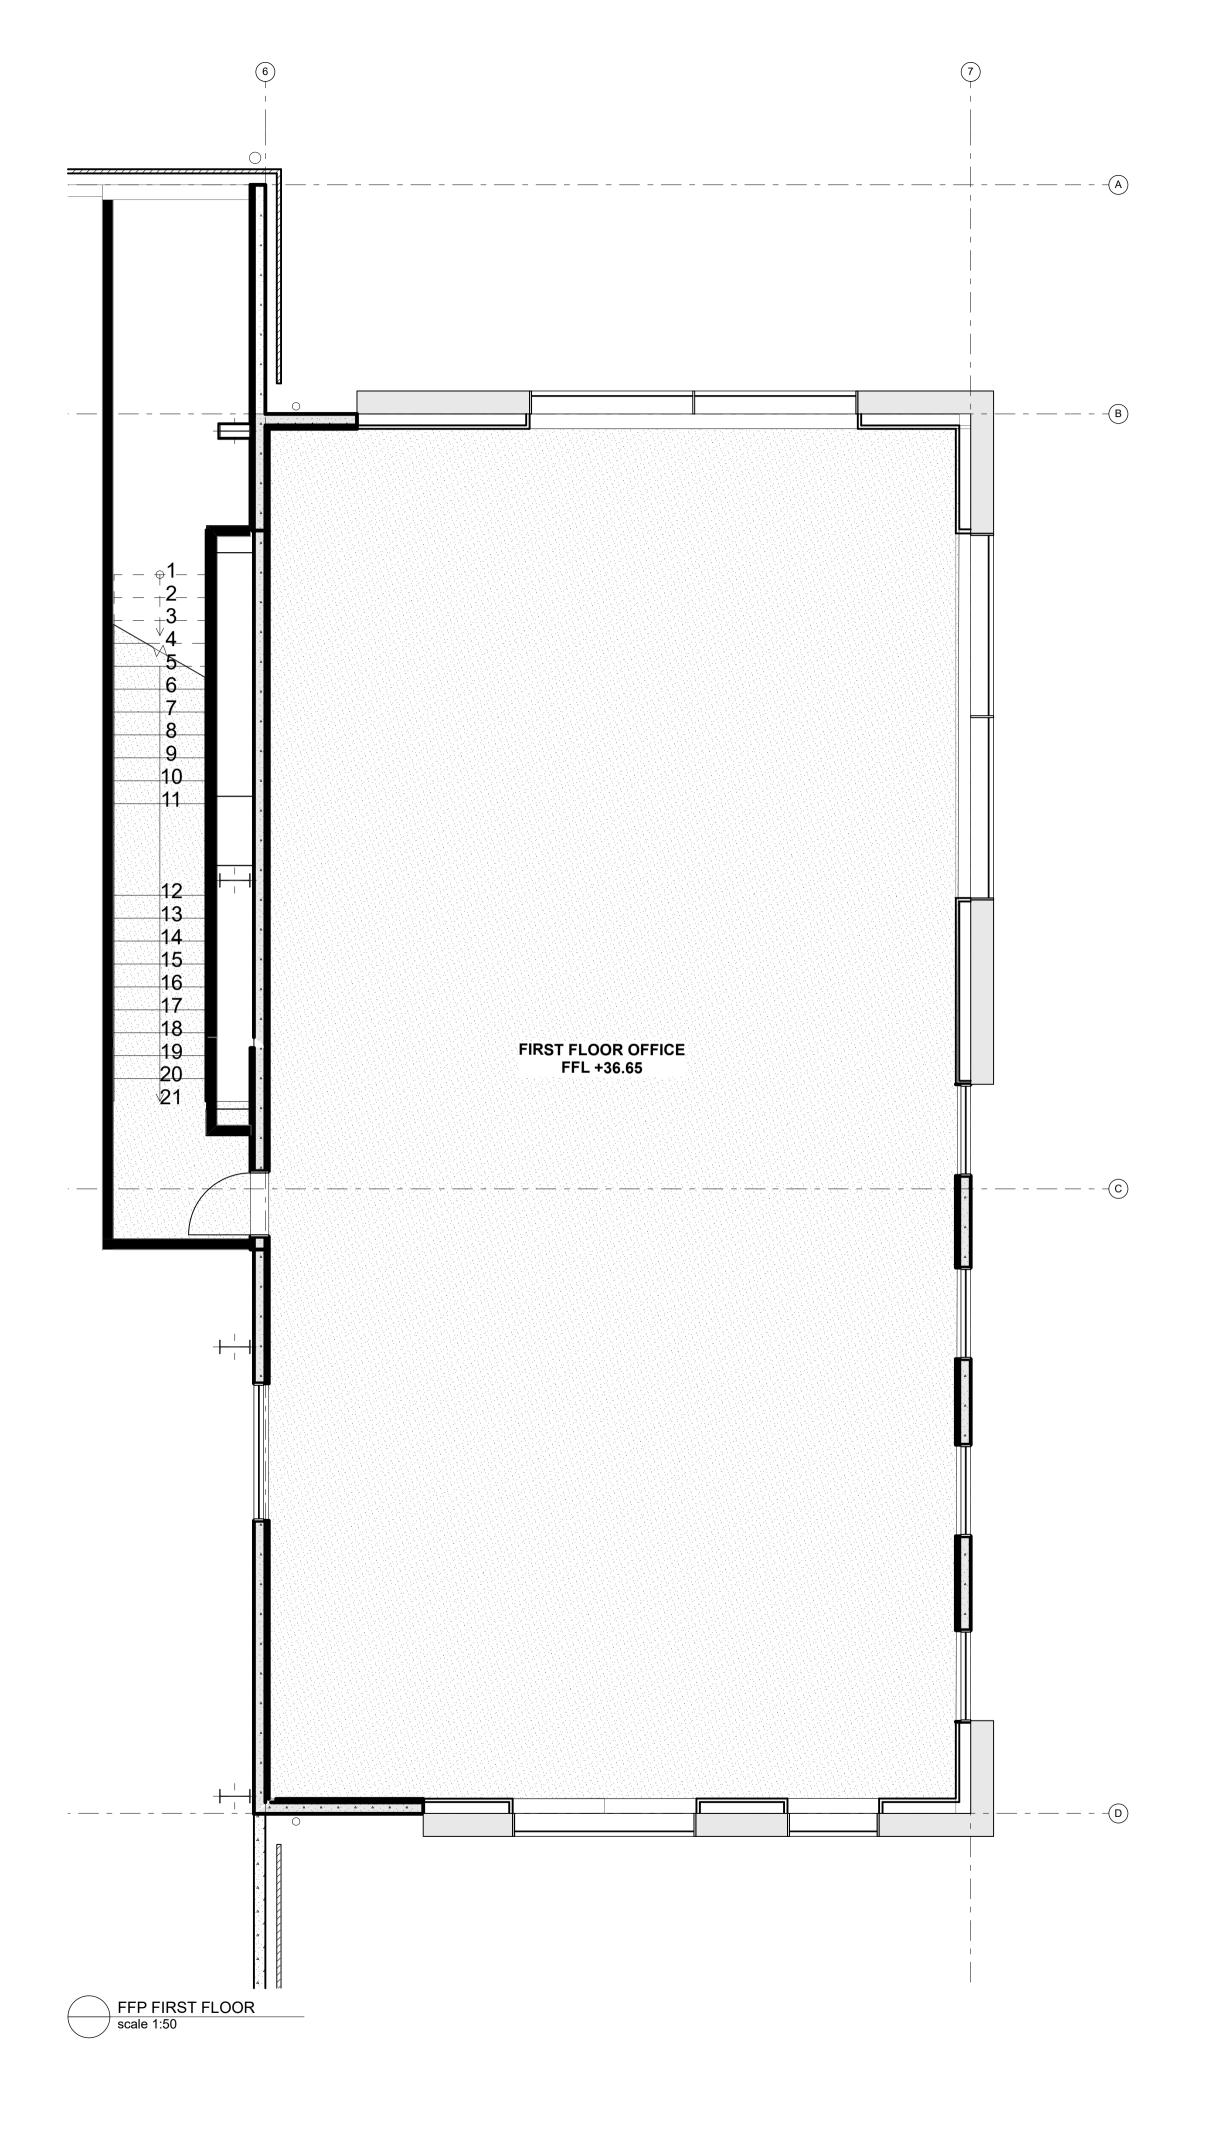
Reflected Ceiling Plan


DEVELOPED DESIGN

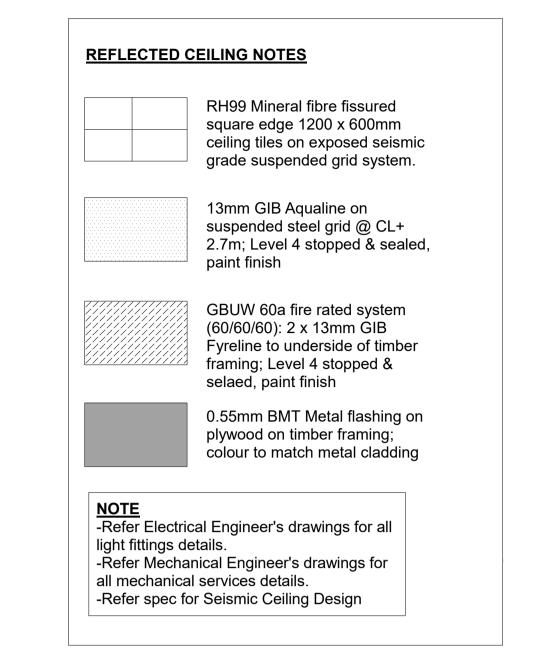AS SHOWN @ A1

rev dwg No
1 A500



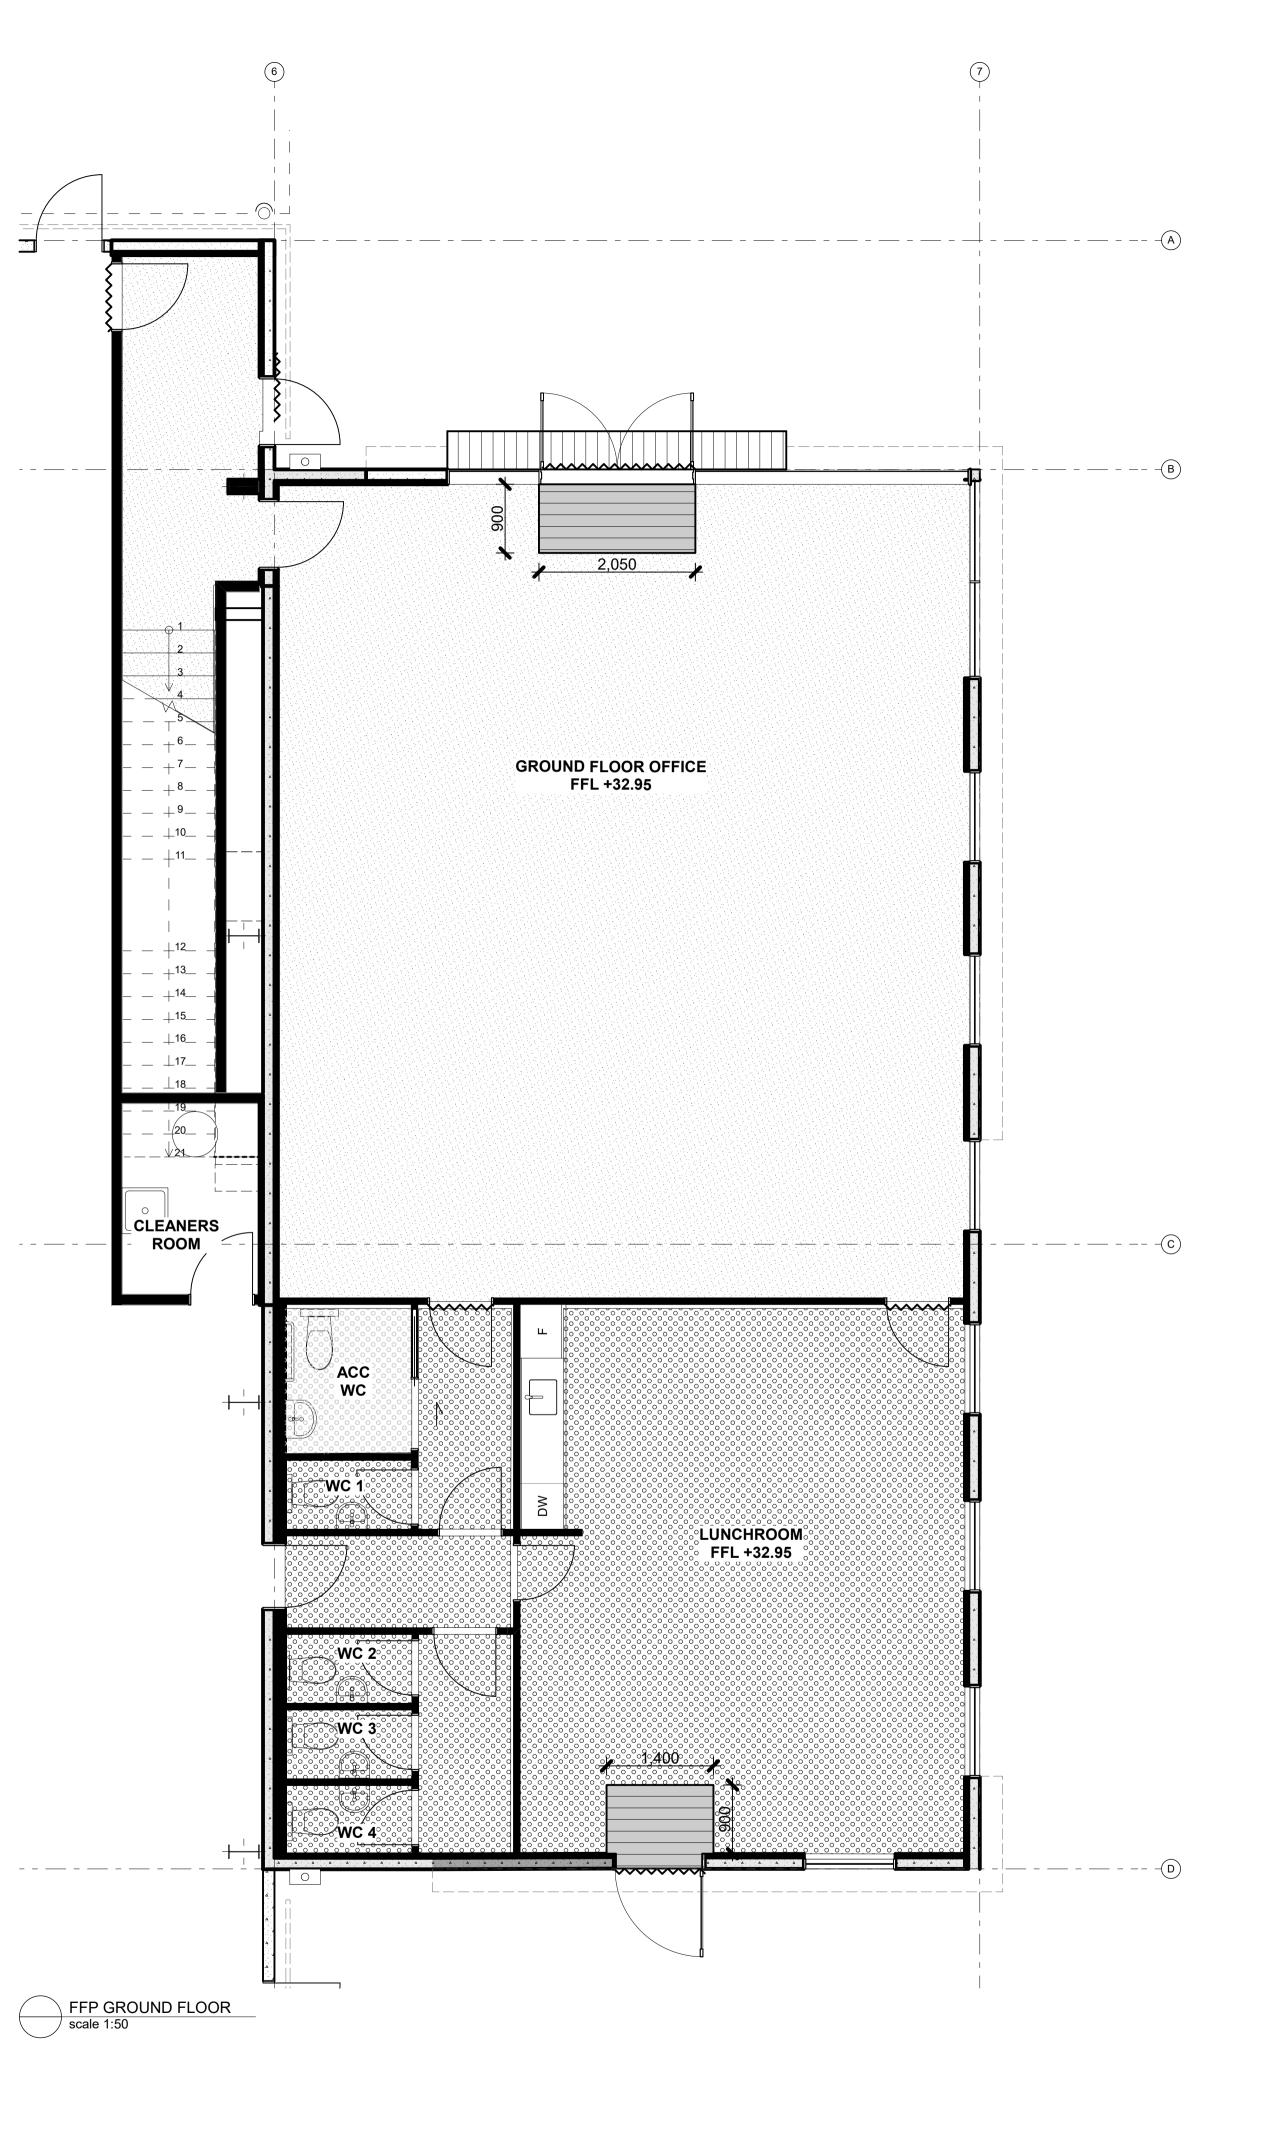

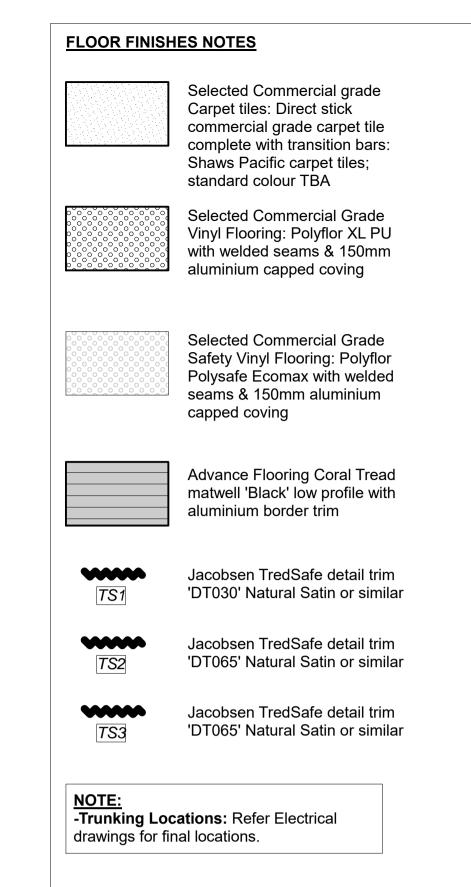

rev	date	details	

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job no.	CPL0471.00
cad file	CPL0636.00 Te Rapa Lot 23_NZ Windows
design	
drawn	
checked	
date	8/31/2018
job title	

TE RAPA GATEWAY
WAREHOUSE &
OFFICE
DEVELOPMENT
LOT 23
(NZ WINDOWS)
HAMILTON JV
INDUSTRIAL PARK

dwg title

Floor Finishes Plan


status

DEVELOPED DESIGN

cale


AS SHOWN @ A1

1 A501

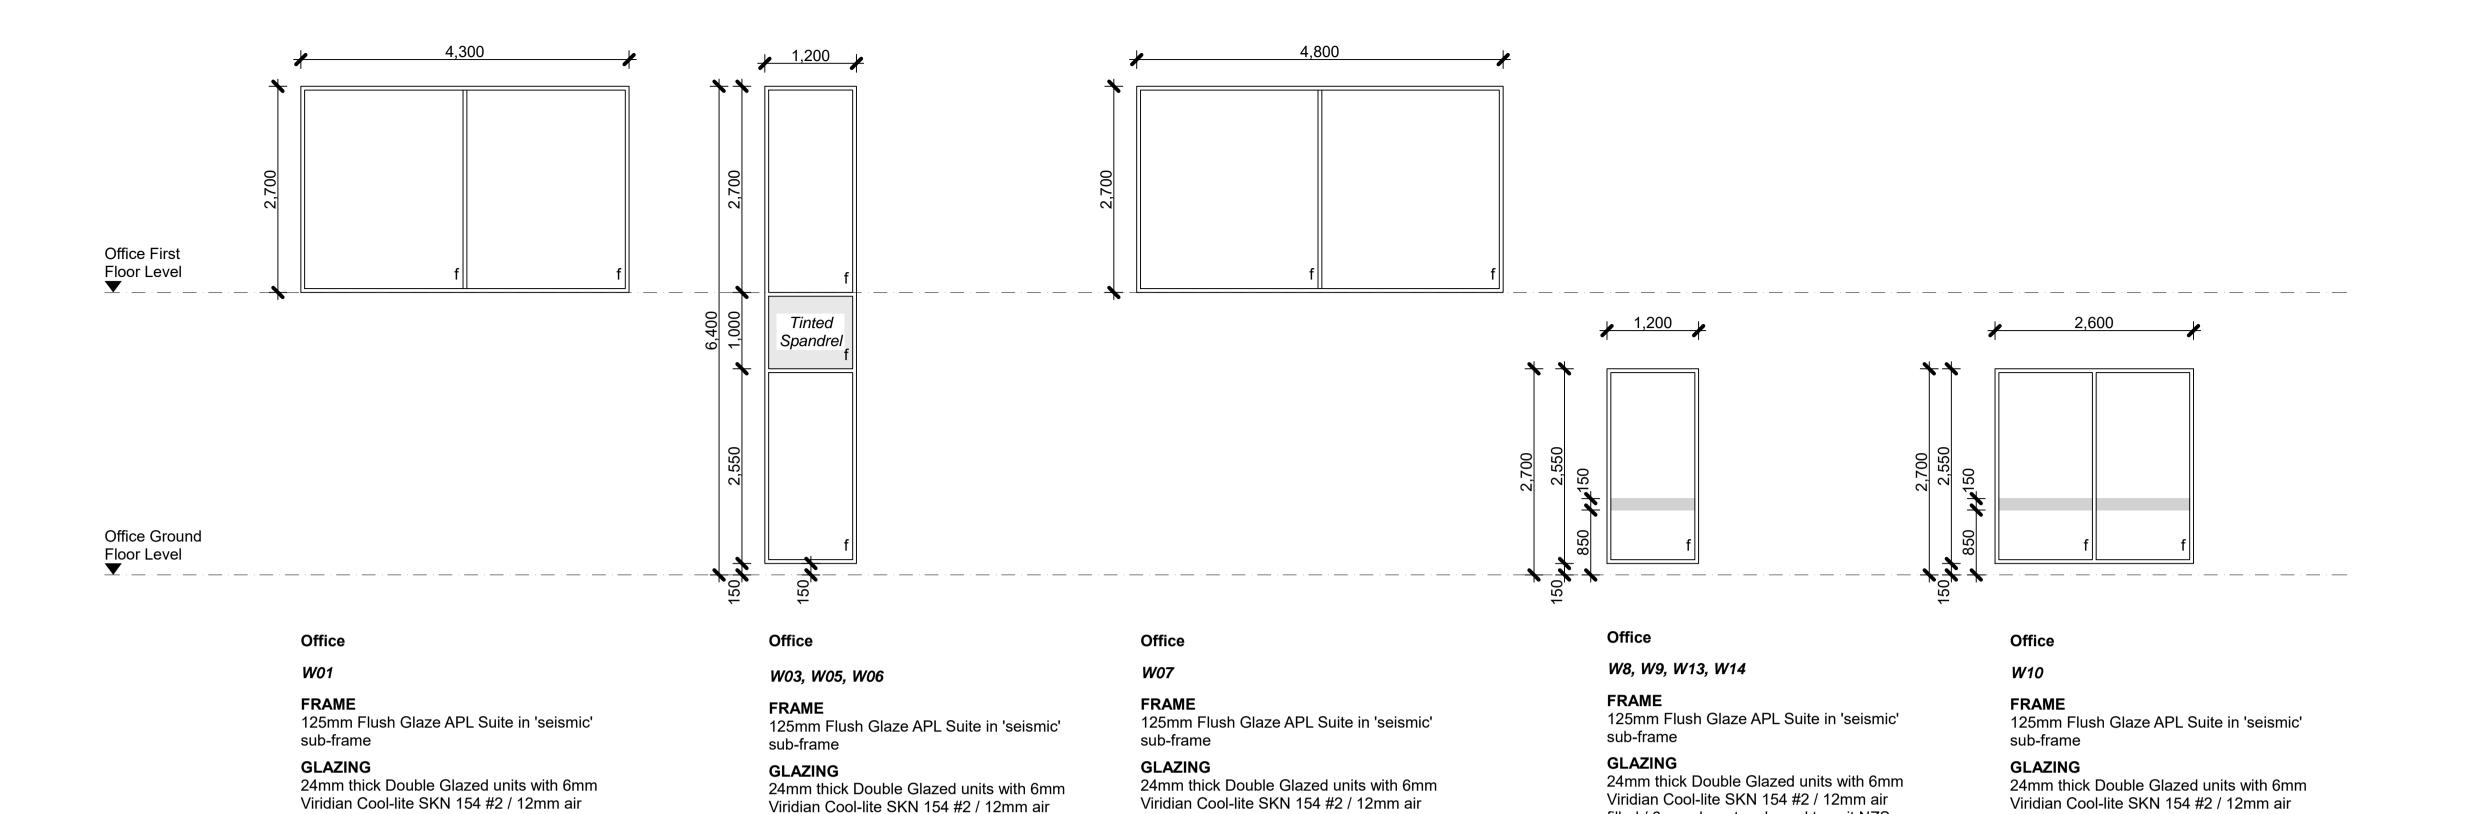

filled / 6mm clear, toughened to suit NZS

4223 Glazing in buildings

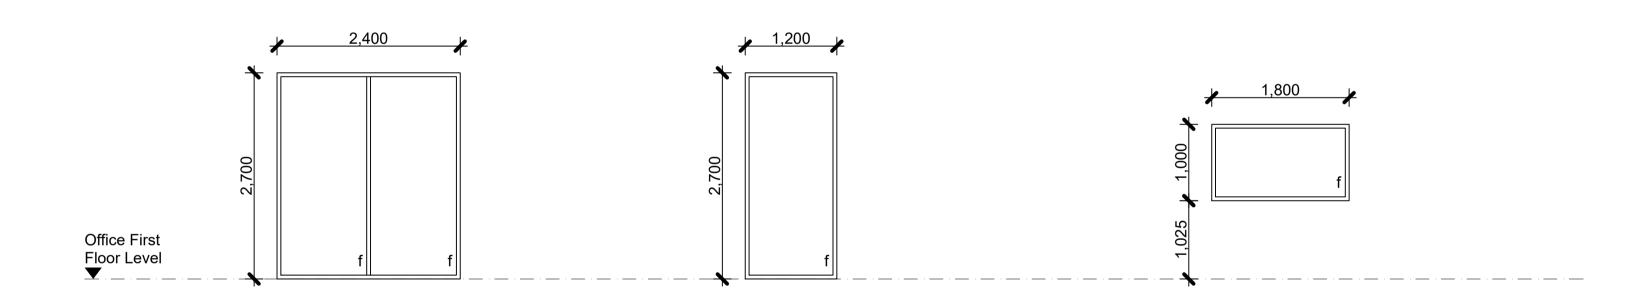

Office

W11

FRAME 125mm Flush Glaze APL Suite in 'seismic' sub-frame

filled / 6mm clear, toughened to suit NZS

4223 Glazing in buildings

GLAZING

24mm thick Double Glazed units with 6mm Viridian Cool-lite SKN 154 #2 / 12mm air filled / 6mm clear, toughened to suit NZS 4223 Glazing in buildings

Office

W12

FRAME 125mm Flush Glaze APL Suite in 'seismic' sub-frame

filled / 6mm clear, toughened to suit NZS

4223 Glazing in buildings

GLAZING

24mm thick Double Glazed units with 6mm Viridian Cool-lite SKN 154 #2 / 12mm air filled / 6mm clear, toughened to suit NZS 4223 Glazing in buildings

Office - Internal Window

W13

FRAME

Potters Interior system 'A Series 132' aluminium frame or similar; powdercoat finish to suit exterior aluminium frame

filled / 6mm clear, toughened to suit NZS

4223 Glazing in buildings

GLAZING

Clear toughened to suit NZS4223 Glazing in buildings

ALUMINIUM WINDOW NOTES:

filled / 6mm clear, toughened to suit NZS

4223 Glazing in buildings

- All window dimensions are rough opening
- 2. Site measure before manufacture and
- installation of all joinery
- 3. Refer to FLOOR PLANS & ELEVATIONS for joinery locations and window reference
- 4. All aluminium joinery to be powdercoated. Colour to be selected by Architect
- 5. Provide powdercoated head flashings to match and jamb flashings to all exterior windows
- All glass to be toughened in accordance with NZS4223 Glazing in buildings
- 7. All windows to have square beads
- 8. All jamb liners to be H3 pine refer details,
- unless otherwise specified 9. Manifestations to doors and windows with
- 20mm 3M frosted safety film in accordance with NZS4223 Glazing in Buildings. Denoted on glazing as:

WIND LOADS

In accordance with AS/NZS 1170.2:2011 the structure is not wind sensitive. A static analysis procedure is applicable.

Site Wind Speed Profile

To AS/NZS 1170.2:2011

A7 (Hamilton)

Regional Wind speed, VR: ULS: 38m/s (1.13kPa)

SLS: 31m/s (0.78kPa)

date

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design	
drawn	
checked	
date	8/31/2018

job title

TE RAPA GATEWAY WAREHOUSE & OFFICE DEVELOPMENT LOT 23 (NZ WINDOWS) **HAMILTON JV** INDUSTRIAL PARK

dwg title

Window Schedule


status

DEVELOPED DESIGN

AS SHOWN @ A1

dwg No A600

Window Schedule

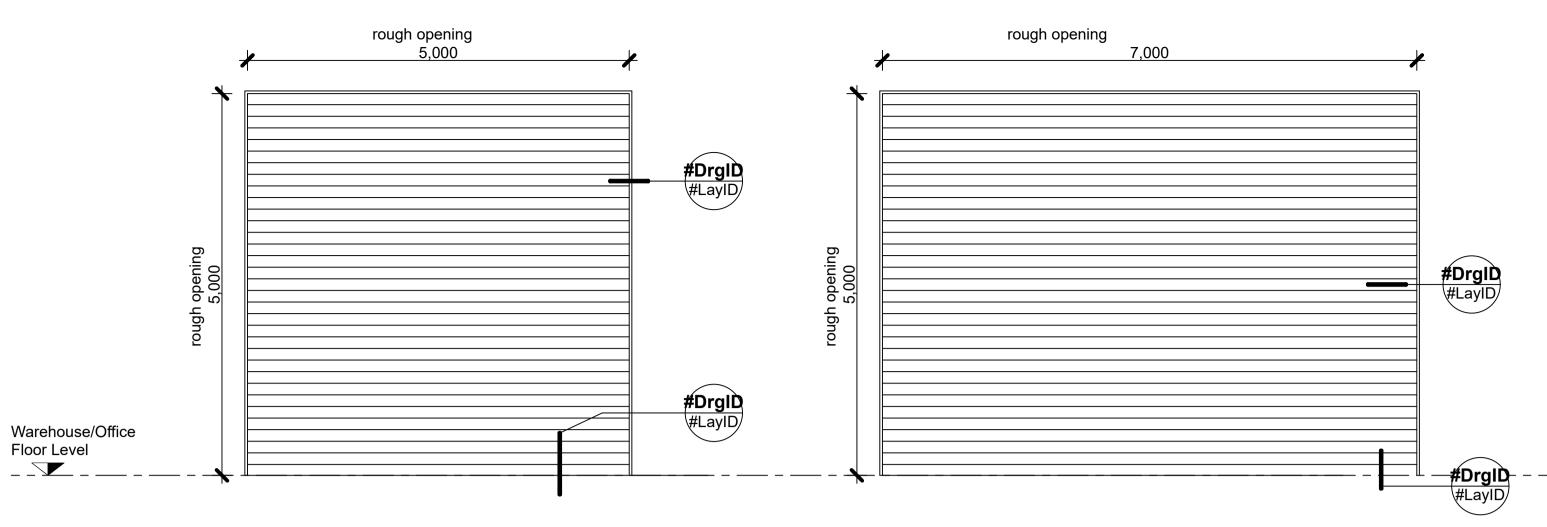

Roller Shutter Doors

D01, D02

FRAME

Door in galvanised steel channel frame on precast concrete opening. Refer to details.

DOOR SET

Warehouse Industrial roller door - Ace Door HushShutter 2 Steel flat panel roller door: Powdercoated motorised (3Phase) roller shutter doors complete with bird brush. Motorised using Grifco 3 phase, 1HP mechanical motor with automatic hand chain engagement (12 months warranty on doors, 2 year warranty on Motors)

HARDWARE

Integrated to alarm system. Standard up and down push button controller for installation by electrician. Limit switches at motor.

Roller Shutter Doors

D03

FRAME

Door in galvanised steel channel frame on precast concrete opening. Refer to details.

DOOR SET

Warehouse Industrial roller door - Ace Door HushShutter 2 Steel flat panel roller door: Powdercoated motorised (3Phase) roller shutter doors complete with bird brush. Motorised using Grifco 3 phase, 1HP mechanical motor with automatic hand chain engagement (12 months warranty on doors, 2 year warranty on Motors)

HARDWARE

Integrated to alarm system. Standard up and down push button controller for installation by electrician. Limit switches at motor.

Exterior: Warehouse Security Door

D06, D07, D23, D24, D25

FRAME

Door leaf

910

Powdercoated aluminium frame with Sikaflex sealant to both sides. Allow for door closer to be fitted to interior head section; refer to details

DOOR SET

Solid Security Door. Soild core Aluminium faced personnel door. Axon 3mm steel anti jemmy strip bolted through; powdercoated to match aluminium frame

HARDWARE

Refer to Hardware Schedule- D35 to have cylinder locks on both sides

Interior: Office Hinged Door - Fire Rating -/60/30

Stainless steel

kickplate to

both sides

D08, D09, D21

-Timber T2 jamb

Door leaf

810

FRAME / DOOR / HARDWARE

NZ Fire door -/60/30 system. Framing, Door & Hardware to manufacturer's recommendation.

- Door leaf facing: paint quality factory sealed. - 300mm high 1mm stainless steel kickplate to both sides - Bullnose (Ali) leaf edge detail

Interior: Office Hinged Door - Fire Rating -/60/

Stainless steel

kickplate to

both sides

D10, D13


Door leaf

810

FRAME / DOOR / HARDWARE

NZ Fire door -/60/60 system. Framing, Door & Hardware to manufacturer's recommendation.

- Door leaf facing: paint quality factory sealed. - 300mm high 1mm stainless steel kickplate to bo
- Bullnose (Ali) leaf edge detail -Timber T2 jamb

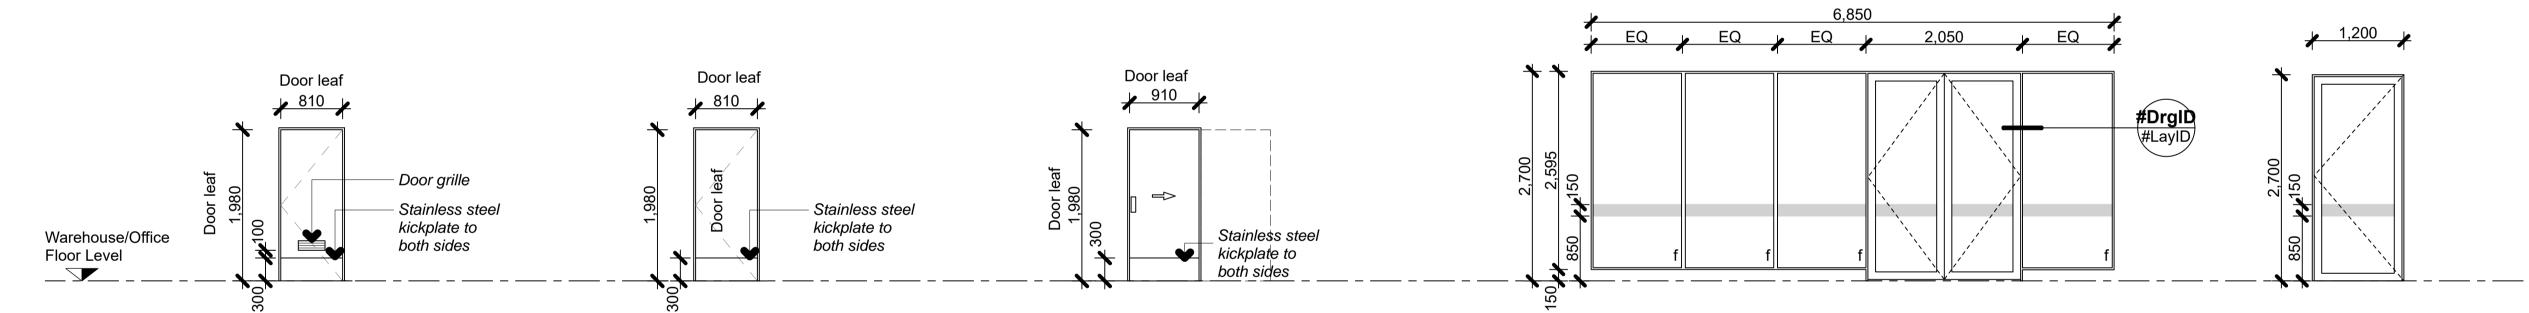

Interior: Office Hinged Door

D11, D12, D14, D15, D22

FRAME

30mm thick pine jamb liner with Pinex M26 door stops

DOOR

35mm thick Solid Core door with 6mm MDF facings both sides of door & 6mm solid timber clashing strips glued to both vertical edges; paint finish.

Stainless steel kickplates to both sides

Door Grille RLL 25 350x125mm; refer to Mechanical Engineer's drawings for details.

HARDWARE

Refer to Hardware schedule

Interior: Interior Hinged Doors: Unisex Toilets / Male & Female Toilets

D16, D18, D19, D20

FRAME 30mm thick pine jamb liner with Pinex M26

door stops

35mm thick Solid Core door with 6mm MDF facings both sides of door & 6mm solid timber clashing strips glued to both vertival edges; paint finish.

Stainless steel kickplates to both sides

HARDWARE

Refer to Hardware schedule

Interior: Interior Sliding Doors: Accessible WC Cavity Sliding Door

CS Cavity Slider in 90mm timber framed

DOOR

CS Cavity Sliders EasyOpen Complete Disabled Access Toilet Doors Solid Core door with 6mm MDF facings both sides of door & 6mm solid timber clashing strips glued to both vertival edges; paint finish

Stainless steel kickplates to both sides

HARDWARE

CL100 LaviLock by CaviLock; Satin Chrome finish. Fitting height to centre to be

Exterior Glazed Door: Reception/Entry

FRAME

125mm Flush Glazed APL suite. All fixings & fastenings to be stainless steel. Neoprene glazing strips & square slip in aluminium glazing beads

DOOR

125mm Flushglaze Hinged commercial door. 100mm stiles & 120mm wide top bottom rails. Continuous mohair draught strip to jambs, head & stiles. All fixings & fastenings to be of stainless steel. Neoprene glazing strips & square slip-in aluminium beads

GLAZING

24mm thick Double Glazed units with 6mm Viridian Cool-lite SKN 154 #2 / 12mm air filled / 6mm clear, to suit NZS 4223 Glazing in buildings

HARDWARE

Refer to Hardware schedule

Exterior Glazed Door:

Lunchroom/Entry D05

FRAME

125mm Flush Glazed APL suite. All fixings & fastenings to be stainless steel. Neoprene glazing strips & square slip in aluminium glazing beads

DOOR

125mm Flushglaze Hinged commercial door, 100mm stiles & 120mm wide top bottom rails. Continuous mohair draught strip to jambs, head & stiles. All fixings & fastenings to be of stainless steel. Neoprene glazing strips & square slip-in aluminium beads GLAZING 24mm thick Double Glazed units with 6mm Viridian Cool-lite SKN 154 #2 / 12mm air filled / 6mm clear, to suit NZS 4223 Glazing in buildings

HARDWARE

Refer to Hardware schedule

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cad file	CPL0636.00 Te Rapa Lot 23_NZ Windows
design	
drawn	
checked	
date	8/31/2018
iob title	

TE RAPA GATEWAY **WAREHOUSE & OFFICE** DEVELOPMENT LOT 23 (NZ WINDOWS) **HAMILTON JV** INDUSTRIAL PARK

dwg title

Door Schedule

status DEVELOPED DESIGN

AS SHOWN @ A1

dwg No A601

TIMBER DOOR NOTES:

- 1. Door dimensions are **Leaf Sizes** typical, doors with side lights are dimensioned to rough opening.
- 2. Site measure before manufacture and installation of all joinery 3. Refer to FLOOR PLANS & ELEVATIONS for

joinery locations, door swings and door

4. All frames sized for architraves

reference nos.

- 5. Refer Hardware Schedule in Specification for hardware.
- 6. Door undercuts; refer Mechanical drawings

ALUMINIUM DOOR NOTES:

- All door dimensions are rough opening
- 2. Site measure before manufacture and installation of all joinery 3. Refer to FLOOR PLANS & ELEVATIONS for joinery locations and window reference
- 4. All aluminium joinery to be powdercoated. Colour to be selected by Architect
- 5. Provide powdercoated head flashings to match and jamb flashings to all exterior windows

6. All glass to be toughened in accordance with NZS4223 Glazing in buildings

- 7. All windows to have square beads
- 9. Manifestations to doors and windows with 20mm 3M frosted safety film in accordance with NZS4223 Glazing in Buildings. Denoted on glazing as:

8. All jamb liners to be H3 pine - refer details

Site Wind Speed Profile

To AS/NZS 1170.2:2011

Region:

Regional Wind speed, VR: 45m/s ULS 37m/s SLS

WIND LOADS

In accordance with AS/NZS 1170.2:2011 the structure is not wind sensitive. A static analysis procedure is applicable.

A7 (Hamilton)