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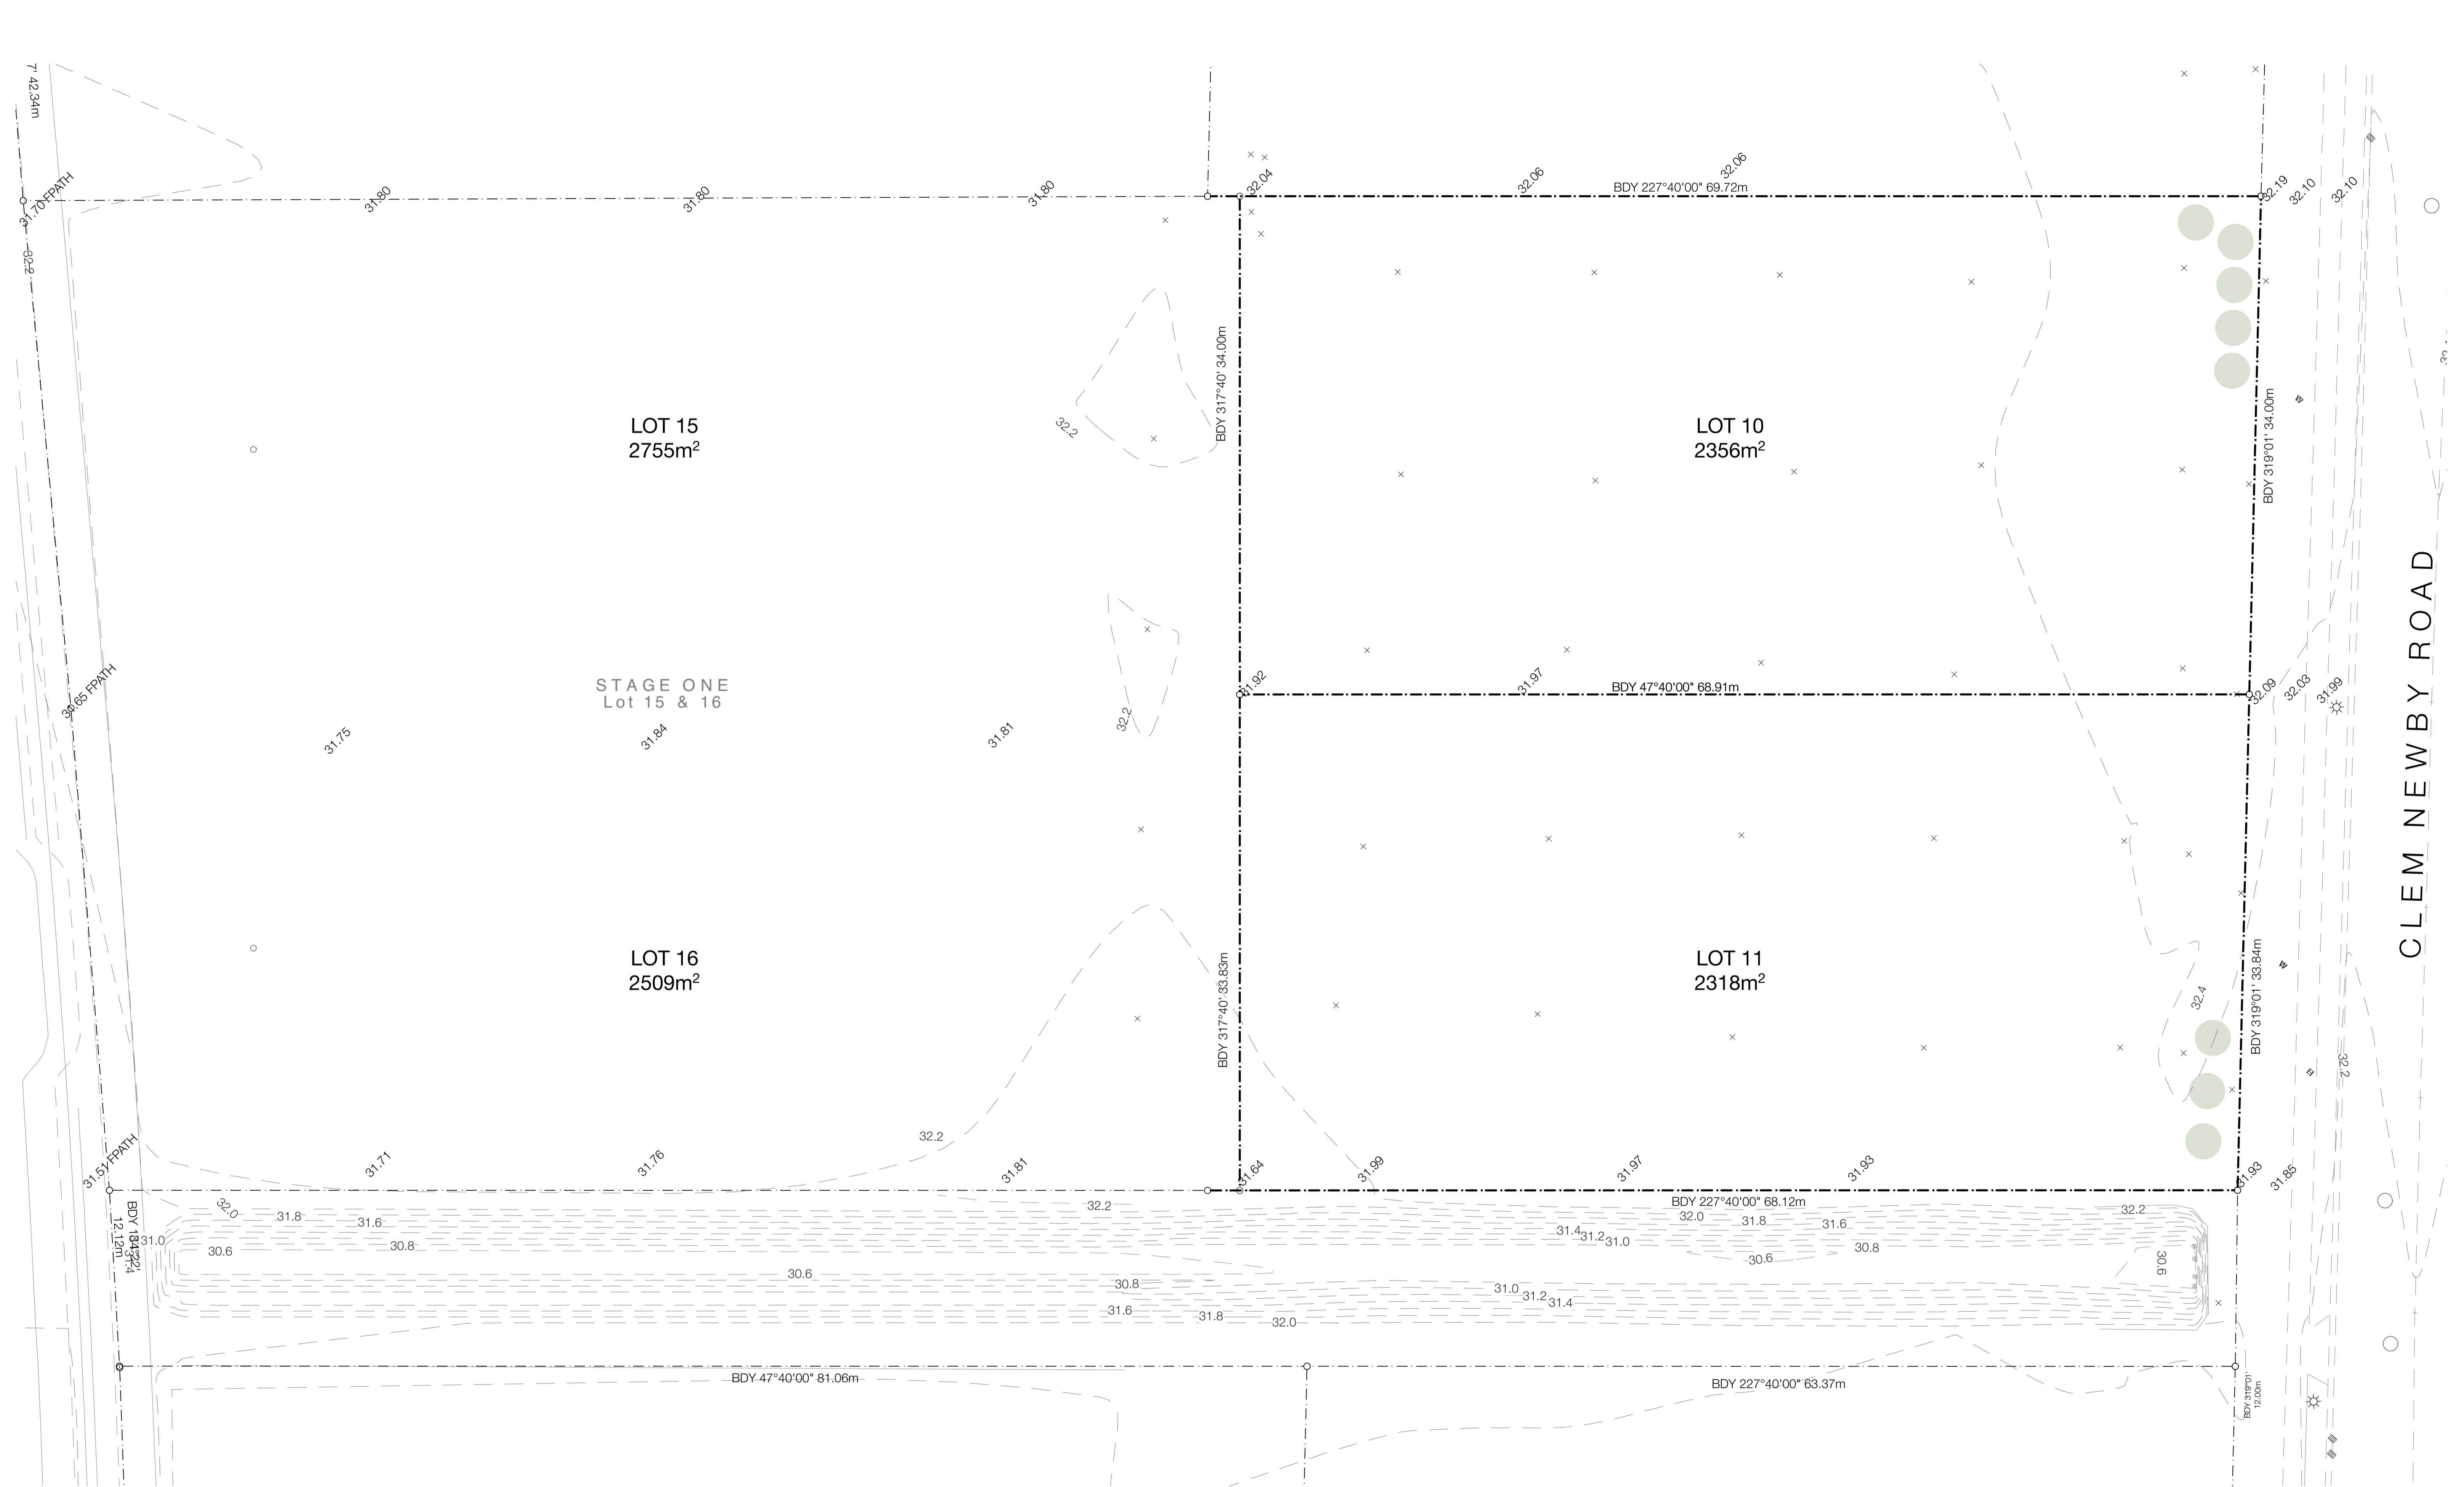
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Te Rapa Stage 2 - CONSTRUCTION ISSUE

drawing number	title	format	revision	ISSUE 25/06/19		
-	SPECIFICATION	-	C01	PDF		
A01	EXISTING SURVEY PLAN	1:200 @ A1	C01	PDF		
A02	PROPOSED SITE PLAN	1:200 @ A1	C01	PDF		
A03	PROPOSED SITE WORKS PLAN	1:125 @ A1	C01	PDF		
A04	PROPOSED ROOF + DRAINAGE PLAN	1:200 @ A1	C01	PDF		
A05	PROPOSED OVERALL GROUND FLOOR PLAN	1:200 @ A1	C01	PDF		
A06	PROPOSED OVERALL FIRST FLOOR PLAN	1:200 @ A1	C01	PDF		
A07	PROPOSED PART PLANS - BUILDING 01	1:50 @ A1	C01	PDF		
A08	PROPOSED PART PLANS - BUILDING 02	1:50 @ A1	C01	PDF		
A09	PROPOSED PART PLANS - BUILDING 03	1:50 @ A1	C01	PDF		
A 10	PROPOSED PART PLANS - BUILDING 04	1:50 @ A1	C01	PDF		
A 11	PROPOSED PART PLANS - BUILDING 05	1:50 @ A1	C01	PDF		
A 12	PROPOSED PART PLANS - BUILDING 06	1:50 @ A1	C01	PDF		
A 13	PROPOSED PLUMBING PLANS - BUILDINGS 01-03	1:50 @ A1	C01	PDF		
A 14	PROPOSED PLUMBING PLANS - BUILDINGS 04-06	1:50 @ A1	C01	PDF		
A 15	PROPOSED ELEVATIONS	1:125 @ A1	C01	PDF		
A 16	PROPOSED ELEVATIONS	1:125 @ A1	C01	PDF		
A 17	PROPOSED CROSS SECTIONS	1:50 @ A1	C01	PDF		
A 18	PROPOSED CROSS SECTIONS	1:50 @ A1	C01	PDF		
A 19	PROPOSED CROSS SECTIONS	1:50 @ A1	C01	PDF		
A 20	PROPOSED LONG SECTIONS	1:100 @ A1	C01	PDF		
A 21	PROPOSED LONG SECTIONS	1:100 @ A1	C01	PDF		
A 22	PROPOSED FLOOR FINISHES - BUILDINGS 01-03	1:50 @ A1	C01	PDF		
A 23	PROPOSED FLOOR FINISHES - BUILDINGS 04-06	1:50 @ A1	C01	PDF		
A 24	PROPOSED CEILING FINISHES - BUILDINGS 01-03	1:50 @ A1	C01	PDF		
A 25	PROPOSED CEILING FINISHES - BUILDINGS 04-06	1:50 @ A1	C01	PDF		
A 26	PROPOSED CEILING FINISHES - WAREHOUSE	1:125 @ A1	C01	PDF		
A 27	TYPICAL ACCESSIBLE BATHROOM	1:10 @ A1	C01	PDF		
A 28	TYPICAL UNISEX BATHROOM	1:10 @ A1	C01	PDF		
A 29	TYPICAL KITCHEN	1:10 @ A1	C01	PDF		
A 30	TYPICAL STAIRS	1:10 @ A1	C01	PDF		
A 31	DOOR + WINDOW SCHEDULE	1:10 @ A1	C01	PDF		
A 32	DETAILS - ROOF	1:5 @ A1	C01	PDF		
A 33	DETAILS - WALLS	1:5 @ A1	C01	PDF		
A 34	DETAILS - JOINERY	1:5 @ A1	C01	PDF		
A 35	DETAILS - JOINERY	1:5 @ A1	C01	PDF		
A 36	DETAILS - SIGNAGE	1:10 @ A1	C01	PDF		

T0424 | Te Rapa Industrial Park, Hamilton | Client: Chalmers Property TRG





CLEM NEWBY ROAD

FOR CONSTRUCTION ISSUE

NOTE:
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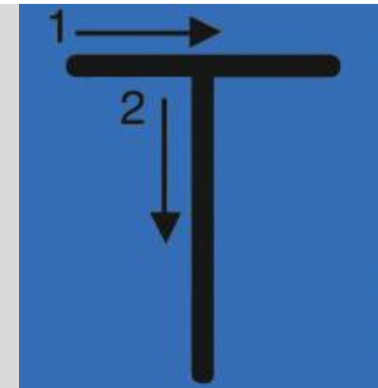
C01

DATE:

25/06/19

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PROJECT:

Te Rapa Stage 2

CLIENT: Fosters Construction
SITE: Te Rapa Industrial Park, Hamilton

DRAWING TITLE:

EXISTING SITE SURVEY PLAN

PROJECT REF:

T0424 TE RAPA S2

DATE:

25/06/19

SCALE:


1:200 @ A1

SHEET:

A01

REV:

C01

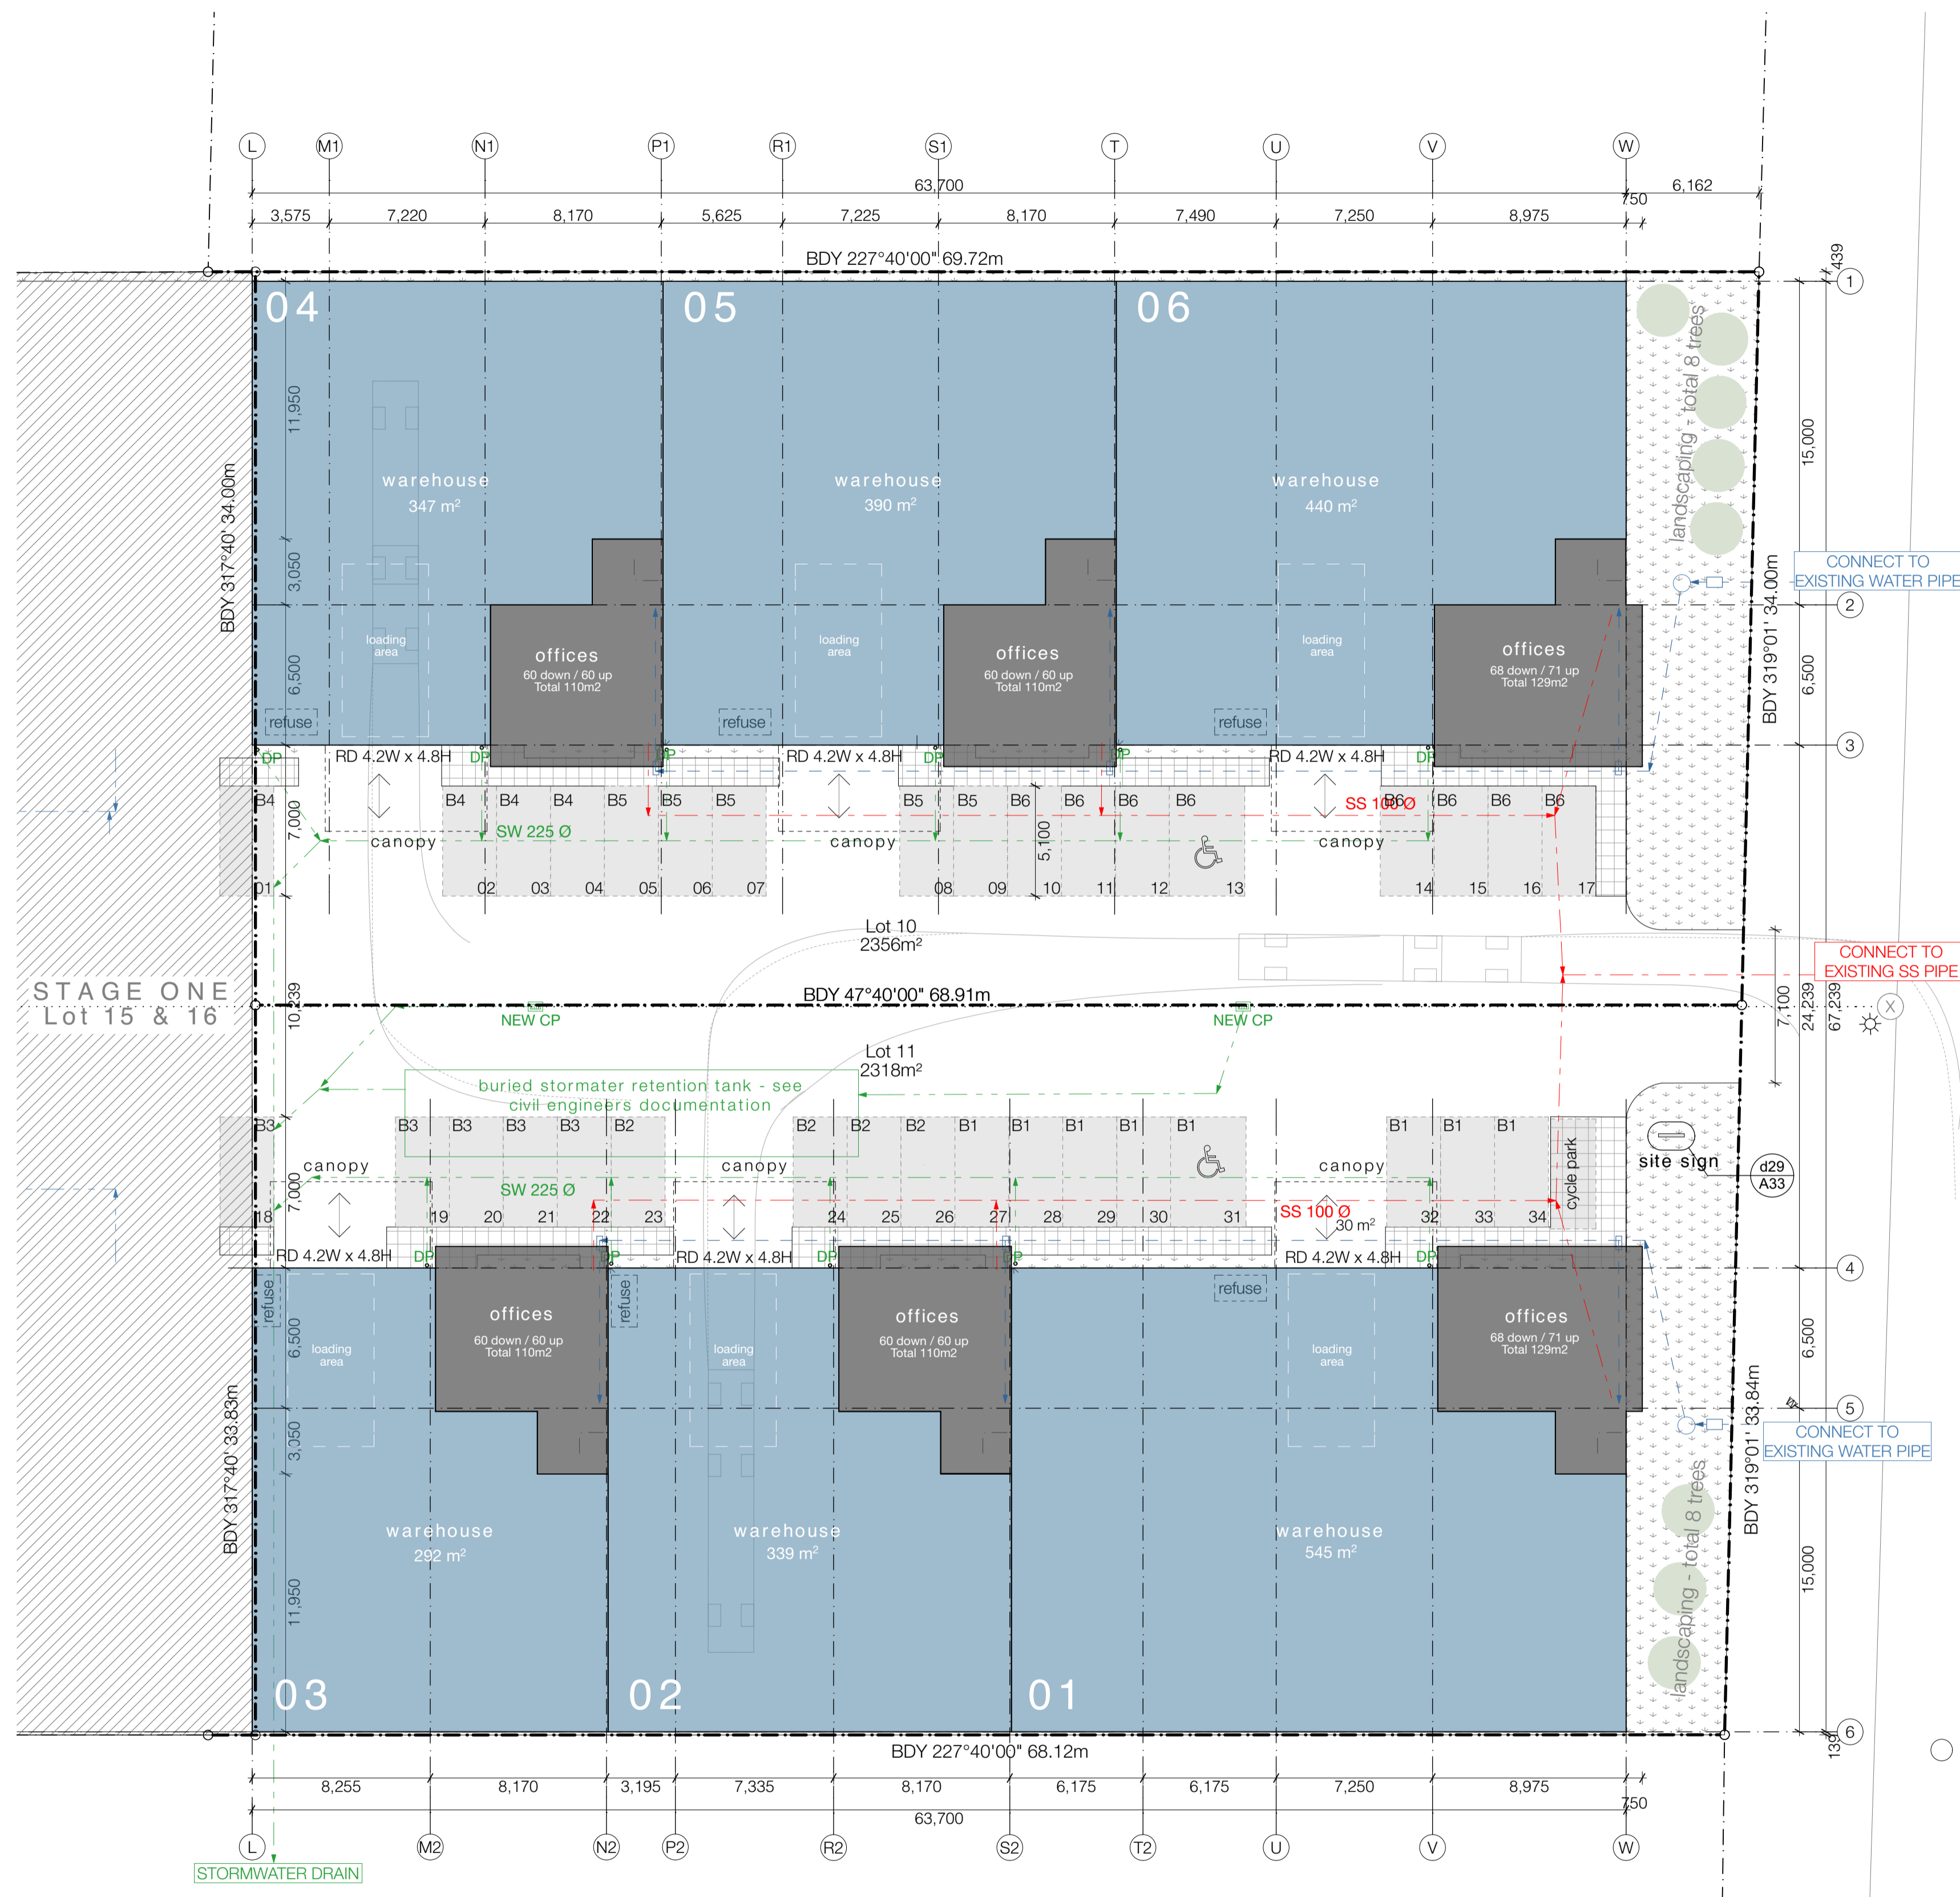

PROPERTY INFORMATION:

Subdivision:
Te Rapa Gateway Industrial Park,
Hamilton

Lot 10, Clem Newby Drive
site area: 2356m²
Lot 11, Clem Newby Drive
site area: 2318m²

total area: 4674m²

COVERAGE SUMMARY:

	buildings:	2,793m ² / 60%
	canopies:	180m ² / 4%
	soft landscape:	368m ² / 8%
	hard landscape:	107m ² / 2%
	impermeable: (vehicle circulation)	1226m ² / 26%

CAR PARKING:

2 accessible
32 car parks
total: 34 car parks

Building 01	= 8 parks
Building 02, 04	= 4 parks
Building 03, 05	= 5 parks
Building 06	= 8 parks

NOTE:
refer to civil engineers documentation for all site levels, civil design, and information beyond the line of the buildings.
all concrete party walls to be a minimum 150mm off the legal boundary.

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PROJECT:

Te Rapa Stage 2

CLIENT: Fosters Construction
SITE: Te Rapa Industrial Park, Hamilton

FOR CONSTRUCTION ISSUE

DRAWING TITLE:

PROPOSED SITE PLAN

PROJECT REF:		T0424 TE RAPA S2	
DATE:	SCALE:	25/06/19	1:200 @ A1
SHEET:	REV:	A02	C01

SITE WORKS KEY:

- asphalt
- Concrete paving - broom finish to match 'Stage 1'
- landscaping
- site contours
- proposed water line
- proposed SW line
- proposed SS line
- proposed downpipe

NOTE:


all pedestrian pathways across the roller door entry access are to comply with NZBC D1/AS1 and provide a maximum 20mm change in finished paving level.

fall all warehouse entry thresholds 1:50 away from building, ensure all slab rebates allow for all door + window thresholds.

all concrete party walls to be a minimum 150mm off the legal boundary.

all external pathways and transitions to comply with nzbc d1/as1.

All site works plans set out, site layout and scope of finishes, please refer to civil engineers information for all engineering requirements.

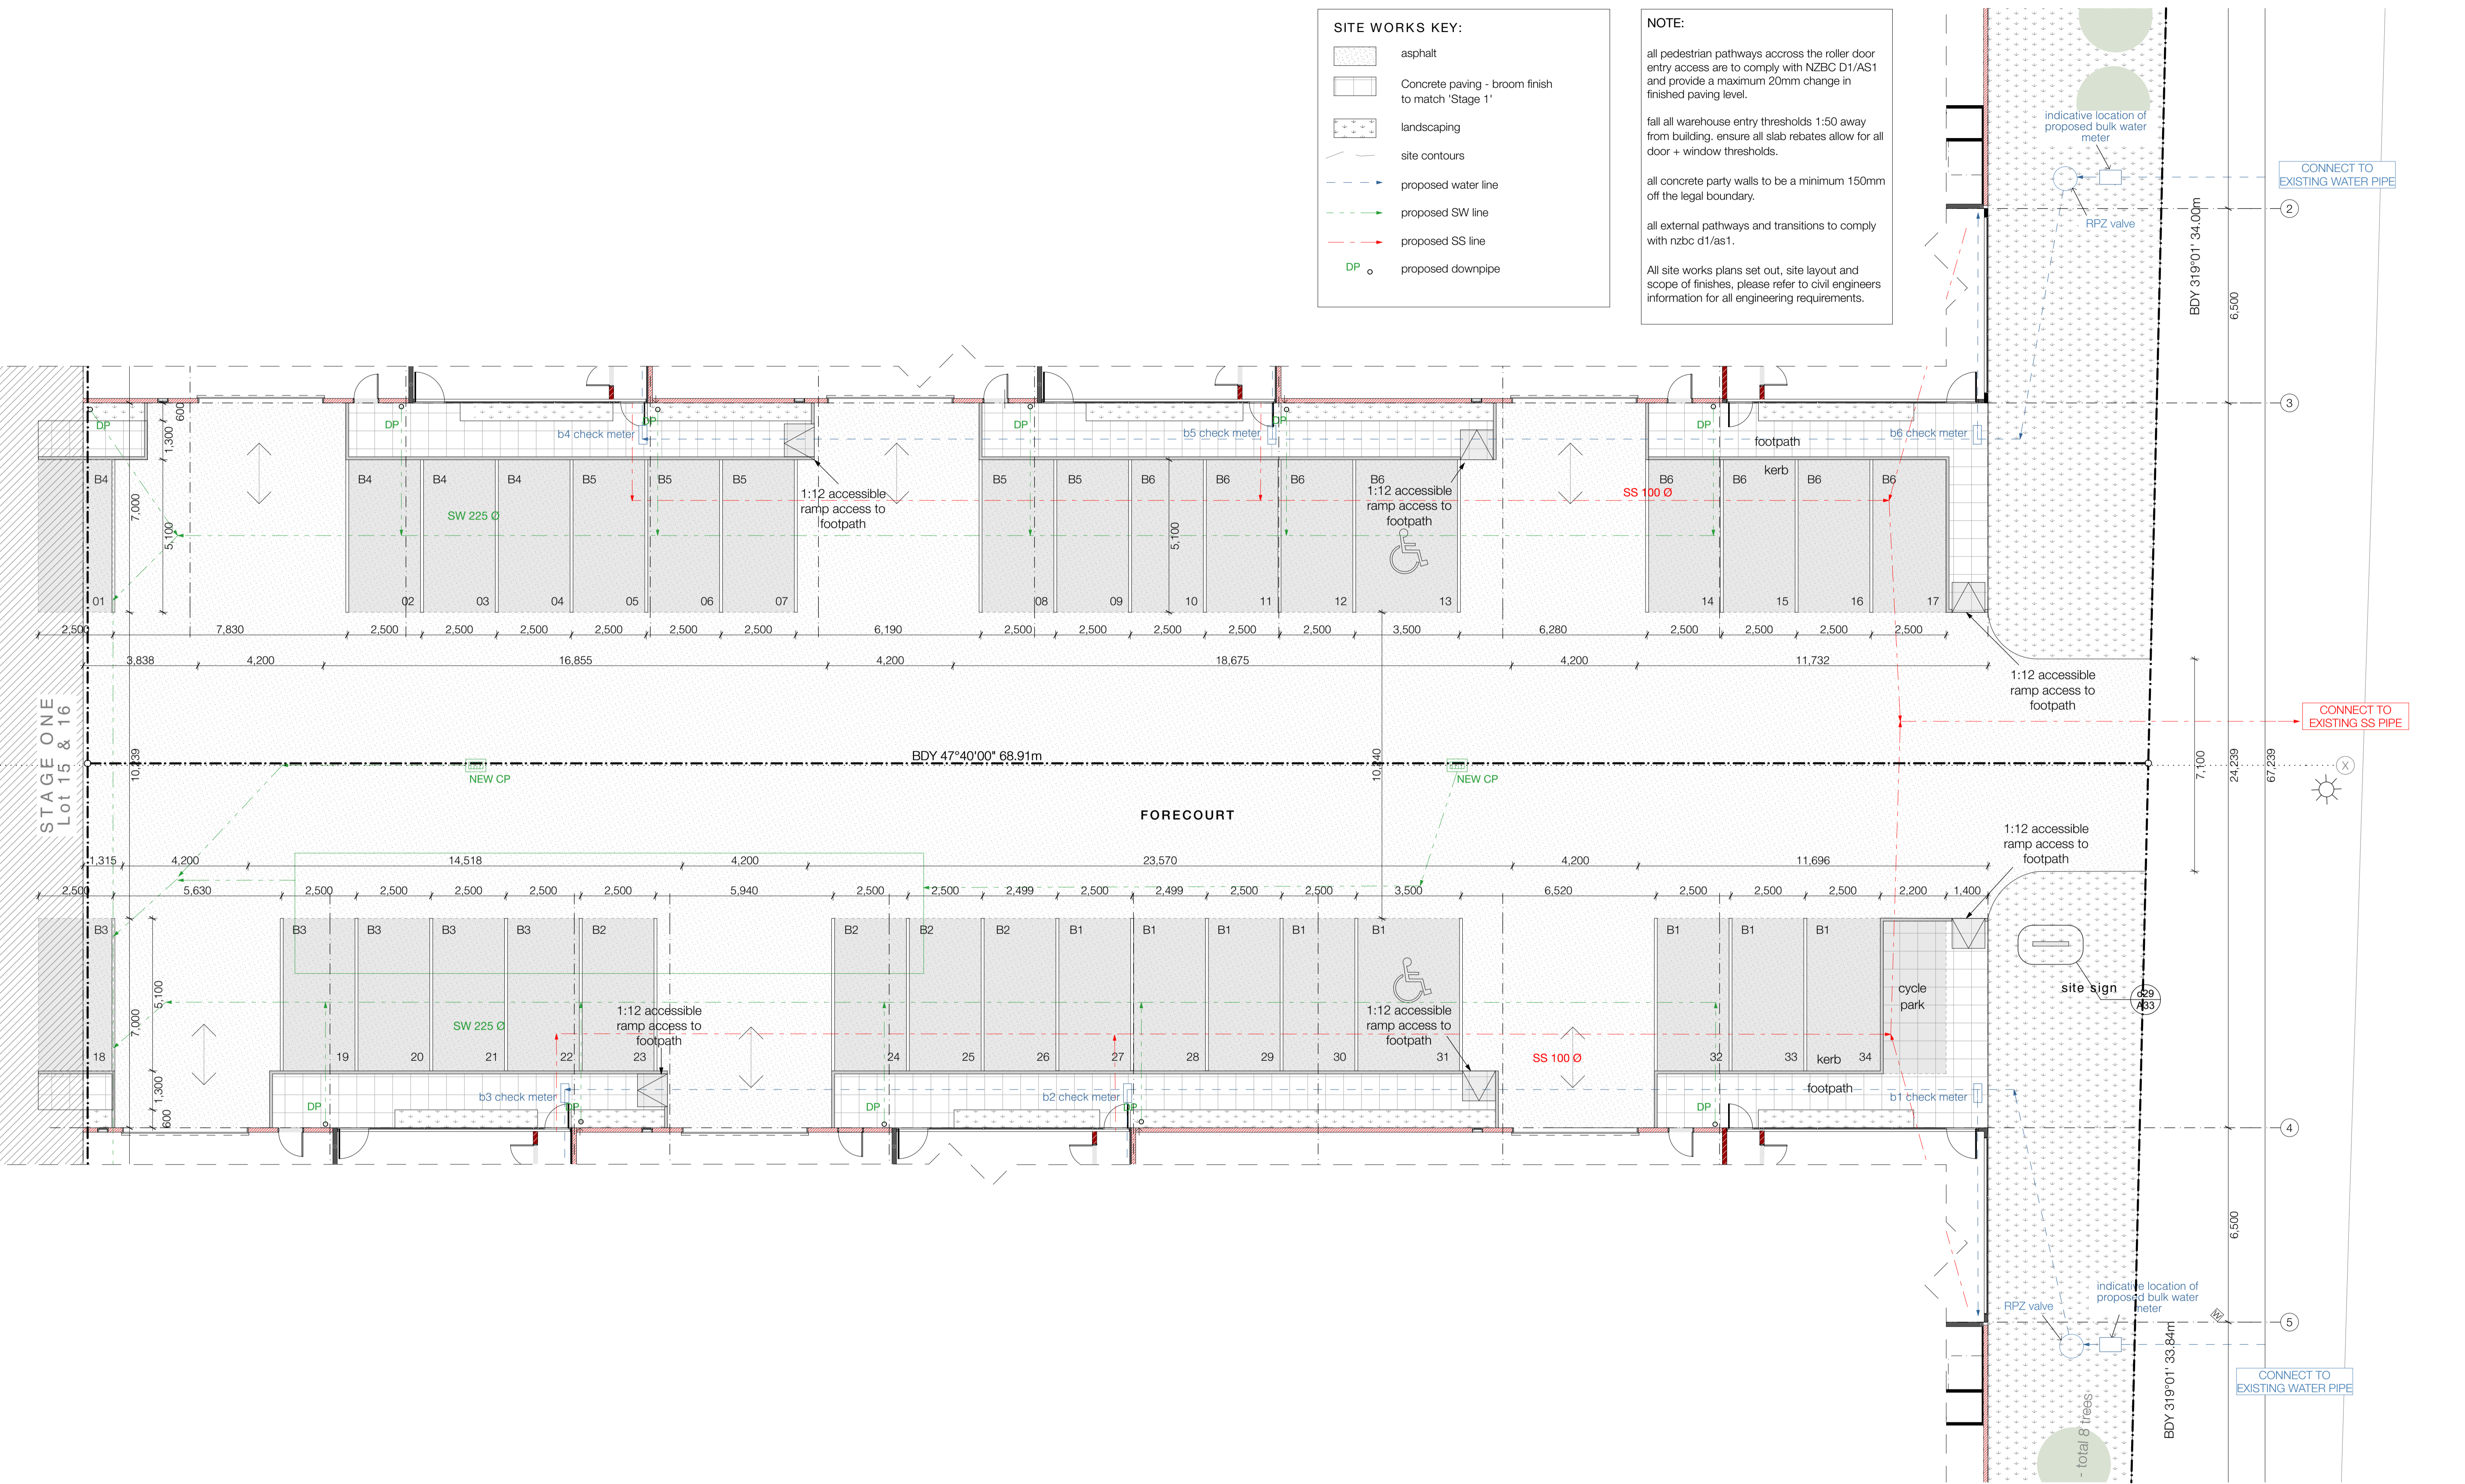

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PROJECT:

Te Rapa Stage 2


CLIENT: Fosters Construction
SITE: Te Rapa Industrial Park, Hamilton

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DRAWING TITLE:

PROPOSED SITE WORKS PLAN

PROJECT REF:		T0424 TE RAPA S2	
DATE:	25/06/19	SCALE:	1:100 @ A1
SHEET:	A03	REV:	C01

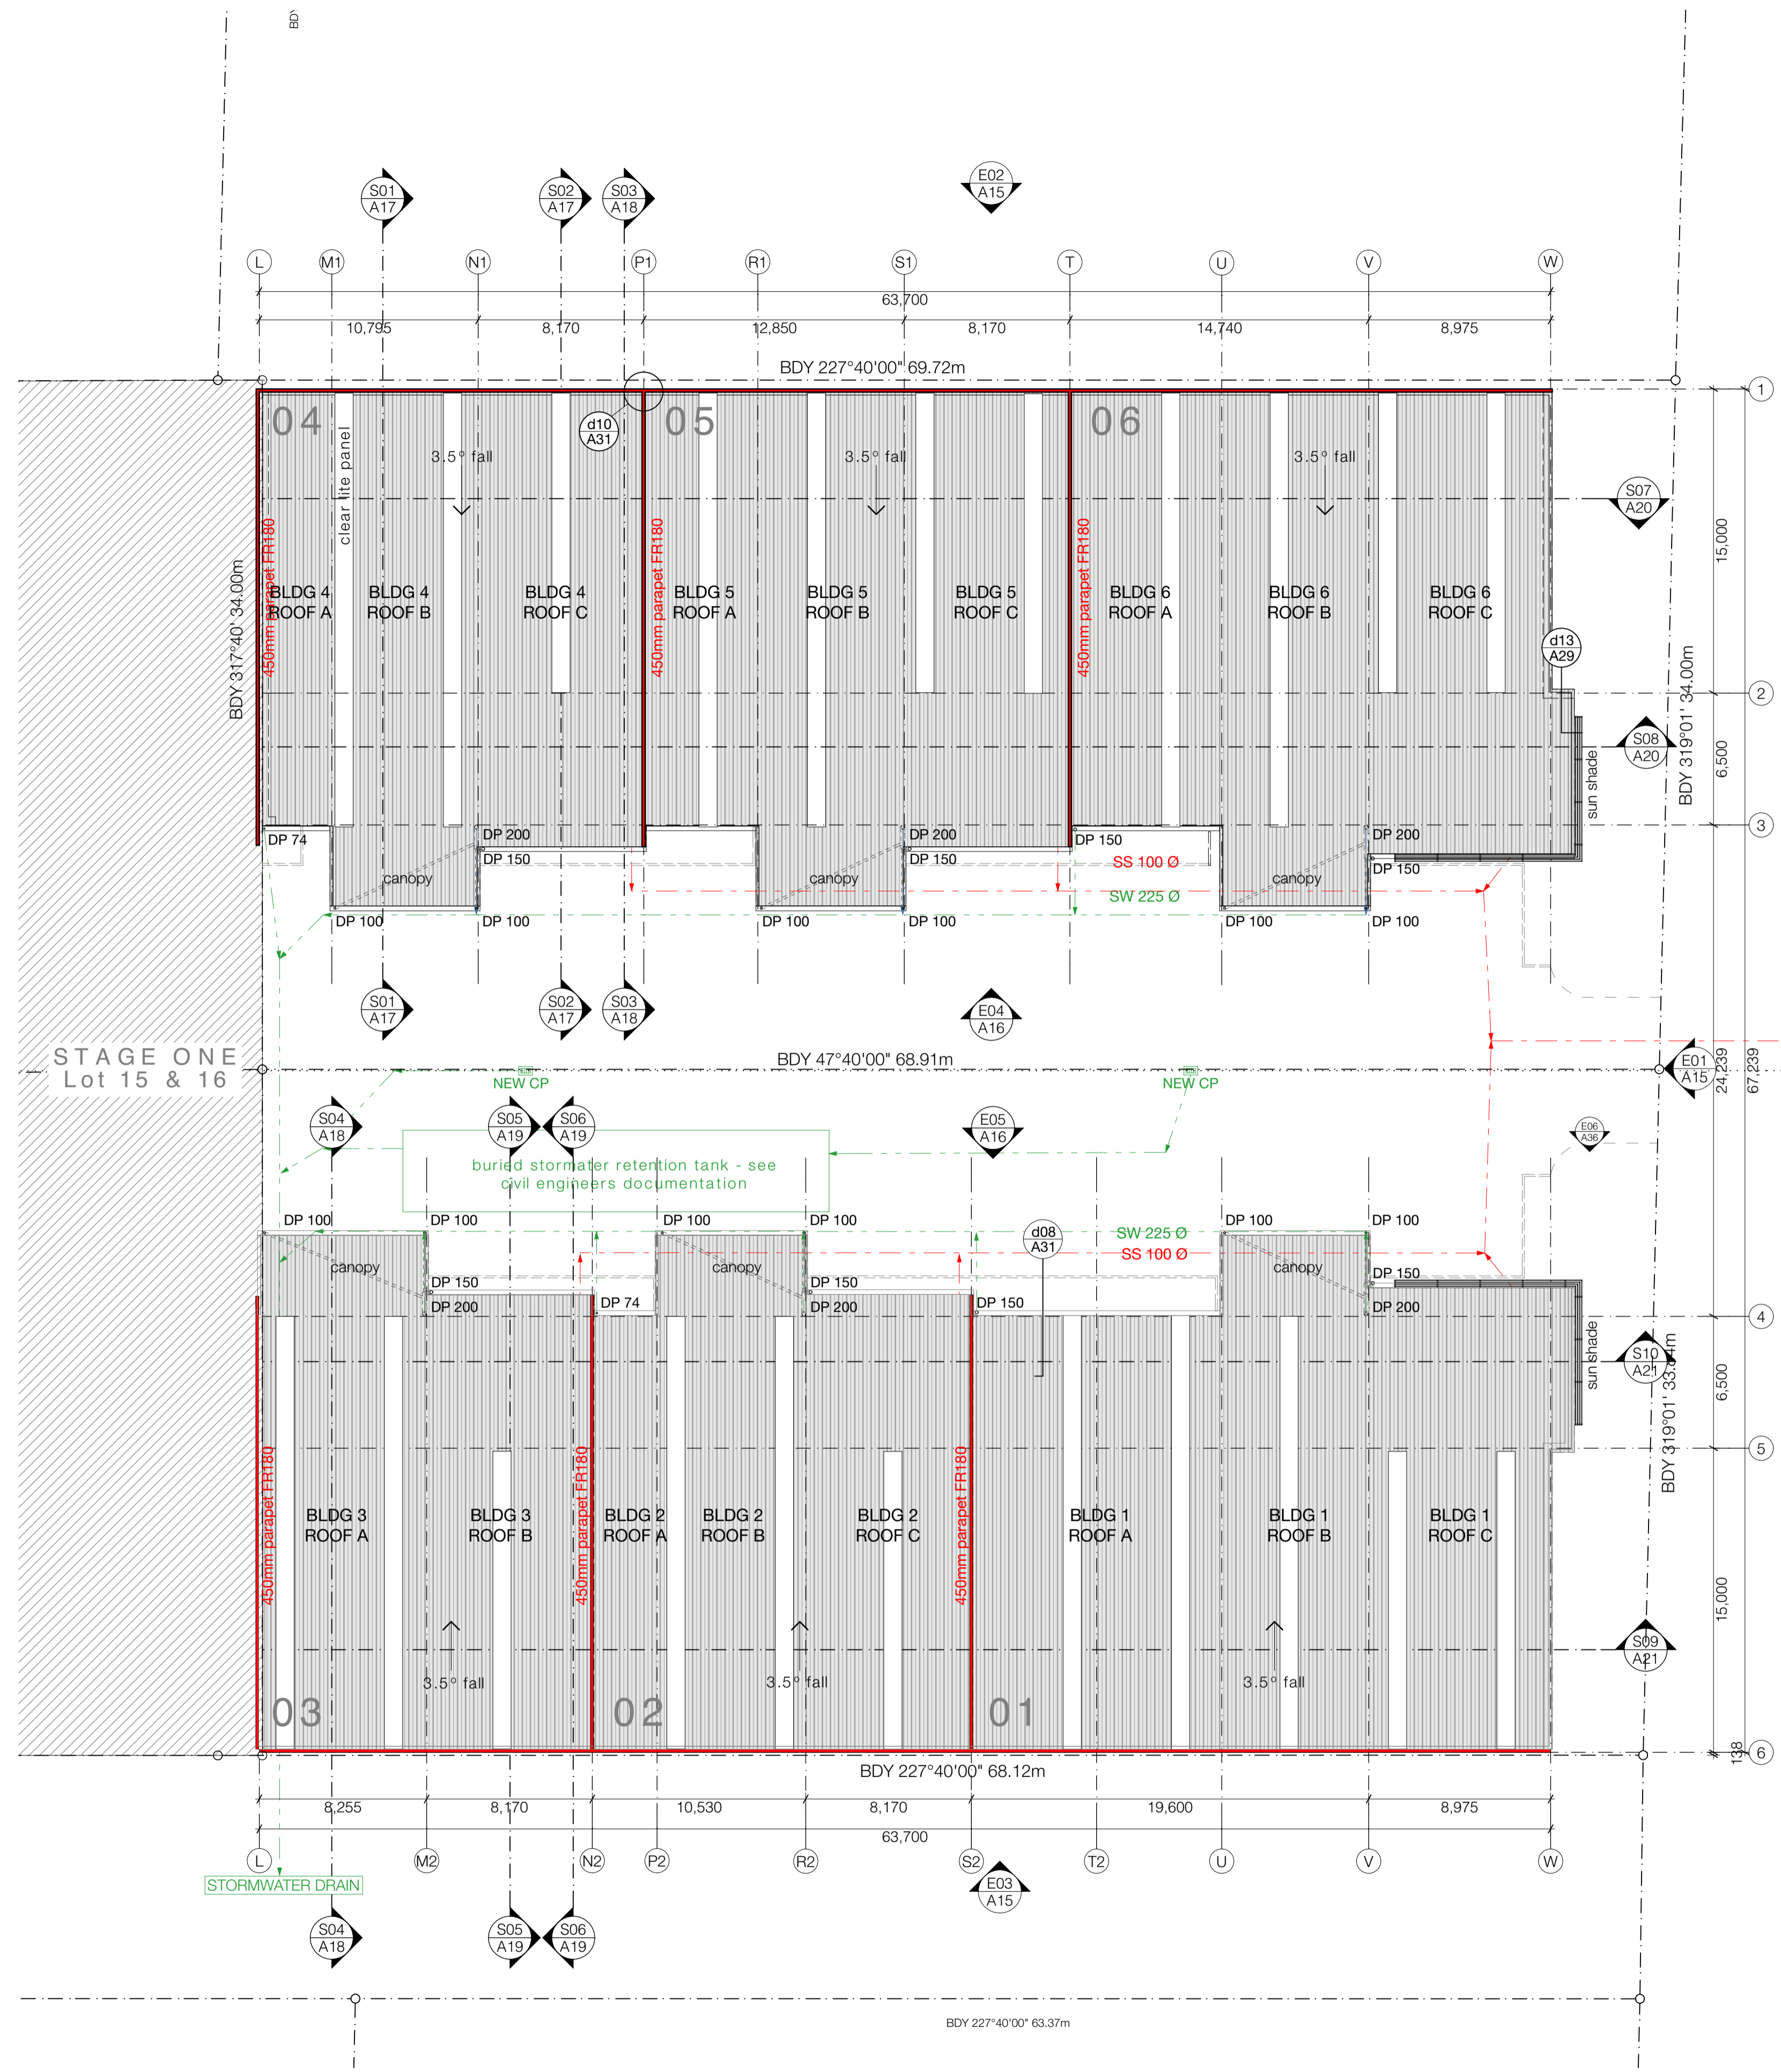

ROOF PLAN KEY:

- 0.55 BMT Dimond BB900 profiled COLOURSTEEL roofing with ENDURA finish over selected THERMAKRAFT roofing underlay over safety mesh on roof structure. Office roof cavity insulated with AUTEX greenstuf insulation to achieve min. R3.0.
- AMPELITE SL translucent sheet roofing to match profile of roof fixed over THERMAKRAFT safety mesh on roof structure - to provide 15% daylighting to warehouse space.
- DP 150 150mm dia. uPVC D.P to be connected into new S.W line

note: refer fire engineers report for all fire rating requirements between cells.

ROOF CALCULATIONS:	
BUILDING 01	
ROOF A roof area:	261m ²
min. ext gutter cross sectional area:	22,000mm ²
min. gutter:	175 box gutter 150 dia
ROOF B roof area:	190m ²
min. ext gutter cross sectional area:	17,500mm ²
min. gutter:	175 box gutter 100 dia
ROOF C roof area:	213m ²
min. ext gutter cross sectional area:	18,500mm ²
min. gutter:	175 box gutter 150 dia
BUILDING 02	
ROOF A roof area:	65m ²
min. ext gutter cross sectional area:	7,000mm ²
min. gutter:	125 box gutter 74 dia
ROOF B roof area:	190m ²
min. ext gutter cross sectional area:	17,500mm ²
min. gutter:	175 box gutter 100 dia
ROOF C roof area:	181m ²
min. ext gutter cross sectional area:	17,000mm ²
min. gutter:	175 box gutter 150 dia
BUILDING 03	
ROOF A roof area:	213m ²
min. ext gutter cross sectional area:	18,500mm ²
min. gutter:	175 box gutter 100 dia
ROOF B roof area:	181m ²
min. ext gutter cross sectional area:	17,000mm ²
min. gutter:	175 box gutter 150 dia
BUILDING 04	
ROOF A roof area:	76m ²
min. ext gutter cross sectional area:	8,000mm ²
min. gutter:	125 box gutter 74 dia
ROOF B roof area:	190m ²
min. ext gutter cross sectional area:	17,500mm ²
min. gutter:	175 box gutter 100 dia
ROOF C roof area:	181m ²
min. ext gutter cross sectional area:	17,000mm ²
min. gutter:	175 box gutter 150 dia
BUILDING 05	
ROOF A roof area:	118m ²
min. ext gutter cross sectional area:	12,000mm ²
min. gutter:	175 box gutter 100 dia
ROOF B roof area:	190m ²
min. ext gutter cross sectional area:	17,500mm ²
min. gutter:	175 box gutter 100 dia
ROOF C roof area:	181m ²
min. ext gutter cross sectional area:	17,000mm ²
min. gutter:	175 box gutter 150 dia
BUILDING 06	
ROOF A roof area:	158m ²
min. ext gutter cross sectional area:	15,000mm ²
min. gutter:	175 box gutter 150 dia
ROOF B roof area:	190m ²
min. ext gutter cross sectional area:	17,500mm ²
min. gutter:	175 box gutter 100 dia
ROOF C roof area:	213m ²
min. ext gutter cross sectional area:	18,500mm ²
min. gutter:	175 box gutter 150 dia

CONNECT TO EXISTING SS PIPE

FOR CONSTRUCTION ISSUE

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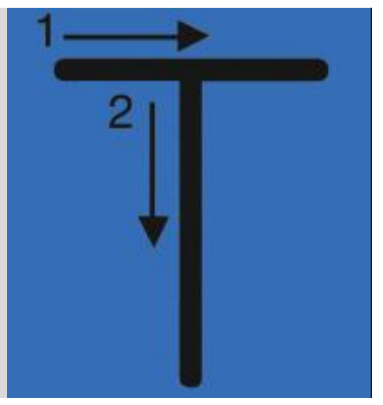
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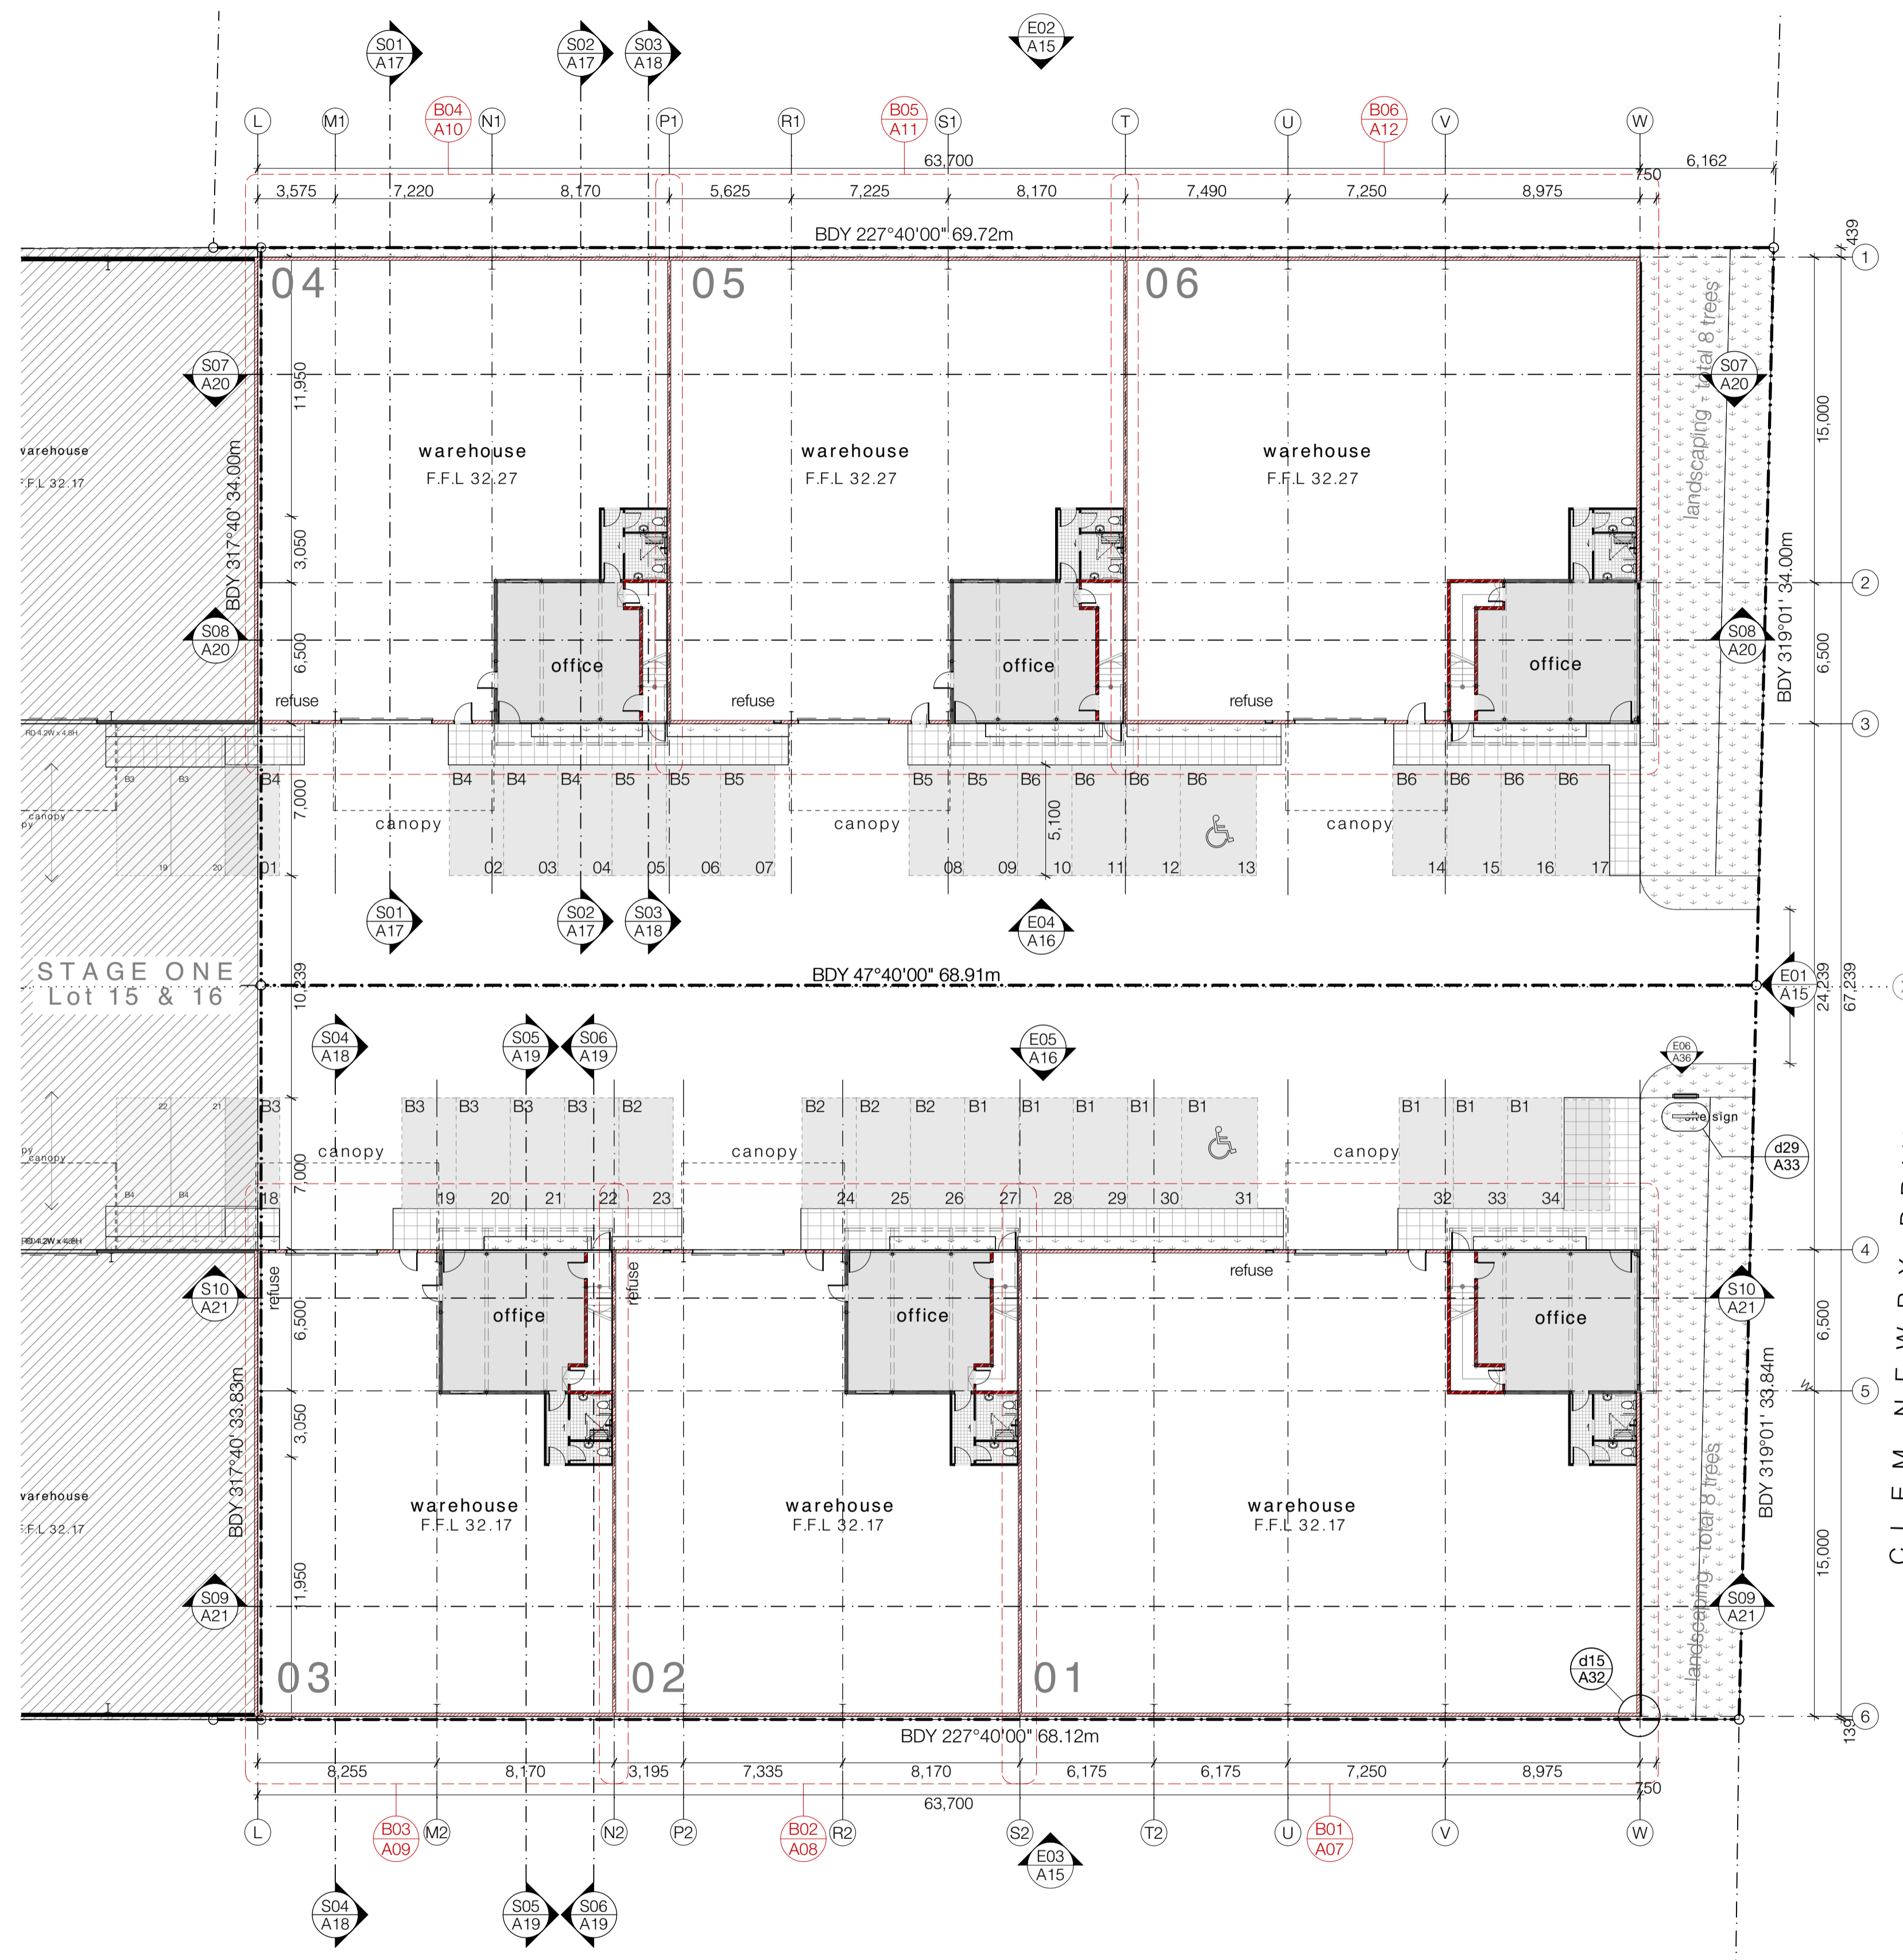


PROJECT:
Te Rapa Stage 2

CLIENT: Fosters Construction
SITE: Te Rapa Industrial Park, Hamilton

DRAWING TITLE:
PROPOSED ROOF + DRAINAGE PLAN

PROJECT REF: T0424 TE RAPA S2	
DATE: 25/06/19	SCALE: 1:200 @ A1
SHEET: A04	REV: C01



Ground Floor GIA Summary:

Building	Warehouse	Office	Amenities
BUILDING 01	534 m ²	58 m ²	12 m ²
BUILDING 02	331 m ²	50 m ²	12 m ²
BUILDING 03	284 m ²	50 m ²	12 m ²
BUILDING 04	339 m ²	50 m ²	12 m ²
BUILDING 05	381 m ²	50 m ²	12 m ²
BUILDING 06	431 m ²	58 m ²	12 m ²

NOTE:

all water check meters to be located within garden berms out front of building.

all pedestrian pathways across the roller door entry access are to comply with NZBC D1/AS1 and provide a maximum 20mm change in finished paving level.

fall all warehouse entry thresholds 1:50 away from building. ensure all slab rebates allow for all door + window thresholds.

all concrete party walls to be a minimum 150mm off the legal boundary.

refer civil engineers design documentation for all information beyond the external line of the buildings.

all external pathways and transitions to comply with nzbc d1/as1

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PROJECT: Te Rapa Stage 2


CLIENT: Fosters Construction
SITE: Te Rapa Industrial Park, Hamilton

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DRAWING TITLE: PROPOSED GROUND FLOOR PLAN

PROJECT REF: T0424 TE RAPA S2

DATE: 25/06/19	SCALE: 1:200 @ A1
SHEET: A05	REV: C01

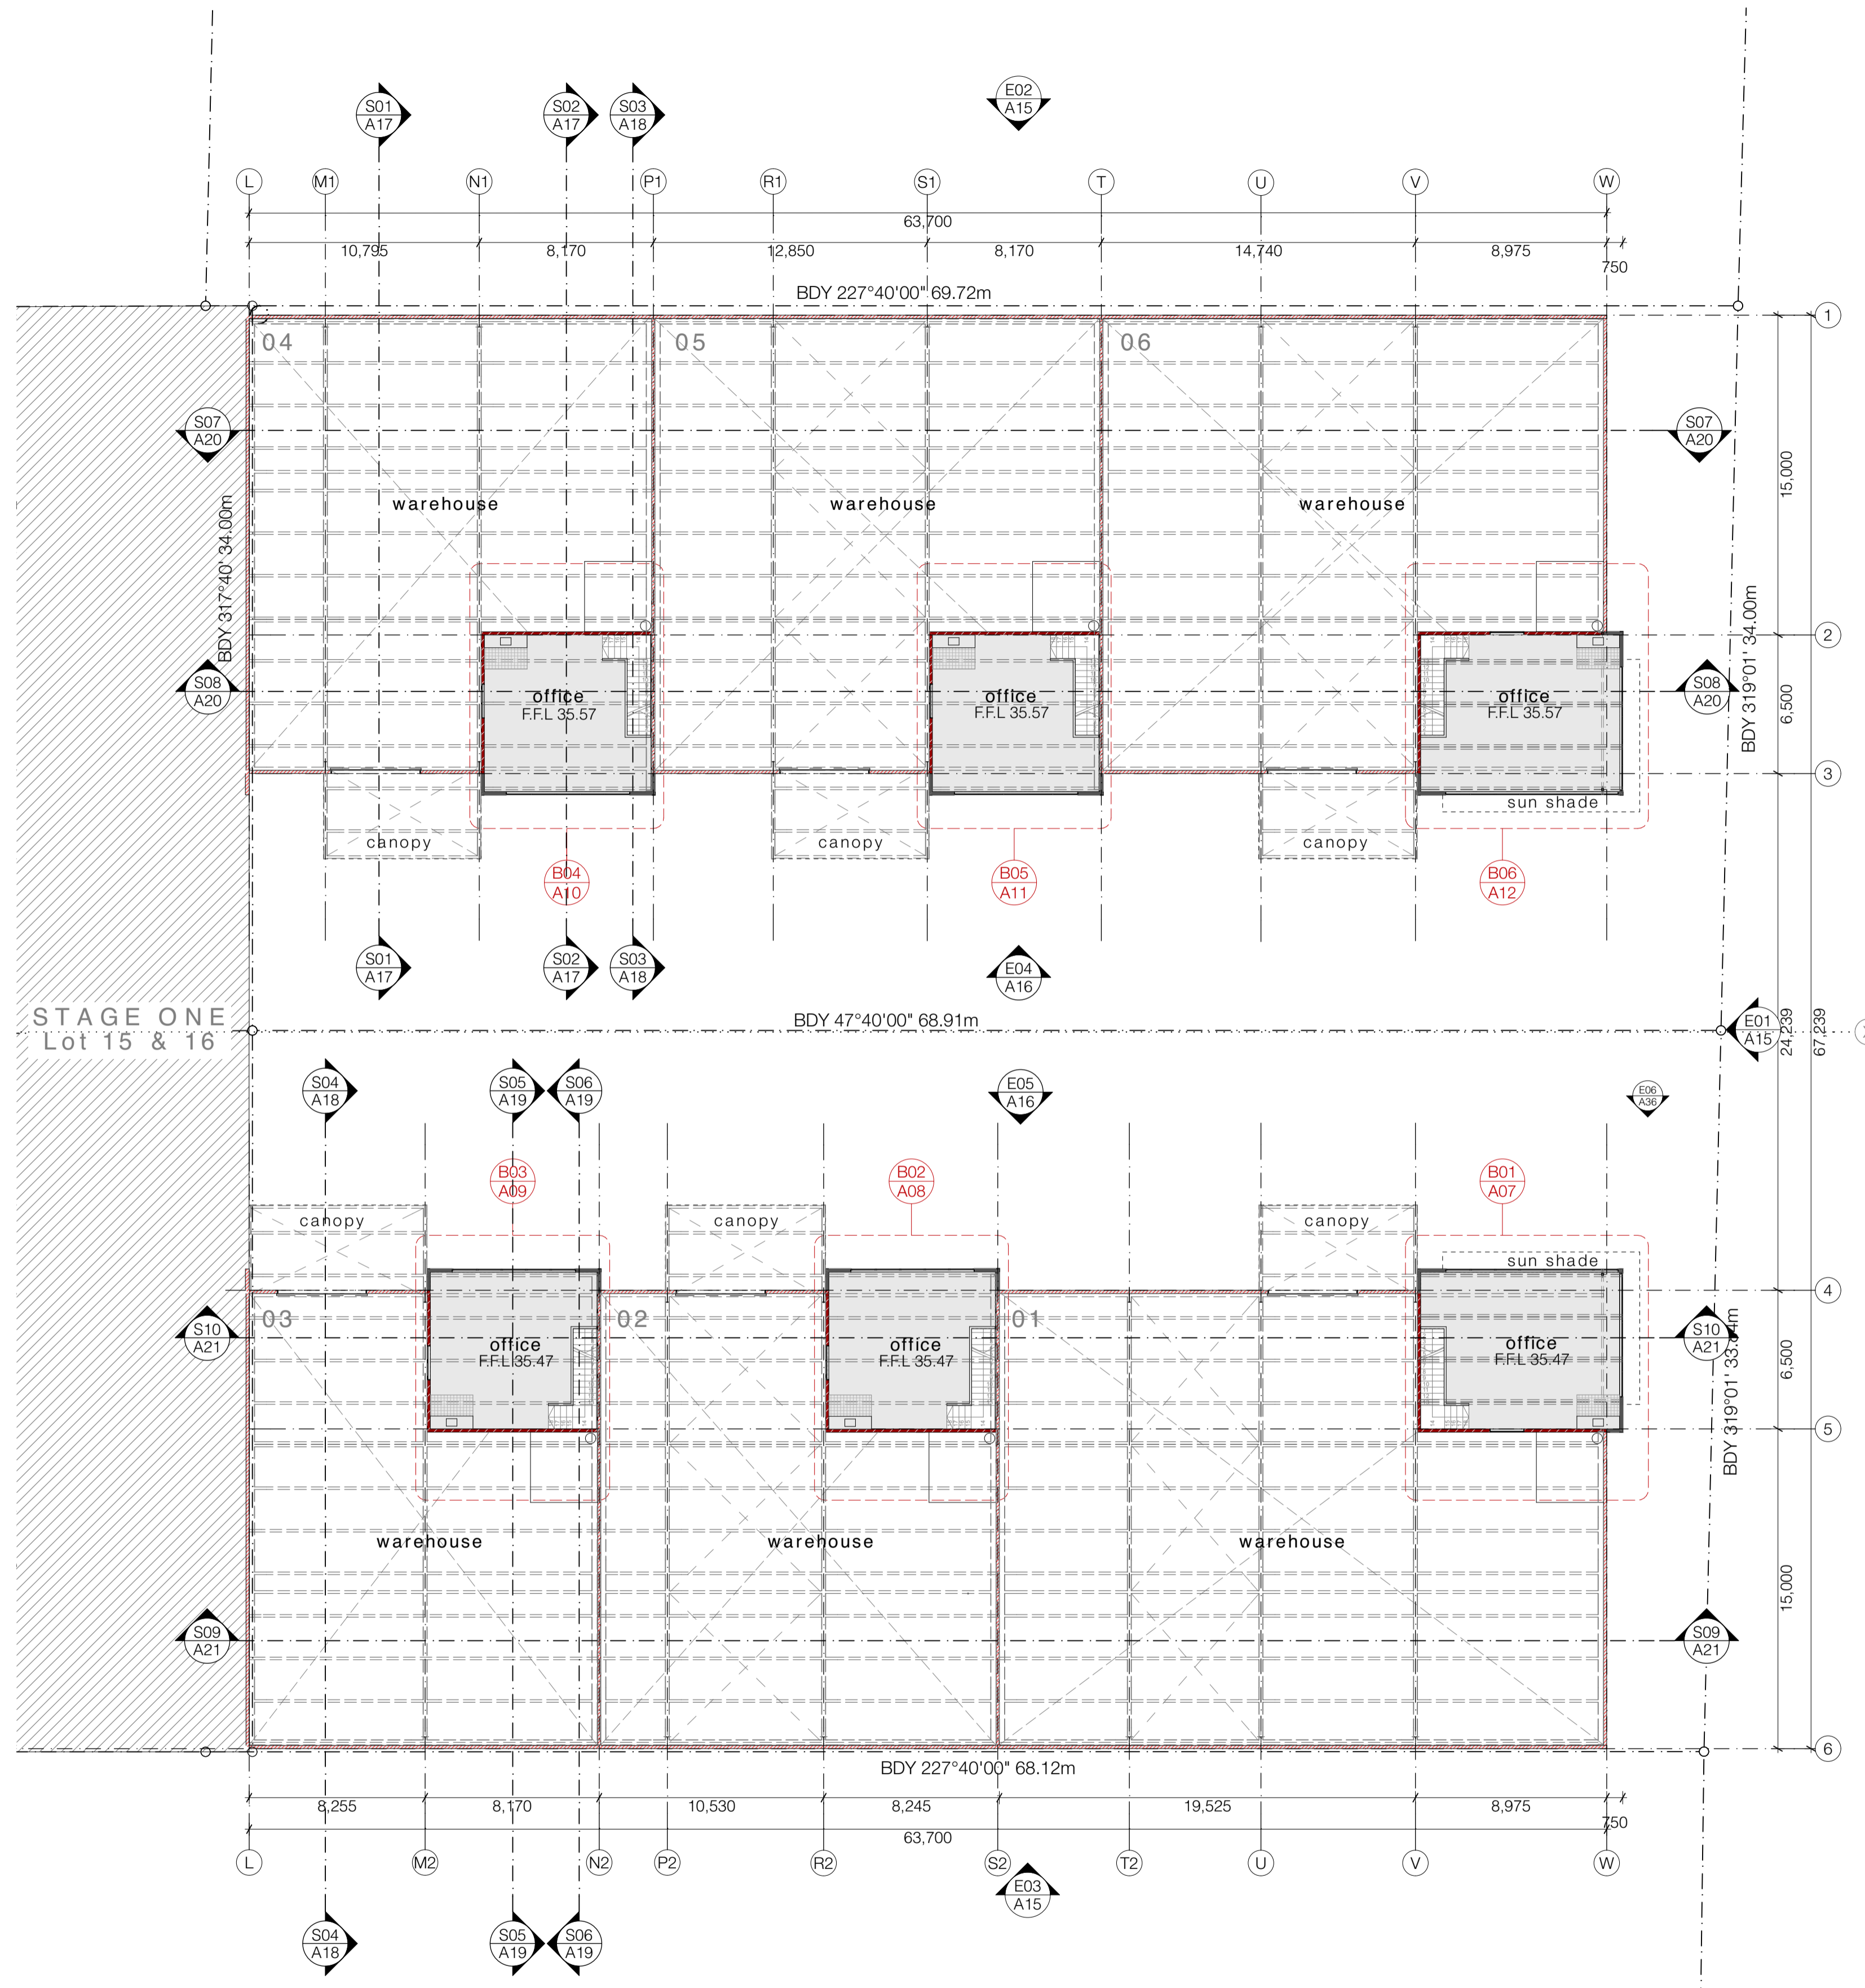

First Floor GIA Summary:

BUILDING 01	office	65.5 m ²
	stairs	5.5 m ²
BUILDING 02	office	54.5 m ²
	stairs	5.5 m ²
BUILDING 03	office	54.5 m ²
	stairs	5.5 m ²
BUILDING 04	office	54.5 m ²
	stairs	5.5 m ²
BUILDING 05	office	54.5 m ²
	stairs	5.5 m ²
BUILDING 06	office	65.5 m ²
	stairs	5.5 m ²

CLEM NEWBY DRIVE

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PROJECT:
Te Rapa Stage 2

CLIENT: Fosters Construction
SITE: Te Rapa Industrial Park, Hamilton

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DRAWING TITLE:
PROPOSED FIRST FLOOR PLAN

PROJECT REF: T0424 TE RAPA S2	
DATE: 25/06/19	SCALE: 1:200 @ A1
SHEET: A06	REV: C01

roof:

- RT01** Roof: 0.55 BMT Dimond BB900 profiled COLORSTEEL roofing with ENDURA finish over selected THERMADRAFT COVERTEK 405 roofing underlay over safety mesh on roof structure. Office roof cavity insulated with AUTEX greenstuf insulation to achieve min. R3.0
- RT02** External gutter: 0.55 BMT box gutter with COLORSTEEL ENDURA finish fixed with hidden brackets to manufacturers specification.
- RT03** Parapet / apron roof flashings: 0.55 BMT machine folded flashings with COLORSTEEL ENDURA finish.
- RT04** Warehouse roof skylight: AMPELITE SL translucent sheet roofing to match profile of roof fixed over THERMADRAFT ALUMESH safety mesh (galv. coated) on roof structure - to provide 15% daylighting to warehouse space.
- RT05** Canopy Roof & Soffit: 0.55 BMT Dimond BB900 profiled COLORSTEEL roofing with ENDURA finish over roof structure and to underside of soffit to provide bird proofing.

ceiling:

- CT01** Internal office ceiling: USG DONN DX suspended ceiling grid system with selected 1200x600 mineral fibre ceiling tiles SLT edged.
- CT02** Internal ceiling: 13mm GIB AQUALINE ceiling lining fixed to ex75x40mm SG8 timber battens @ 600 crs on 140x45mm joists @ 450 crs covered with 19mm marine ply. Max load 1.5kPa.
- CT03** Underside of stairs: 16mm GIB FYRLINE lining to underside of timber stair structure in accordance with GIB spec - GBFC60. FR 60/60/60 fire rated lining to extend through to fire rated wall structure

walls:

- WT01** 150mm FR 180/180/180 thick pre-cast concrete panel walls - refer structural and fire engineers documentation.
- WT02** Office fire walls: FR 60/60/60 ex150x50 SG8 wall framing with studs at 600 centres lined with 13mm GIB FYRLINE lining to both sides in accordance with GIB specification - GBT.L60. Walls to extend to underside of roof above.
- WT03** external walls: ex150x50 SG8 wall framing with studs at 600 centres lined with 13mm standard GIB board inside in accordance with GIB specification - GBUW 15. Walls to extend to underside of roof above.
- WT04** Internal walls: ex100x50 SG8 wall framing with studs at 600 centres lined with 10mm standard GIB board lining to interior. 10mm GIB AQUALINE to be used in wet areas. Where vinyl is continued up wall WPS water proofing membrane to be used in strict accordance with manufacturers specification. Face of office walls to warehouse finished with 9.5mm selected plywood to a height of 2.4m above finished floor level.
- WT05** Office cladding: METALCRAFT KAHU cladding with COLORSTEEL ENDURA finish fixed vertically over 20mm cavity battens over COVERTEK 403 building wrap on ex150x50 SG8 wall framing with studs at 600 centres. Insulated cavity with AUTEX insulation min R2.5
- WT06** Warehouse wall cladding: METALCRAFT KAHU cladding with COLORSTEEL ENDURA finish fixed horizontally over 20mm cavity battens over COVERTEK 403 building wrap on precast concrete panel walls.
- WT07** Joinery: VANTAGE external window 125 FLUSHGLAZE suite in seismic frames with powder coated finish and Magnum door.
- WT08** Joinery: VANTAGE 40 external window METRO suite with powder coated finish.
- WT09** Roller door: METALBILT motorised roller shutter door powder coated finish on windsocks all with metal chain and manual back-up.
- WT10** Horizontal sun screens: INSOL zenith AI sun screen with selected powdercoat finish. Refer manufacturers specifications for all fixings and structural information.
- WT11** Internal strapped walls: ex50x50 SG8 timber strapping at 600 centres with 10mm standard GIB board lining to interior. 10mm GIB AQUALINE to be used in wet areas. AUTEX batt insulation to provide min. R2.5
- WT12** Internal walls: ex150x50 SG8 wall framing with studs at 600 centres lined with 10mm standard GIB board lining to interior. 10mm GIB AQUALINE to be used in wet areas. Where vinyl is continued up wall WPS water proofing membrane to be used in strict accordance with manufacturers specification. Face of office walls to warehouse finished with 9.5mm selected plywood to a height of 2.4m above finished floor level.

floors:

- FT01** Warehouse floor: 150mm thick reinforced concrete slab foundation on DPM and sand blinding on minimum 150mm thick compacted hard fill - refer structural engineers documentation for all structural information.
- FT02** Office ground floor: 150mm thick reinforced concrete slab foundation on DPM and sand blinding on minimum 150mm thick compacted hard fill - refer structural engineer.
- FT03** Office first floor: FRR 60/60/60 150mm thick Comfor - refer structural engineer.
- FT04** Selected commercial grade vinyl flooring

structural:

- ST01** Structural framing - refer structural engineer documentation for all structural detail.

note:

All materials, fittings, fixtures, and finishes to be established in strict accordance with manufactures specification.

This architectural documentation is to be read in conjunction with all specialist documentation and reports. Refer to engineering documentation for all engineering requirements.


fire design requirements:

All precast concrete panel walls to provide FR 180/180/180 (150 thick). Ground floor office to be fire rated and separate to the first floor fire cell - all fire rated FR 60/60/60. All supporting structure, stairs and underside of floors to be fire rated FR 60/60/60.

FD FD = fire door. Refer fire report for all fire design requirements.

W03 Window joinery - Refer D & W schedule


Refer finishes plans for floor, wall & ceiling finishes

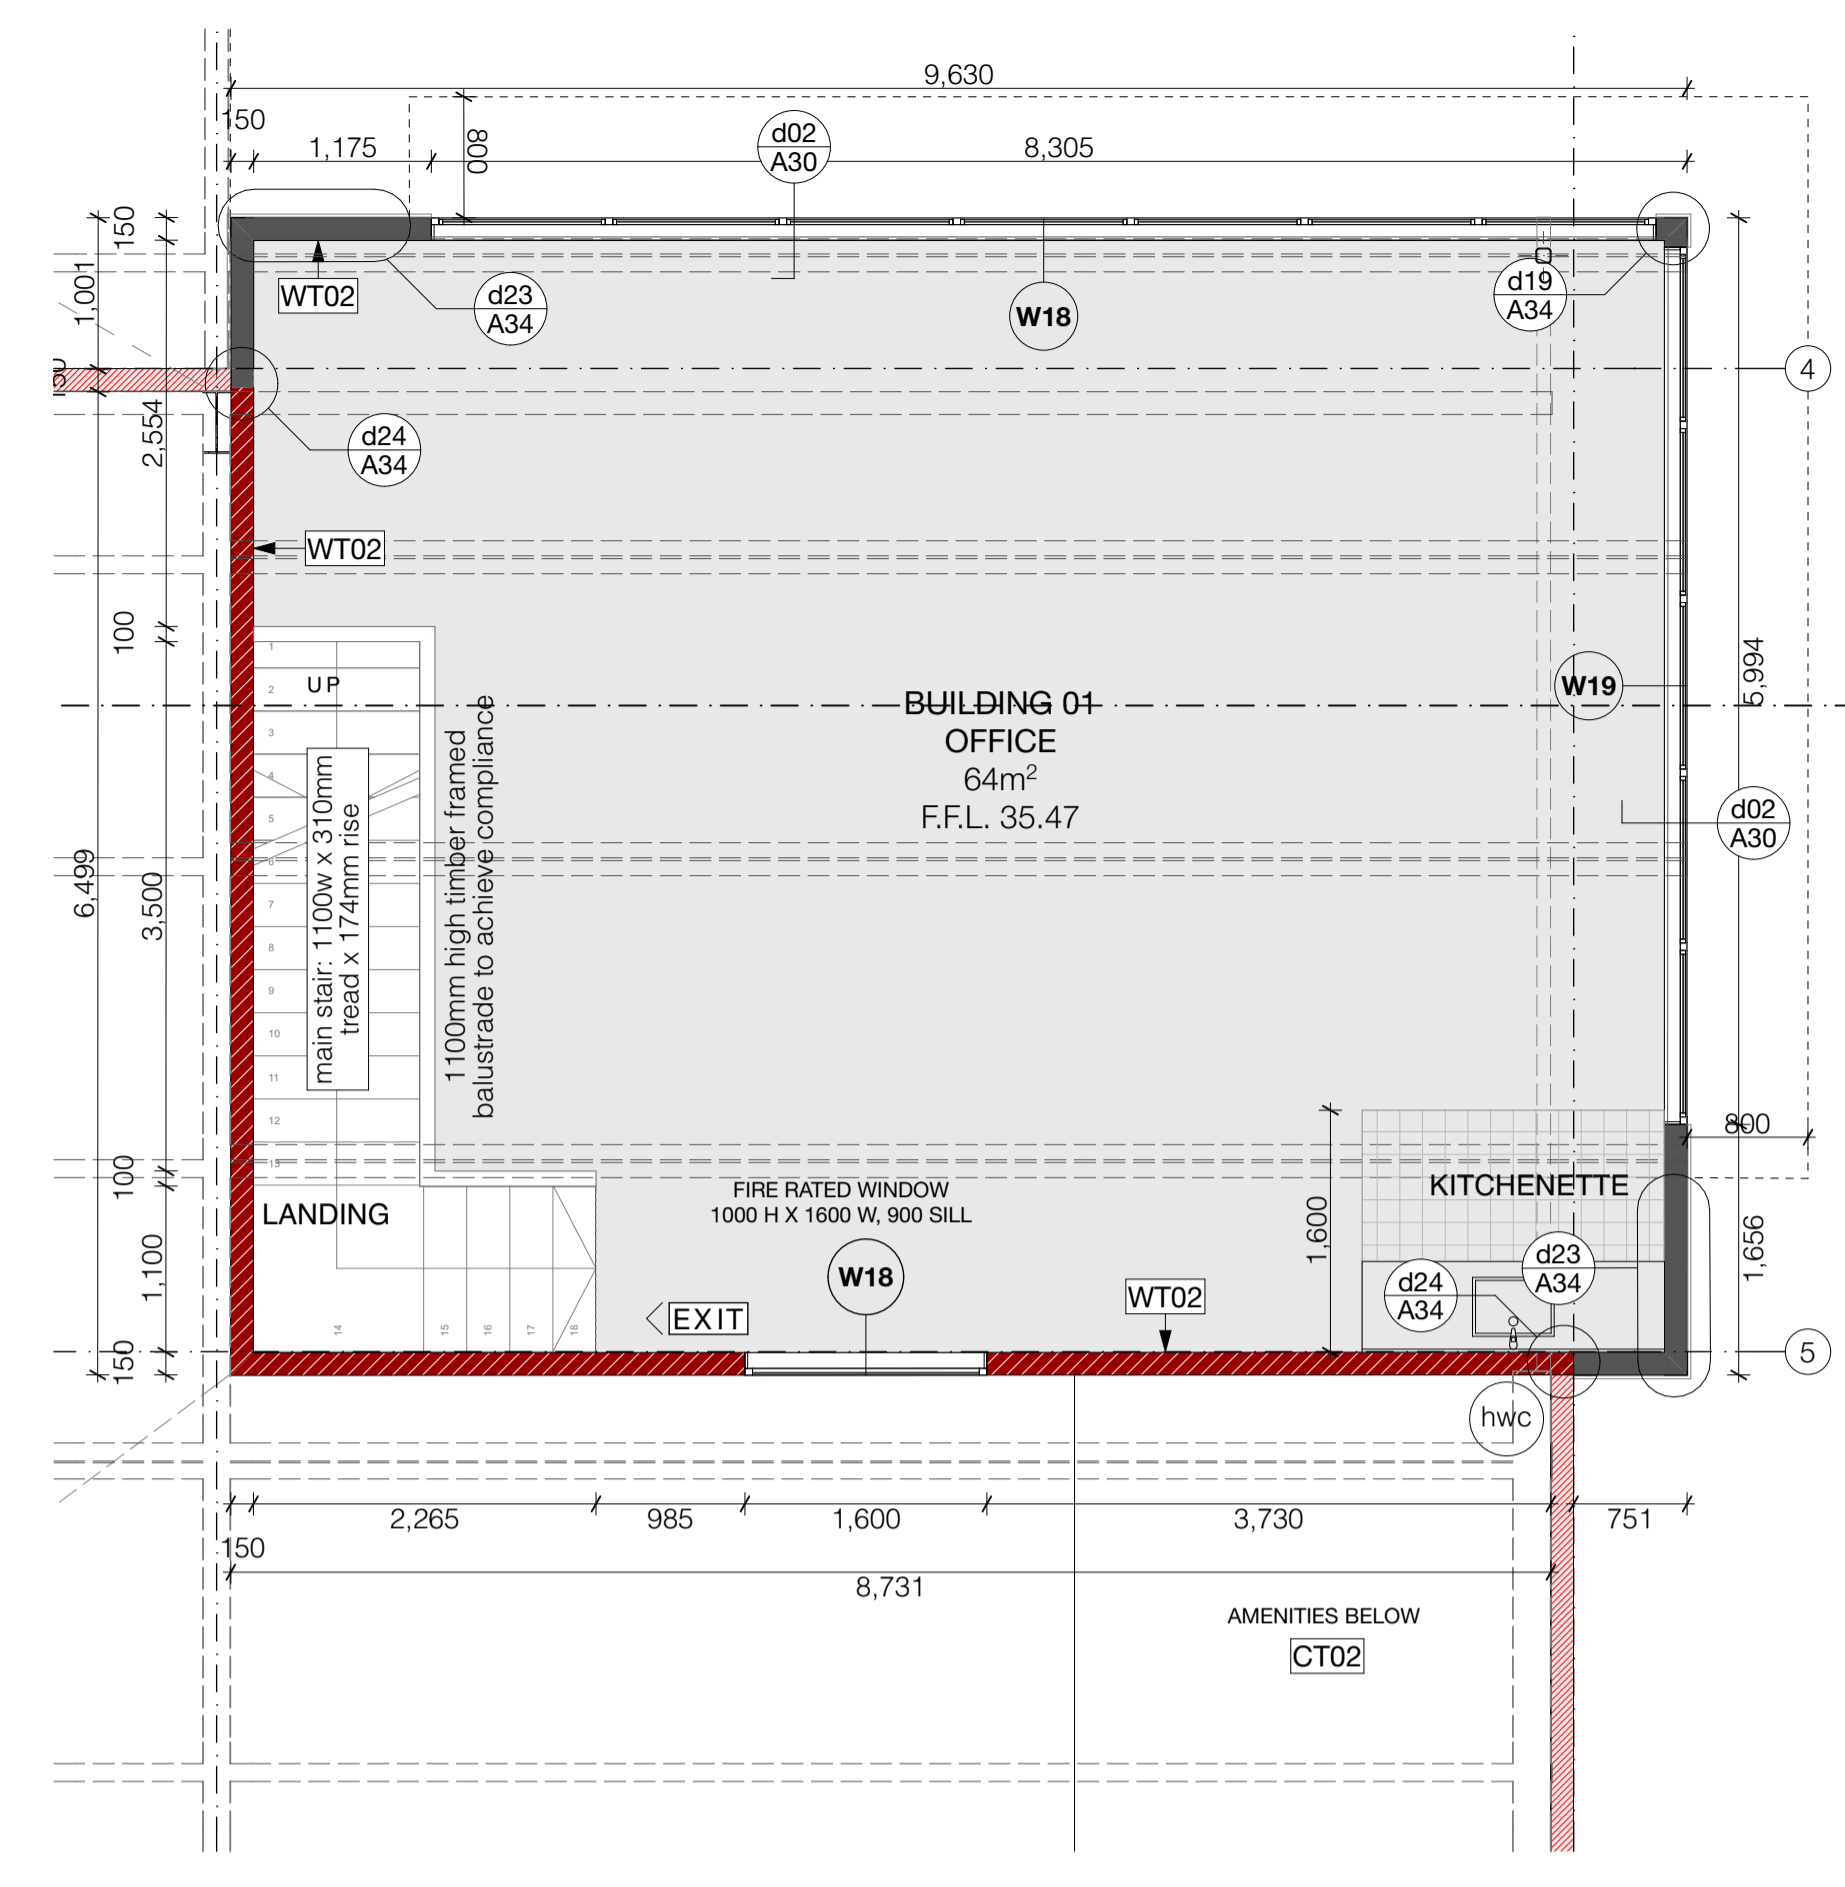

FIRST FLOOR PLAN - BUILDING 01
Scale 1:50

WALL TYPE KEY:

- 150mm thick concrete cast panel 180/180/180 fire walls
- 100mm thick internal GIB fyrline office 60/60/60 fire walls
- 140mm thick GIB fyrline office 60/60/60 fire walls
- 100mm thick internal GIB wall
- 140mm thick office wall
- 100mm thick 1100mm stair balustrade

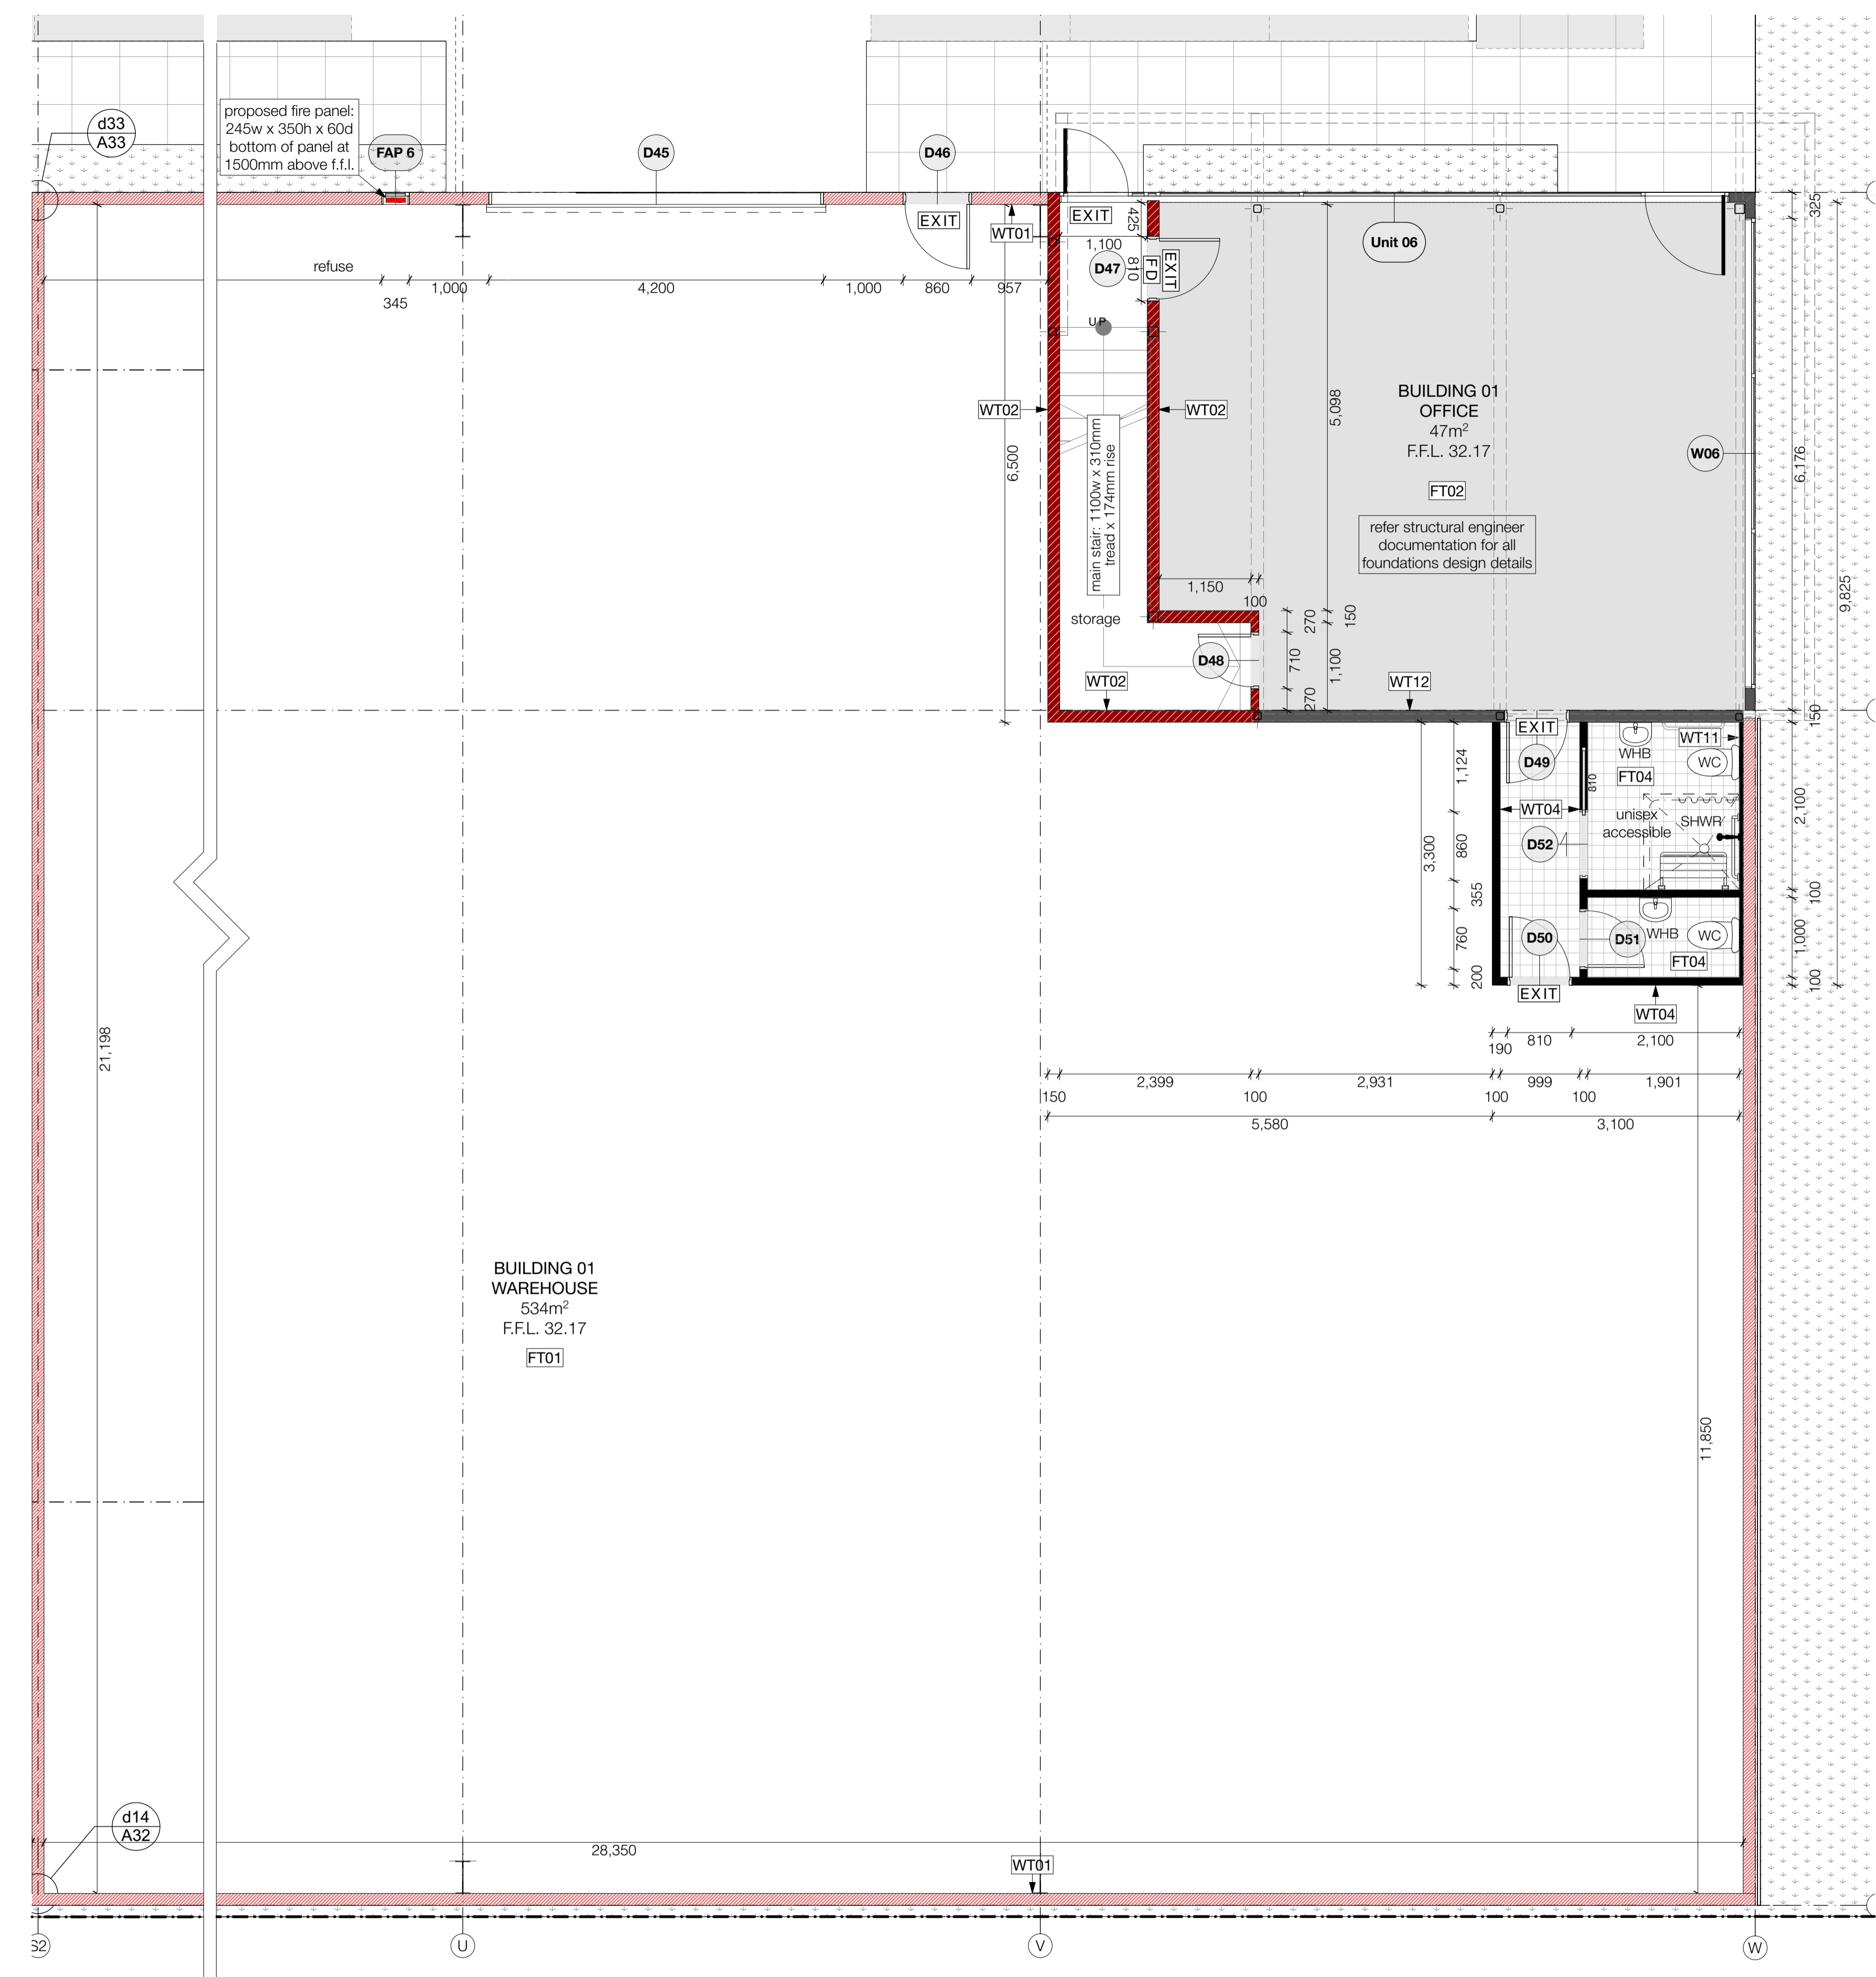

GROUND FLOOR PLAN - BUILDING 01
Scale 1:50

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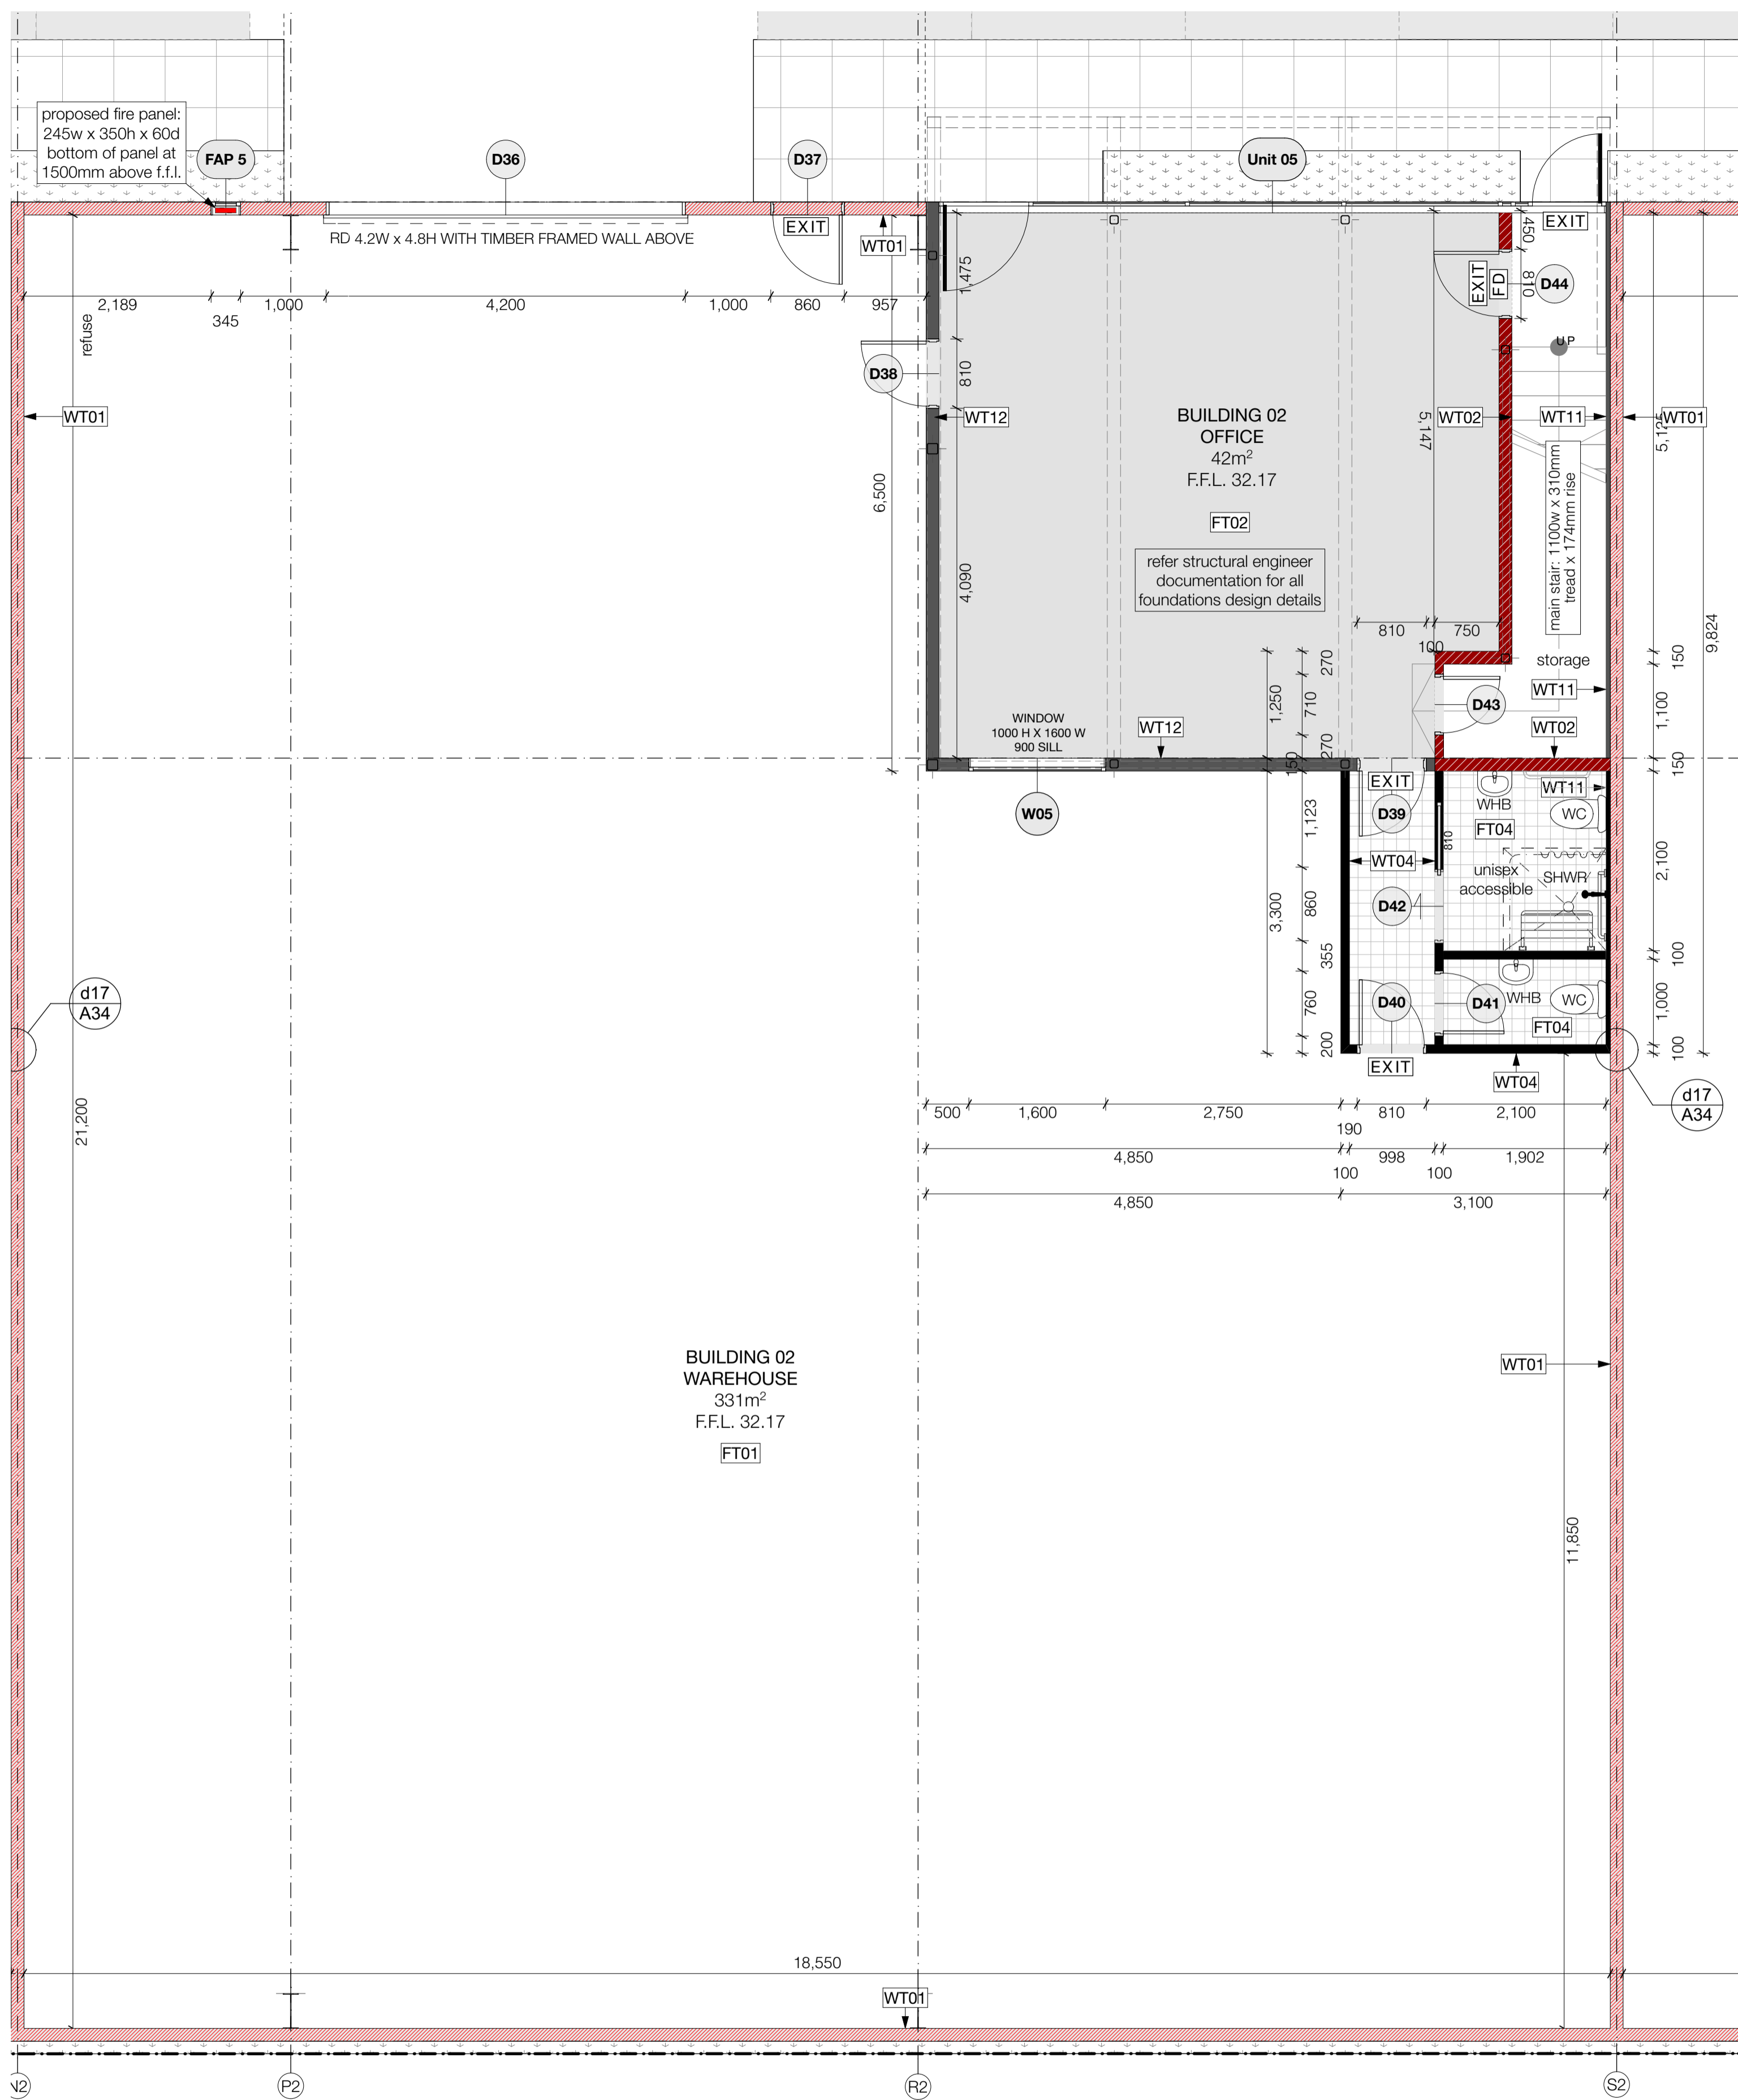
CLIENT: Fosters Construction
SITE: Te Rapa Industrial Park, Hamilton

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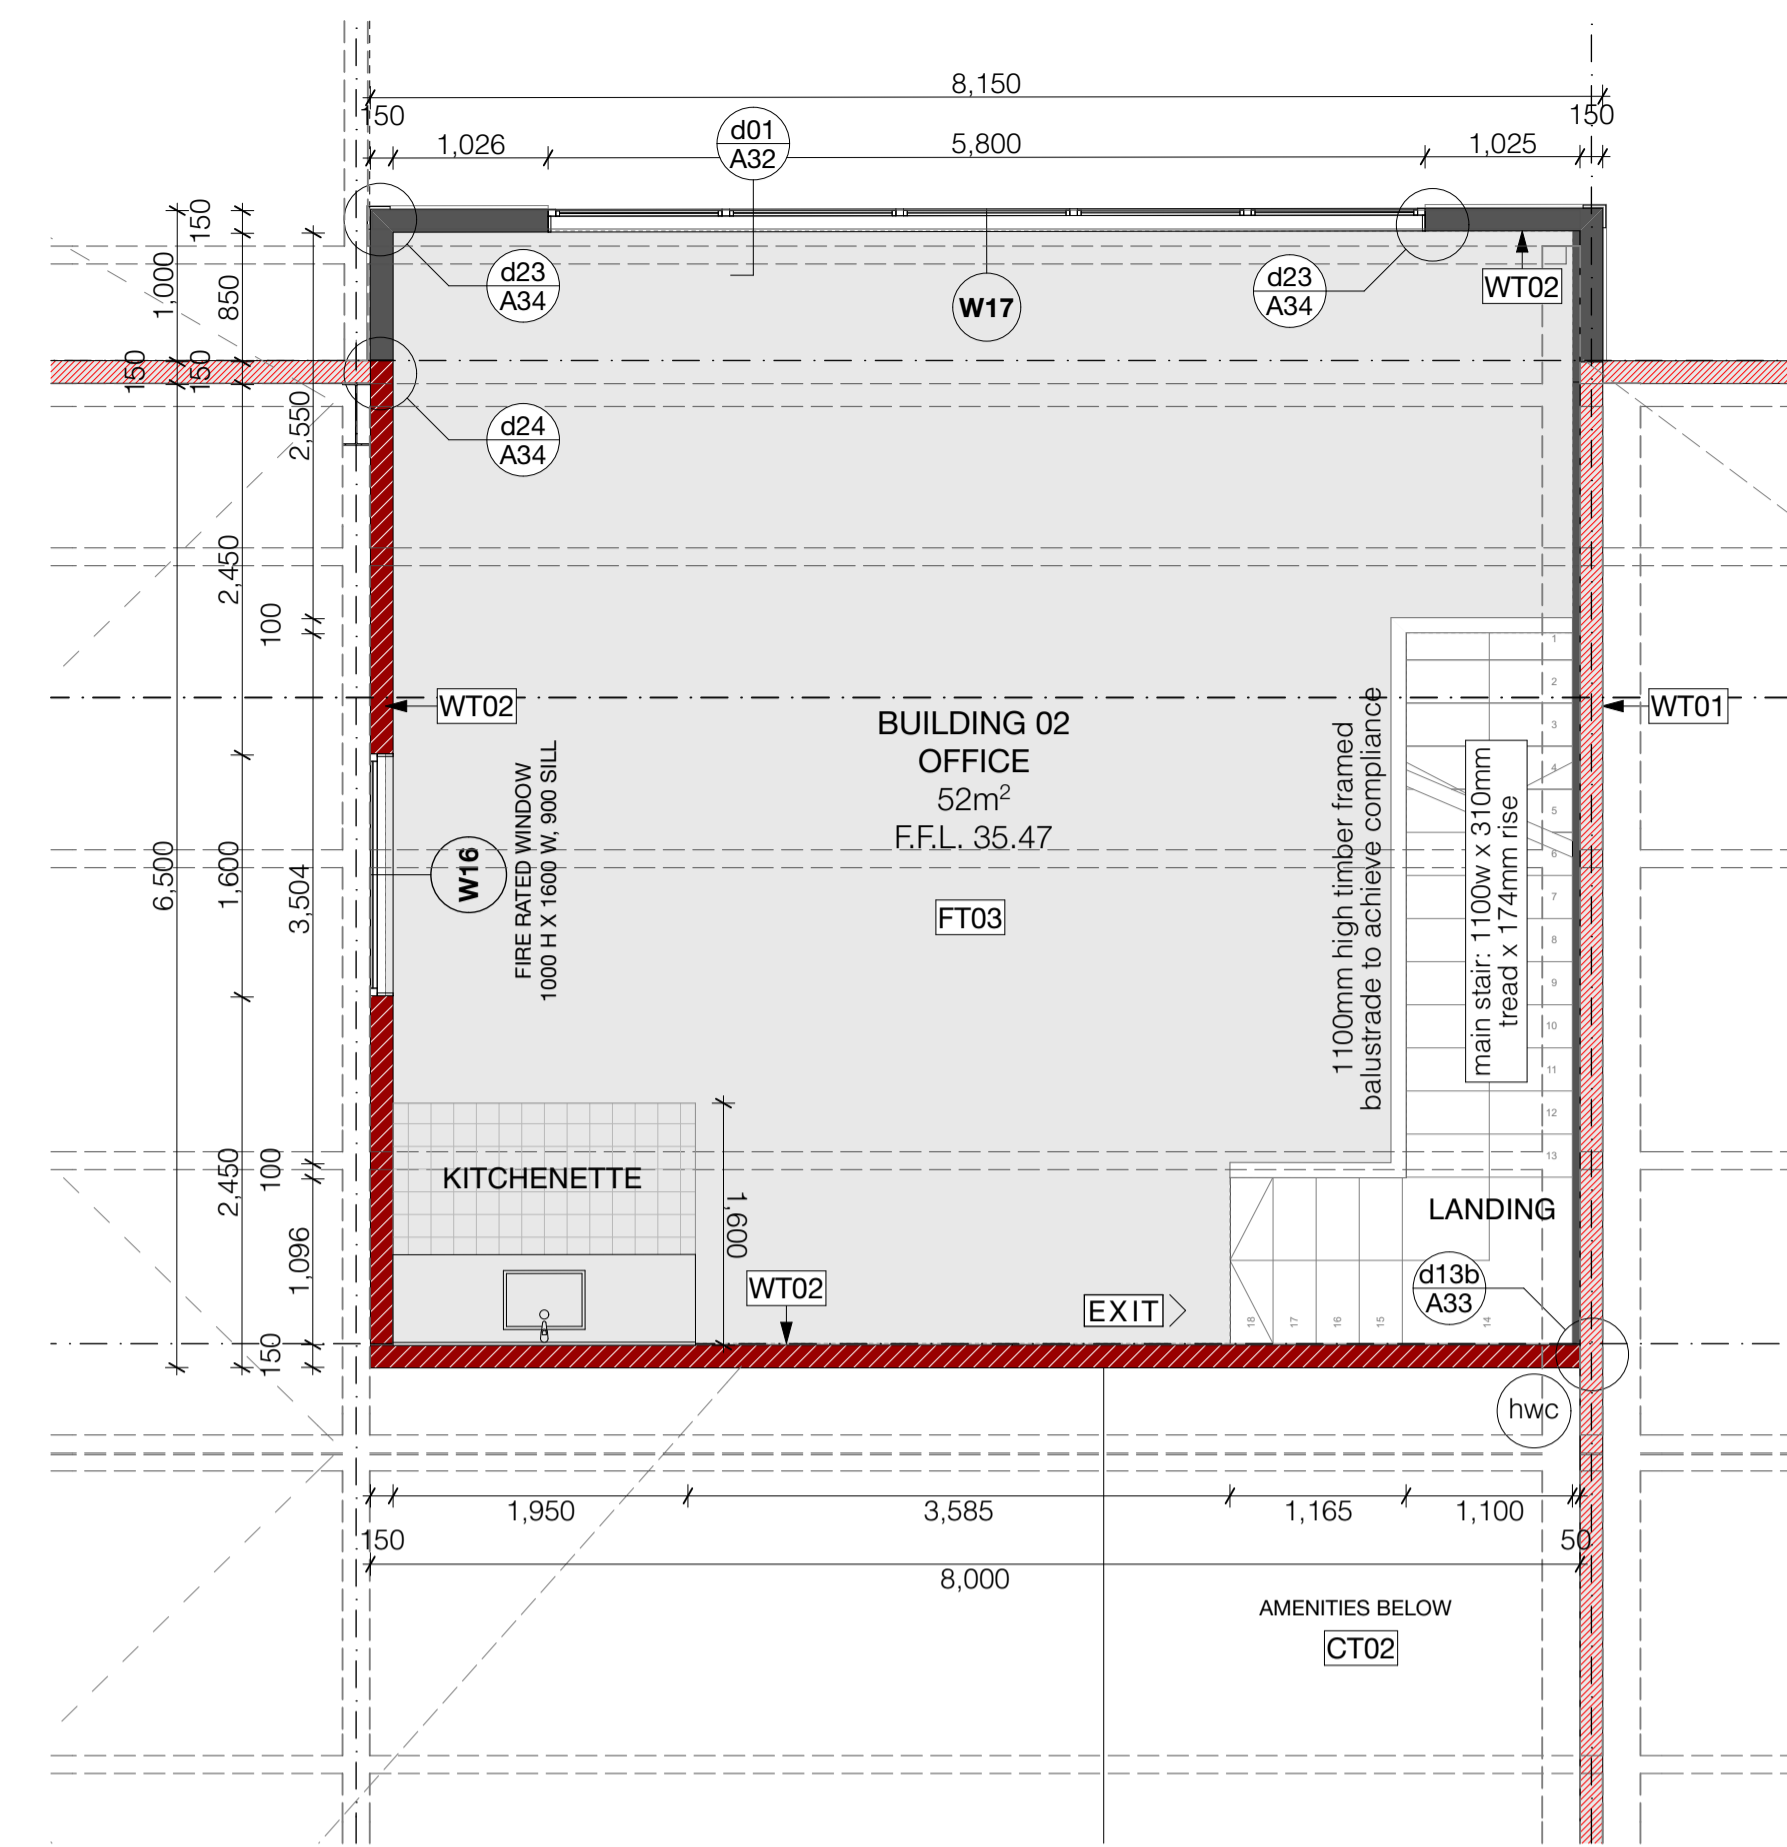
DRAWING TITLE:

PART PLANS - BUILDING 01

PROJECT REF:	T0424 TE RAPA S2	
DATE:	25/06/19	SCALE: 1:50 @ A1
SHEET:	A07	REV: C01



GROUND FLOOR PLAN - BUILDING 02
Scale 1:50



FIRST FLOOR PLAN - BUILDING 02
Scale 1:50

WALL TYPE KEY:

- 150mm thick concrete cast panel 180/180/180 fire walls
- 100mm thick internal GIB fyrline office 60/60/60 fire walls
- 140mm thick GIB fyrline office 60/60/60 fire walls
- 100mm thick internal GIB wall
- 140mm thick office wall
- 100mm thick 1100mm stair balustrade

- main notes:**
- roof:**
 - RT01 Roof: 0.55 BMT Dimond BB900 profiled COLORSTEEL roofing with ENDURA finish over selected THERMAKRAFT COVERTEK 405 roofing underlay over safety mesh on roof structure. Office roof cavity insulated with AUTEX greenstuf insulation to achieve min. R3.0
 - RT02 External gutter: 0.55 BMT box gutter with COLORSTEEL ENDURA finish fixed with hidden brackets to manufacturers specification.
 - RT03 Parapet / apron roof flashings: 0.55 BMT machine folded flashings with COLORSTEEL ENDURA finish.
 - RT04 Warehouse roof skylight: AMPELITE SL translucent sheet roofing to match profile of roof fixed over THERMAKRAFT AUSMESH safety mesh (galv. coated) on roof structure - to provide 15% daylighting to warehouse space.
 - RT05 Canopy Roof & Soffit: 0.55 BMT Dimond BB900 profiled COLORSTEEL roofing with ENDURA finish over roof structure and to underside of soffit to provide bird proofing.
 - ceiling:**
 - CT01 Internal office ceiling: USG DONN DX suspended ceiling grid system with selected 1200x600 mineral fibre ceiling tiles SLT edged.
 - CT02 Internal ceiling: 13mm GIB AQUALINE ceiling lining fixed to ex75x40mm SG8 timber battens @ 600 crs on 140x45mm joists @ 450 crs covered with 19mm marine ply. Max load 1.5kPa.
 - CT03 Underside of stairs: 16mm GIB FYRLINE lining to underside of timber stair structure in accordance with GIB spec - GBFC60. FR 60/60/60 fire rated lining to extend through to fire rated wall structure
 - walls:**
 - WT01 150mm FR 180/180/180 thick pre-cast concrete panel walls - refer structural and fire engineers documentation.
 - WT02 Office fire walls: FR 60/60/60 ex150x50 SG8 wall framing with studs at 300 centres lined with 13mm GIB FYRLINE lining to both sides in accordance with GIB specification - GBTL60. Walls to extend to underside of roof above.
 - WT03 external walls: ex150x50 SG8 wall framing with studs at 600 centres lined with 13mm standard GIB board inside in accordance with GIB specification - GBUW 15. Walls to extend to underside of roof above.
 - WT04 Internal walls: ex100x50 SG8 wall framing with studs at 600 centres lined with 10mm standard GIB board lining to interior. 10mm GIB AQUALINE to be used in wet areas. Where vinyl is continued up wall WPS water proofing membrane to be used in strict accordance with manufacturers specification. Face of office walls to warehouse finished with 9.5mm selected plywood to a height of 2.4m above finished floor level.
 - WT05 Office cladding: METALCRAFT KAHU cladding with COLORSTEEL ENDURA finish fixed vertically over 20mm cavity battens over COVERTEK 403 building wrap on ex150x50 SG8 wall framing with studs at 600 centres. Insulated cavity with AUTEX insulation min R2.5
 - WT06 Warehouse wall cladding: METALCRAFT KAHU cladding with COLORSTEEL ENDURA finish fixed horizontally over 20mm cavity battens over COVERTEK 403 building wrap on precast concrete panel walls.
 - WT07 Joinery: VANTAGE external window 125 FLUSHGLAZE suite in seismic frames with powder coated finish and Magnum door.
 - WT08 Joinery: VANTAGE 40 external window METRO suite with powder coated finish.
 - WT09 Roller door: METALBILT motorised roller shutter door powder coated finish on windsocks all with metal chain and manual back-up.
 - WT10 Horizontal sun screens: INSOL zenith AI sun screen with selected powdercoat finish. Refer manufacturers specifications for all fixings and structural information.
 - WT11 Internal strapped walls: ex50x50 SG8 timber strapping at 600 centres with 10mm standard GIB board lining to interior. 10mm GIB AQUALINE to be used in wet areas. AUTEX batt insulation to provide min. R2.5
 - WT12 Internal walls: ex150x50 SG8 wall framing with studs at 600 centres lined with 10mm standard GIB board lining to interior. 10mm GIB AQUALINE to be used in wet areas. Where vinyl is continued up wall WPS water proofing membrane to be used in strict accordance with manufacturers specification. Face of office walls to warehouse finished with 9.5mm selected plywood to a height of 2.4m above finished floor level.
 - floors:**
 - FT01 Warehouse floor: 150mm thick reinforced concrete slab foundation on DPM and sand blinding on minimum 150mm thick compacted hard fill - refer structural engineers documentation for all structural information.
 - FT02 Office ground floor: 150mm thick reinforced concrete slab foundation on DPM and sand blinding on minimum 150mm thick compacted hard fill - refer structural engineer.
 - FT03 Office first floor: FRR 60/60/60 150mm thick Comfor - refer structural engineer.
 - FT04 Selected commercial grade vinyl flooring
 - structural:**
 - ST01 Structural framing - refer structural engineer documentation for all structural detail.
 - note:**

All materials, fittings, fixtures, and finishes to be established in strict accordance with manufactures specification.

This architectural documentation is to be read in conjunction with all specialist documentation and reports. Refer to engineering documentation for all engineering requirements.

fire design requirements:


All precast concrete panel walls to provide FR 180/180/180 (150 thick). Ground floor office to be fire rated and separate to the first floor fire cell - all fire rated FR 60/60/60. All supporting structure, stairs and underside of floors to be fire rated FR 60/60/60.
 - FD** FD = fire door. Refer fire report for all fire design requirements.
 - W03** Window joinery - Refer D & W schedule
 - Refer finishes plans for floor, wall & ceiling finishes

NOTE:
It is the responsibility of the contractor to verify all dimensions on site prior to commencing all work. The contractor is to ensure that all work complies with the New Zealand Building Code, all amendments thereof and all relevant New Zealand Standards. All proprietary items and materials shall be fixed and applied in strict accordance with manufacturers specifications. TAYLORED architecture & environments Ltd under no circumstances accepts responsibility for payment of any products or services specified.



ISSUE: C01
DATE: 25/06/19

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PROJECT: Te Rapa Stage 2
CLIENT: Fosters Construction
SITE: Te Rapa Industrial Park, Hamilton

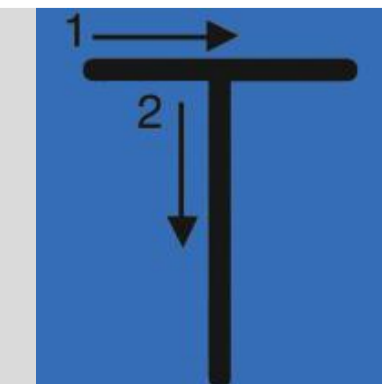FOR CONSTRUCTION ISSUE

DRAWING TITLE: PART PLANS - BUILDING 02

PROJECT REF: T0424 TE RAPA S2	
DATE: 25/06/19	SCALE: 1:50 @ A1
SHEET: A08	REV: C01

main notes:

- RT01** Roof: 0.55 BMT Dimond BB900 profiled COLORSTEEL roofing with ENDURA finish over selected THERMAKRAFT COVERTEK 405 roofing underlay over safety mesh on roof structure. Office roof cavity insulated with AUTEX greenstuf insulation to achieve min. R3.0
- RT02** External gutter: 0.55 BMT box gutter with COLORSTEEL ENDURA finish fixed with hidden brackets to manufacturers specification.
- RT03** Parapet / apron roof flashings: 0.55 BMT machine folded flashings with COLORSTEEL ENDURA finish.
- RT04** Warehouse roof skylight: AMPELITE SL translucent sheet roofing to match profile of roof fixed over THERMAKRAFT AUSMESH safety mesh (galv. coated) on roof structure - to provide 15% daylighting to warehouse space.
- RT05** Canopy Roof & Soffit: 0.55 BMT Dimond BB900 profiled COLORSTEEL roofing with ENDURA finish over roof structure and to underside of soffit to provide bird proofing.

ceiling:

- CT01** Internal office ceiling: USG DONN DX suspended ceiling grid system with selected 1200x600 mineral fibre ceiling tiles SL1 edged.
- CT02** Internal ceiling: 13mm GIB AQUALINE ceiling lining fixed to ex75x40mm SG8 timber battens @ 600 crs on 140x45mm joists @ 450 crs covered with 19mm marine ply. Max load 1.5kPa.
- CT03** Underside of stairs: 16mm GIB FYRLINE lining to underside of timber stair structure in accordance with GIB spec - GBFC60. FR 60/60/60 fire rated lining to extend through to fire rated wall structure

walls:

- WT01** 150mm FR 180/180/180 thick pre-cast concrete panel walls - refer structural and fire engineers documentation.
- WT02** Office fire walls: FR 60/60/60 ex150x50 SG8 wall framing with studs at 600 centres lined with 13mm GIB FYRLINE lining to both sides in accordance with GIB specification GBTL60. Walls to extend to underside of roof above.
- WT03** external walls: ex150x50 SG8 wall framing with studs at 600 centres lined with 13mm standard GIB board inside in accordance with GIB specification - GBUW 15. Walls to extend to underside of roof above.
- WT04** Internal walls: ex100x50 SG8 wall framing with studs at 600 centres lined with 10mm standard GIB board lining to interior. 10mm GIB AQUALINE to be used in wet areas. Where vinyl is continued up wall WPS water proofing membrane to be used in strict accordance with manufacturers specification. Face of office walls to warehouse finished with 9.5mm selected plywood to a height of 2.4m above finished floor level.
- WT05** Office cladding: METALCRAFT KAHU cladding with COLORSTEEL ENDURA finish fixed vertically over 20mm cavity battens over COVERTEK 403 building wrap on ex150x50 SG8 wall framing with studs at 600 centres. Insulated cavity with AUTEX insulation min R2.5
- WT06** Warehouse wall cladding: METALCRAFT KAHU cladding with COLORSTEEL ENDURA finish fixed horizontally over 20mm cavity battens over COVERTEK 403 building wrap on precast concrete panel walls.
- WT07** Joinery: VANTAGE external window 125 FLUSHGLAZE suite in seismic frames with powder coated finish and Magnum door.
- WT08** Joinery: VANTAGE 40 external window METRO suite with powder coated finish.
- WT09** Roller door: METALBILT motorised roller shutter door powder coated finish on windsocks all with metal chain and manual back-up.
- WT10** Horizontal sun screens: INSOL zenith AI sun screen with selected powdercoat finish. Refer manufacturers specifications for all fixings and structural information.
- WT11** Internal strapped walls: ex50x50 SG8 timber strapping at 600 centres with 10mm standard GIB board lining to interior. 10mm GIB AQUALINE to be used in wet areas. AUTEX batt insulation to provide min. R2.5
- WT12** Internal walls: ex150x50 SG8 wall framing with studs at 600 centres lined with 10mm standard GIB board lining to interior. 10mm GIB AQUALINE to be used in wet areas. Where vinyl is continued up wall WPS water proofing membrane to be used in strict accordance with manufacturers specification. Face of office walls to warehouse finished with 9.5mm selected plywood to a height of 2.4m above finished floor level.

floors:

- FT01** Warehouse floor: 150mm thick reinforced concrete slab foundation on DPM and sand blinding on minimum 150mm thick compacted hard fill - refer structural engineers documentation for all structural information.
- FT02** Office ground floor: 150mm thick reinforced concrete slab foundation on DPM and sand blinding on minimum 150mm thick compacted hard fill - refer structural engineer.
- FT03** Office first floor: FRR 60/60/60 150mm thick Comfor - refer structural engineer.
- FT04** Selected commercial grade vinyl flooring

structural:

- ST01** Structural framing - refer structural engineer documentation for all structural detail.

note:

All materials, fittings, fixtures, and finishes to be established in strict accordance with manufactures specification.

This architectural documentation is to be read in conjunction with all specialist documentation and reports. Refer to engineering documentation for all engineering requirements.



fire design requirements:

All precast concrete panel walls to provide FR 180/180/180 (150 thick). Ground floor office to be fire rated and separate to the first floor fire cell - all fire rated FR 60/60/60. All supporting structure, stairs and underside of floors to be fire rated FR 60/60/60.

FD FD = fire door. Refer fire report for all fire design requirements.

W03 Window joinery - Refer D & W schedule

Refer finishes plans for floor, wall & ceiling finishes

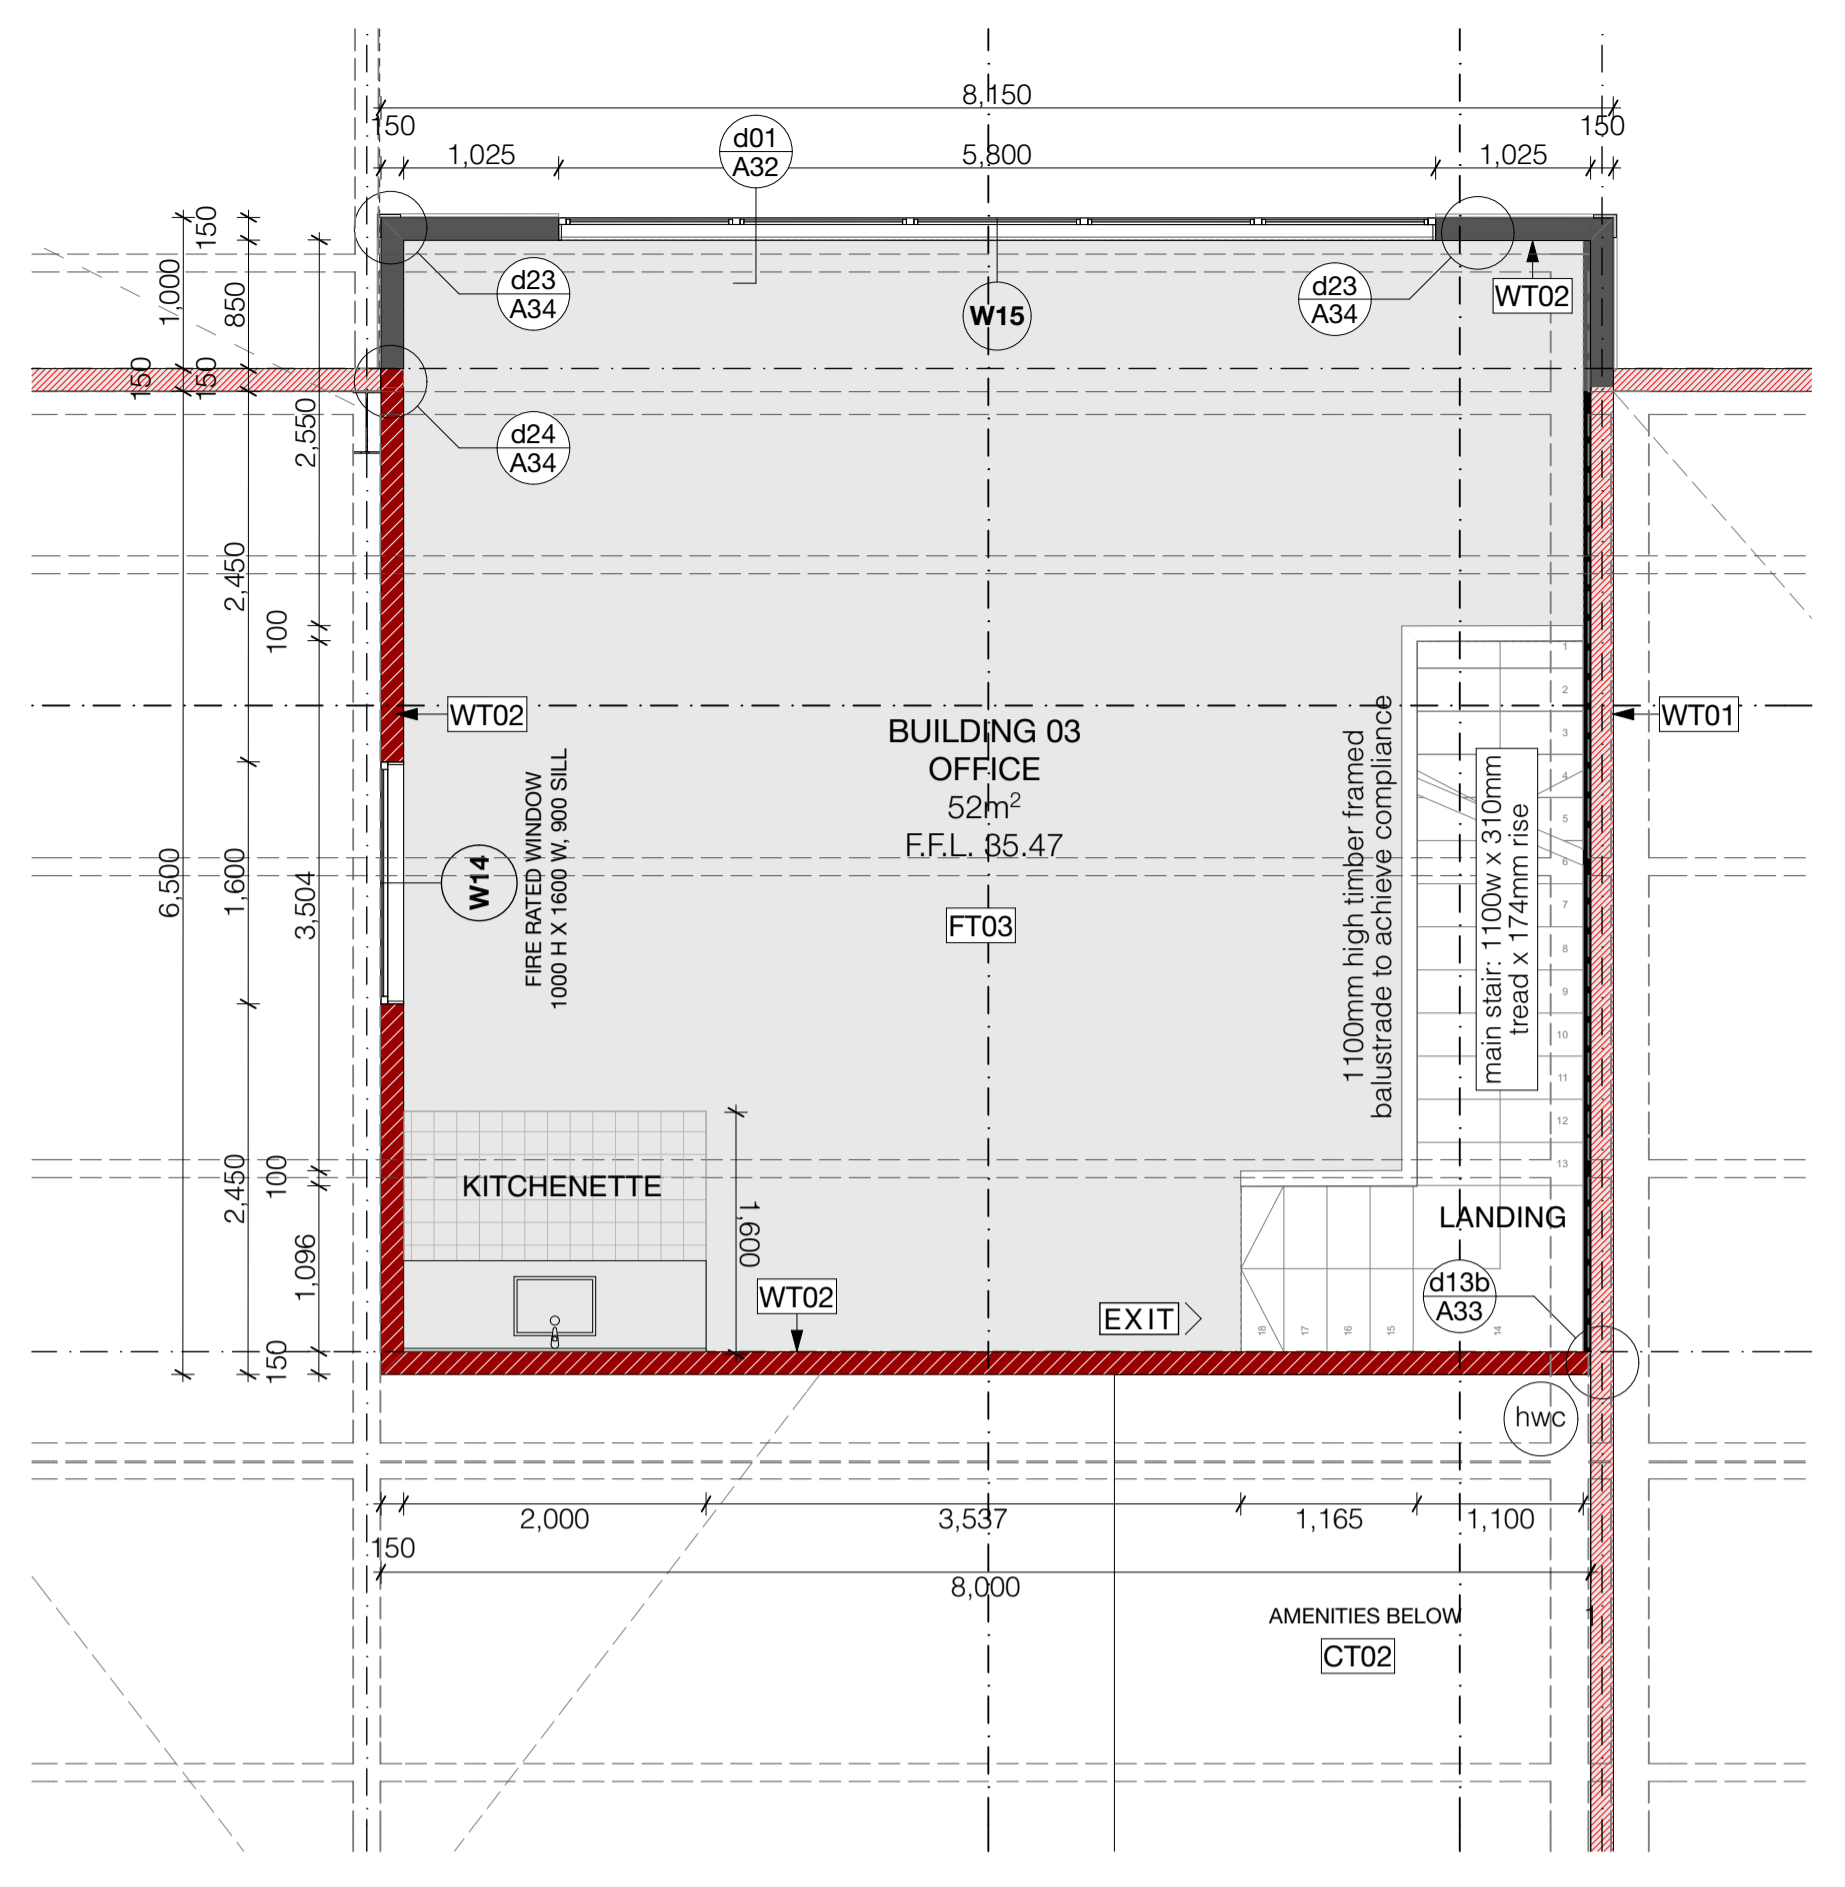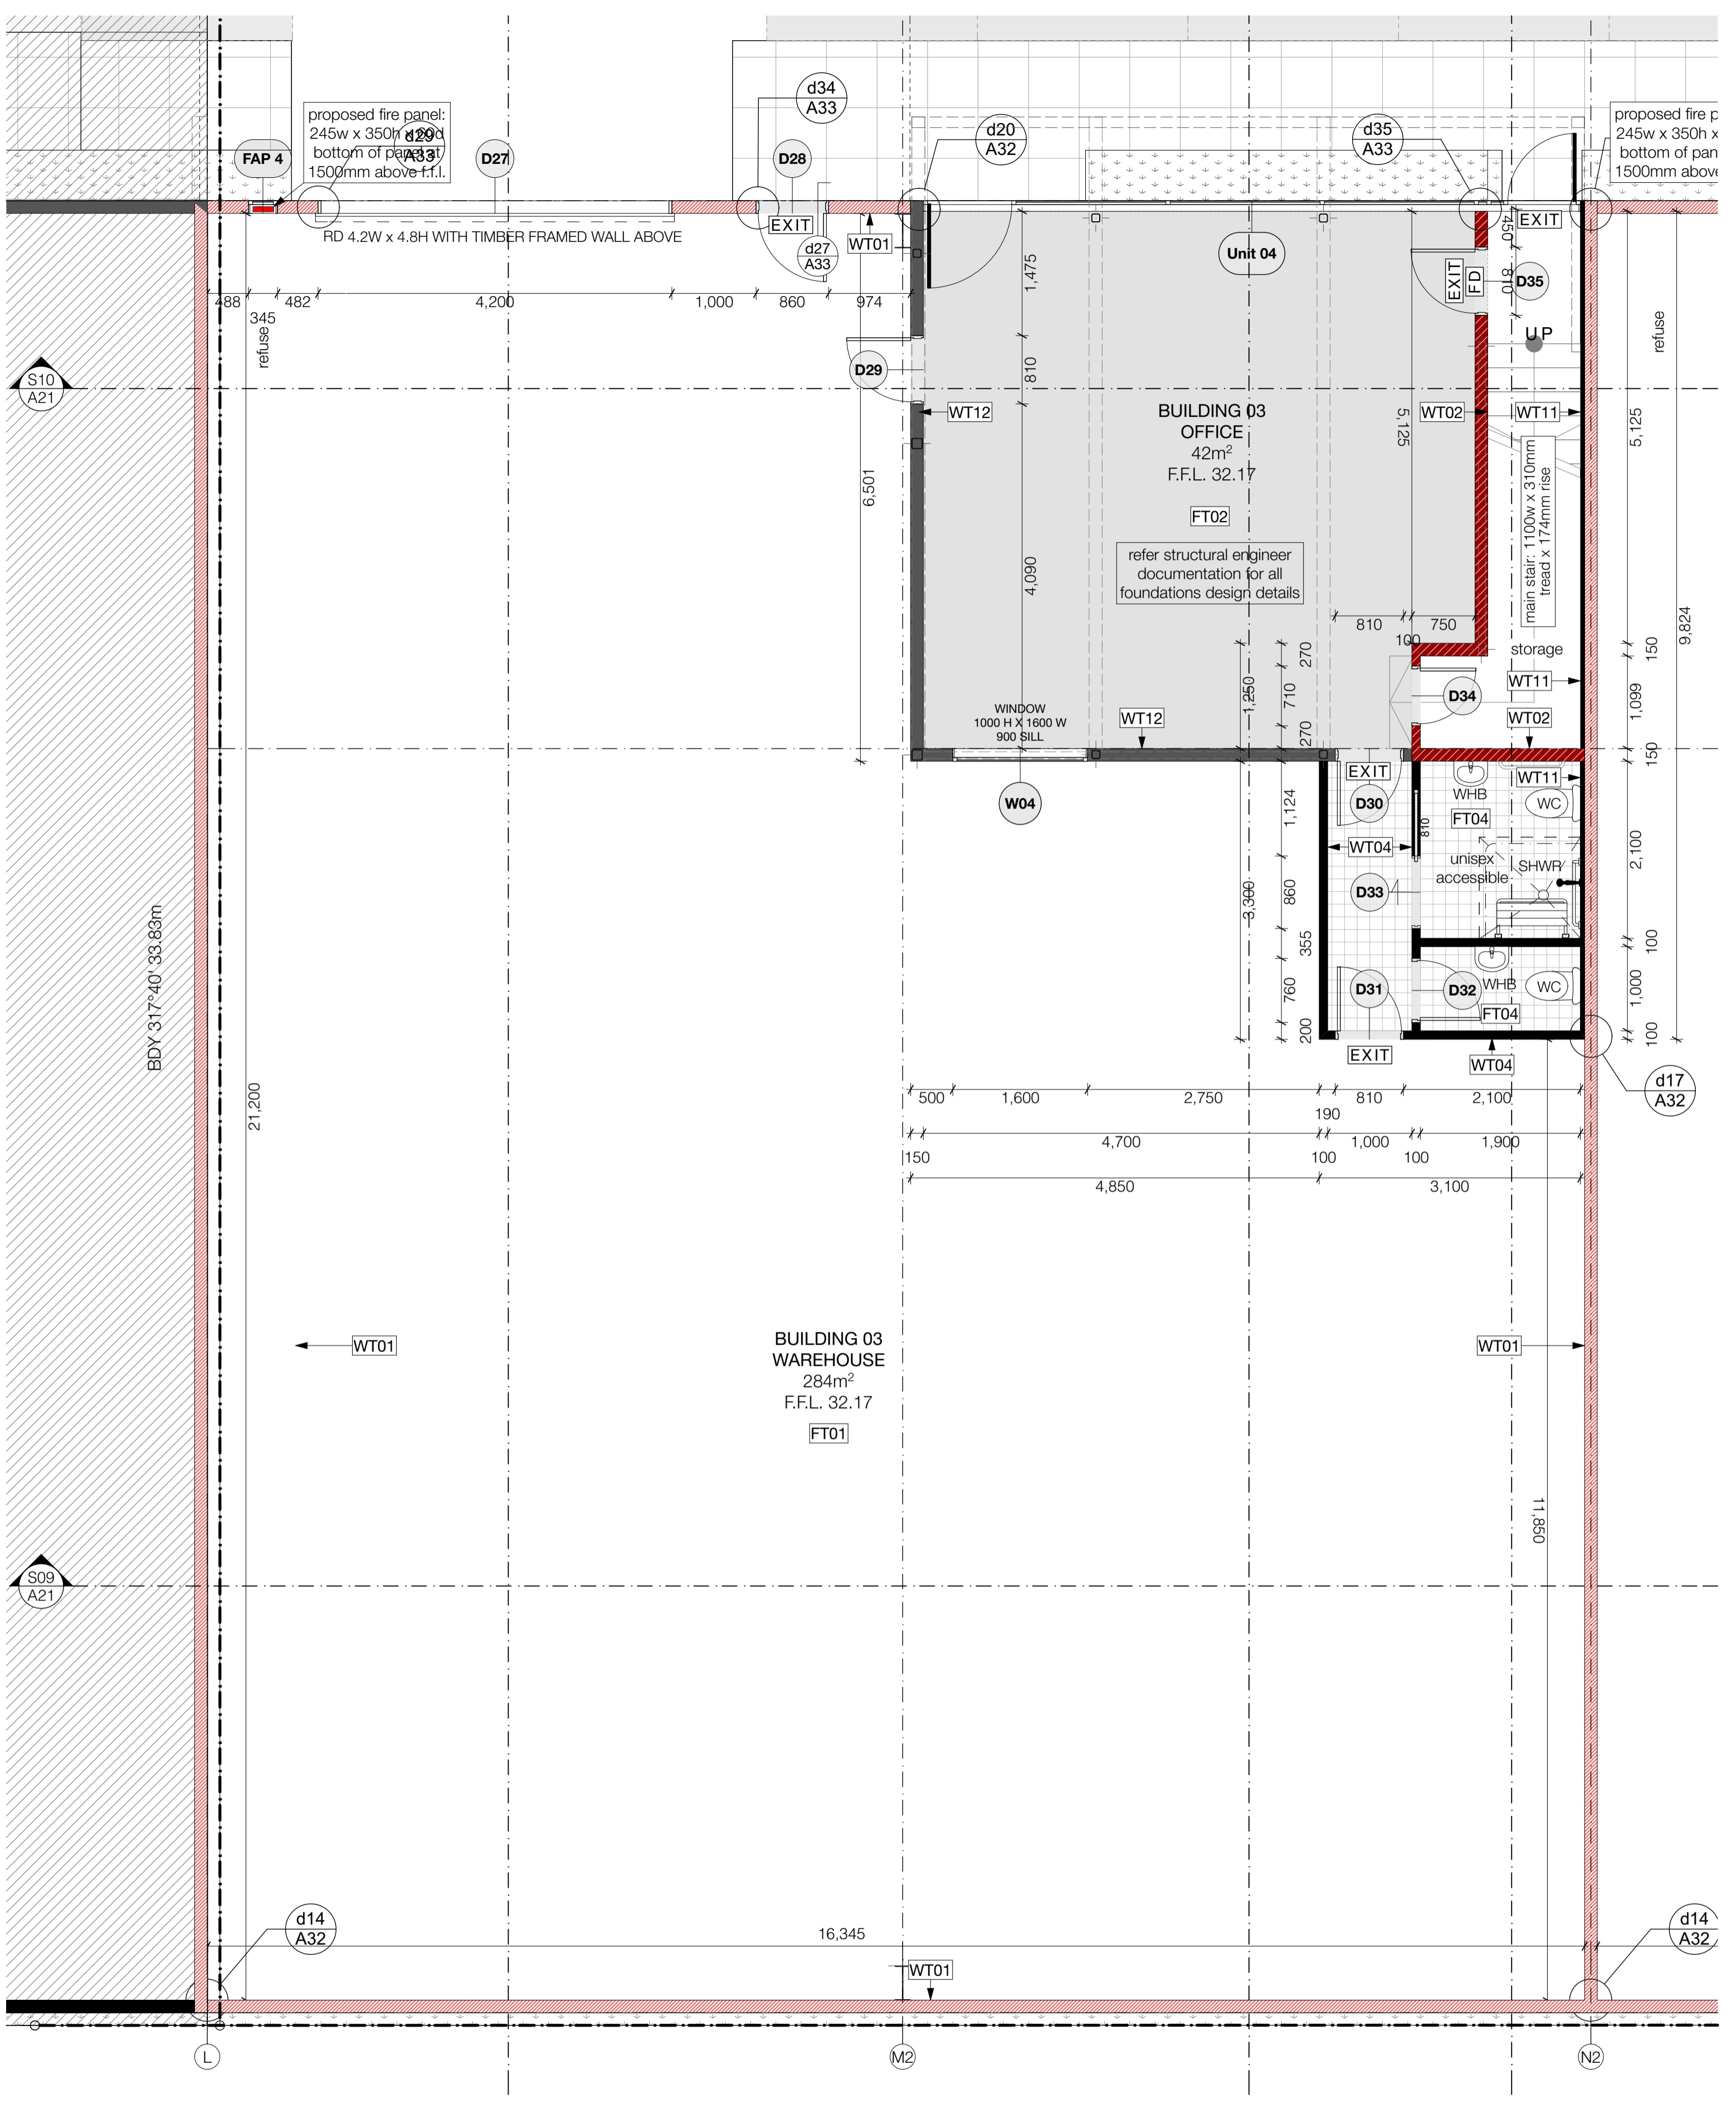

FIRST FLOOR PLAN - BUILDING 03
Scale 1:50

WALL TYPE KEY:

	150mm thick concrete cast panel 180/180/180 fire walls
	100mm thick internal GIB fyrline office 60/60/60 fire walls
	140mm thick GIB fyrline office 60/60/60 fire walls
	100mm thick internal GIB wall
	140mm thick office wall
	100mm thick 1100mm stair balustrade

GROUND FLOOR PLAN - BUILDING 03
Scale 1:50

NOTE:
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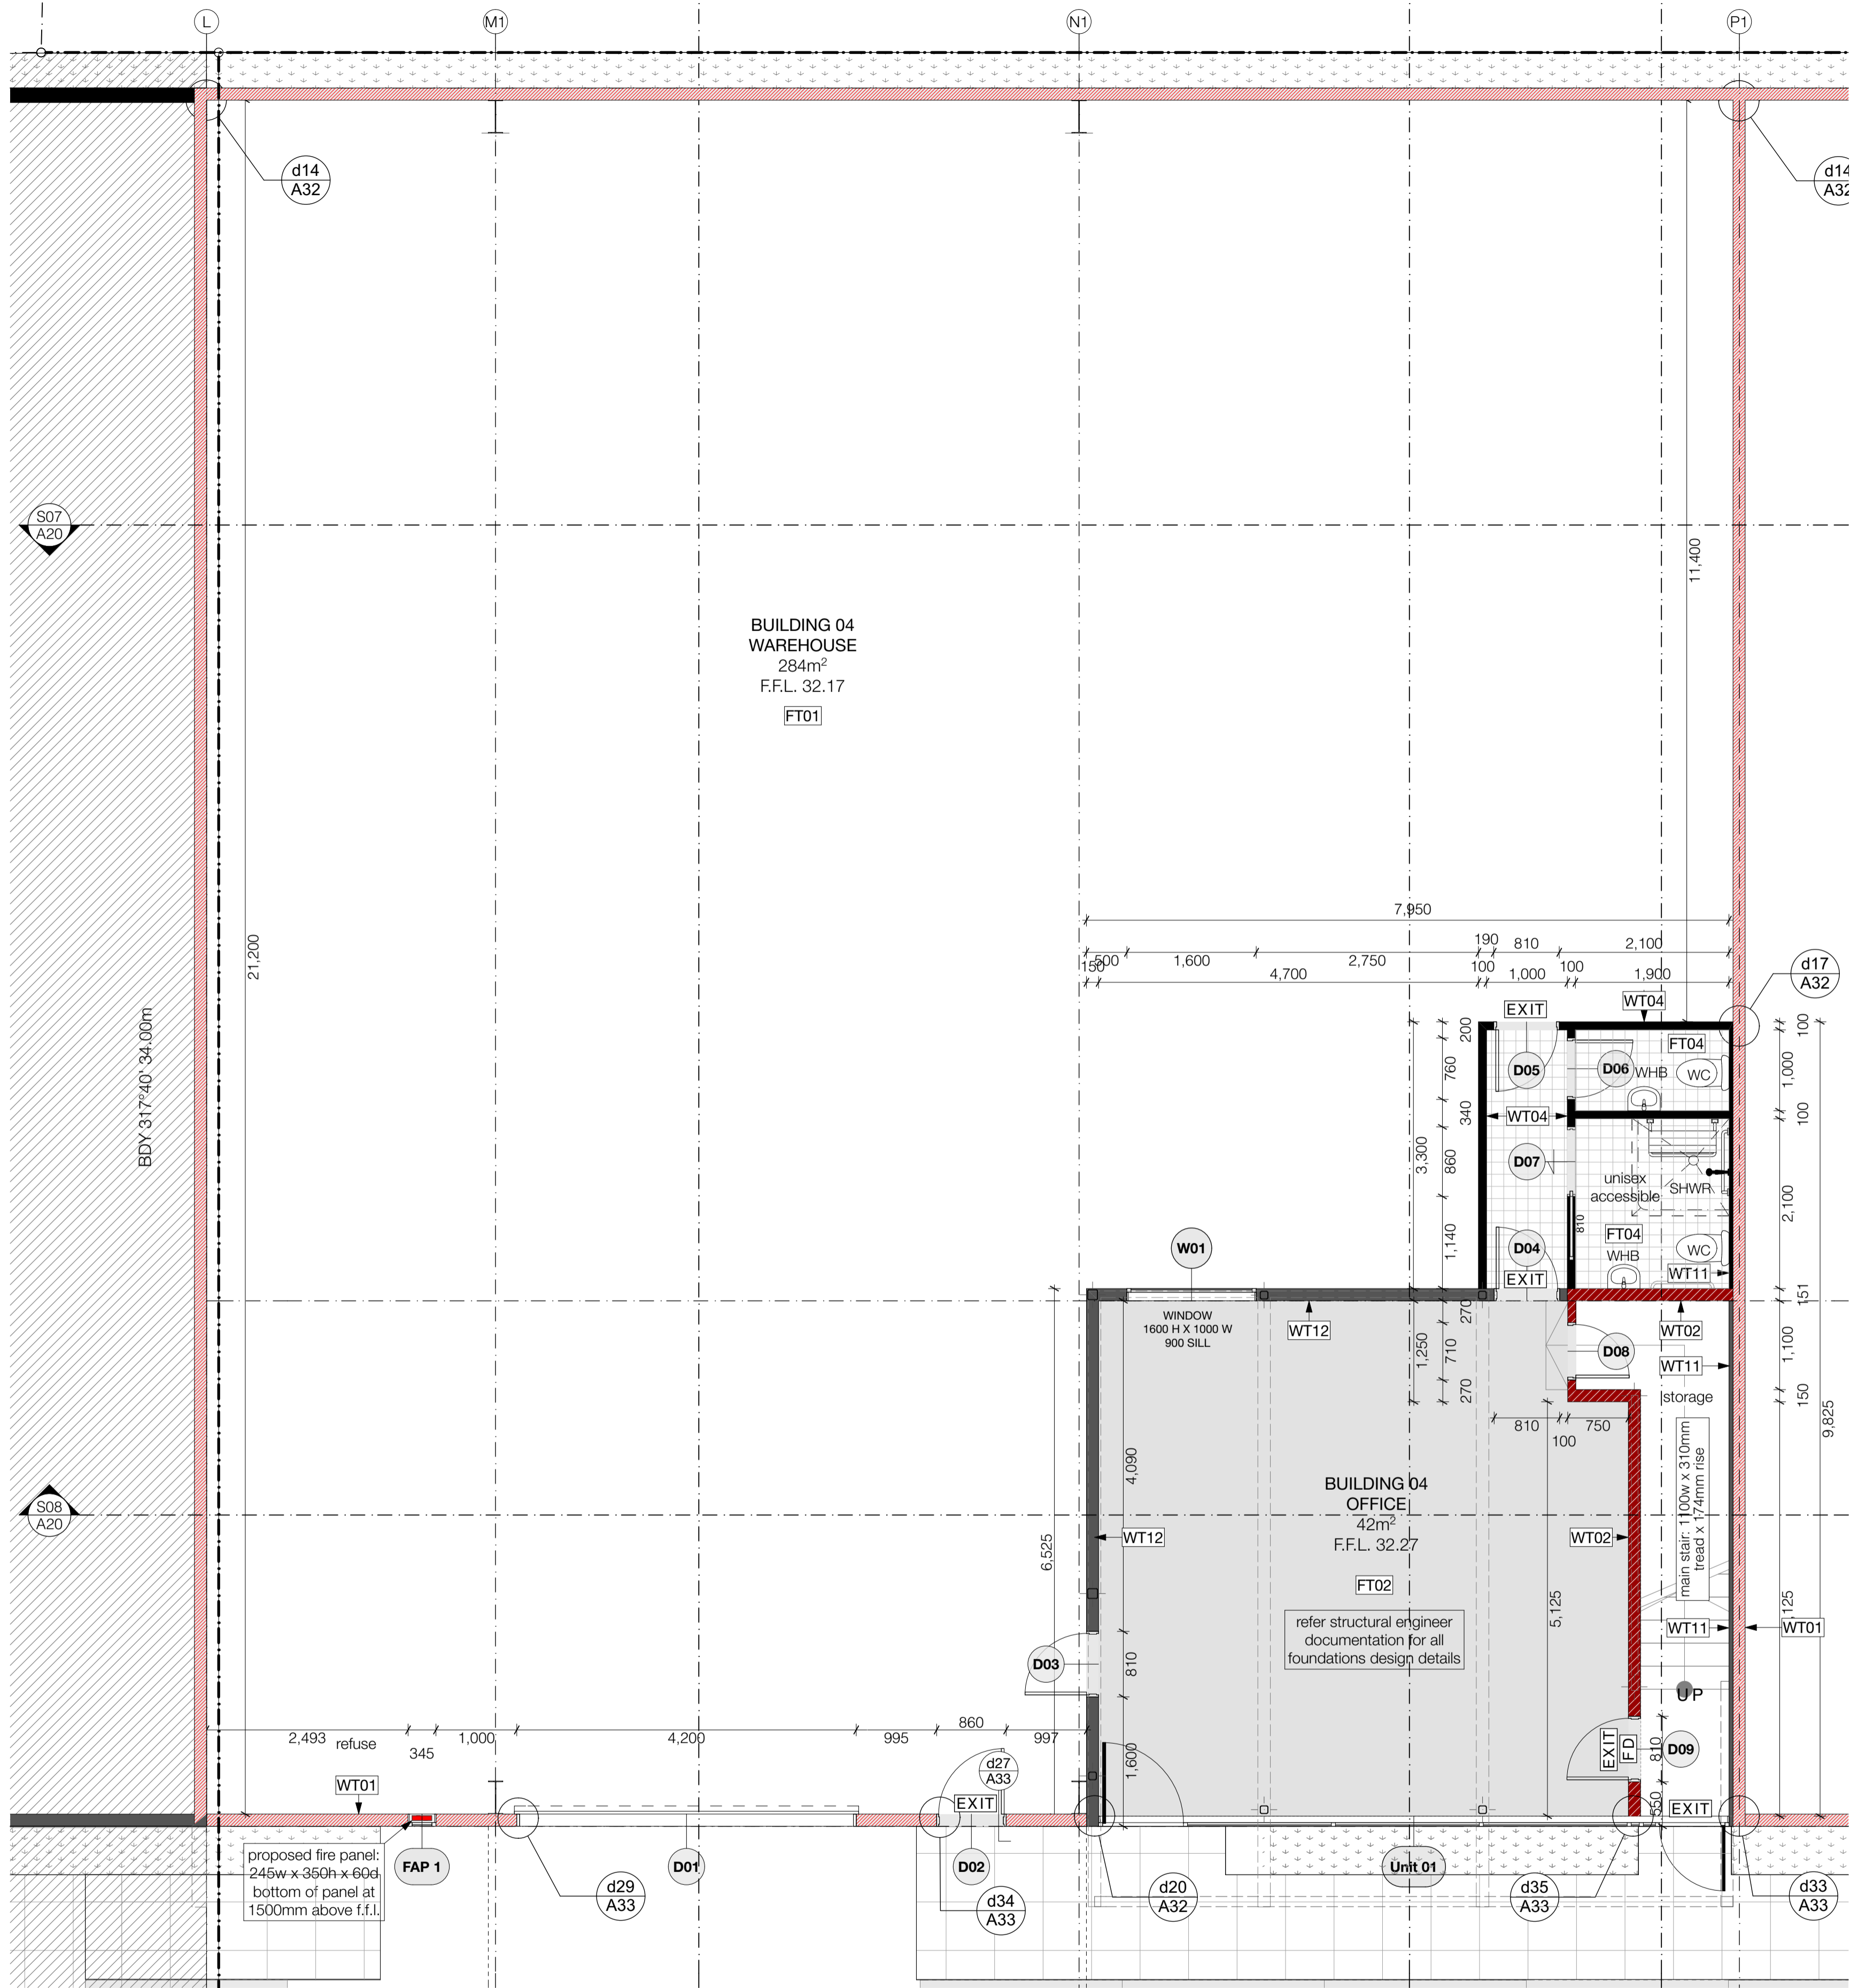
PROJECT:
Te Rapa Stage 2

CLIENT: Fosters Construction
SITE: Te Rapa Industrial Park, Hamilton


FOR CONSTRUCTION ISSUE

DRAWING TITLE:
PART PLANS - BUILDING 03

PROJECT REF: T0424 TE RAPA S2	
DATE: 25/06/19	SCALE: 1:50 @ A1
SHEET: A09	REV: C01



GROUND FLOOR PLAN - BUILDING 04
Scale 1:50

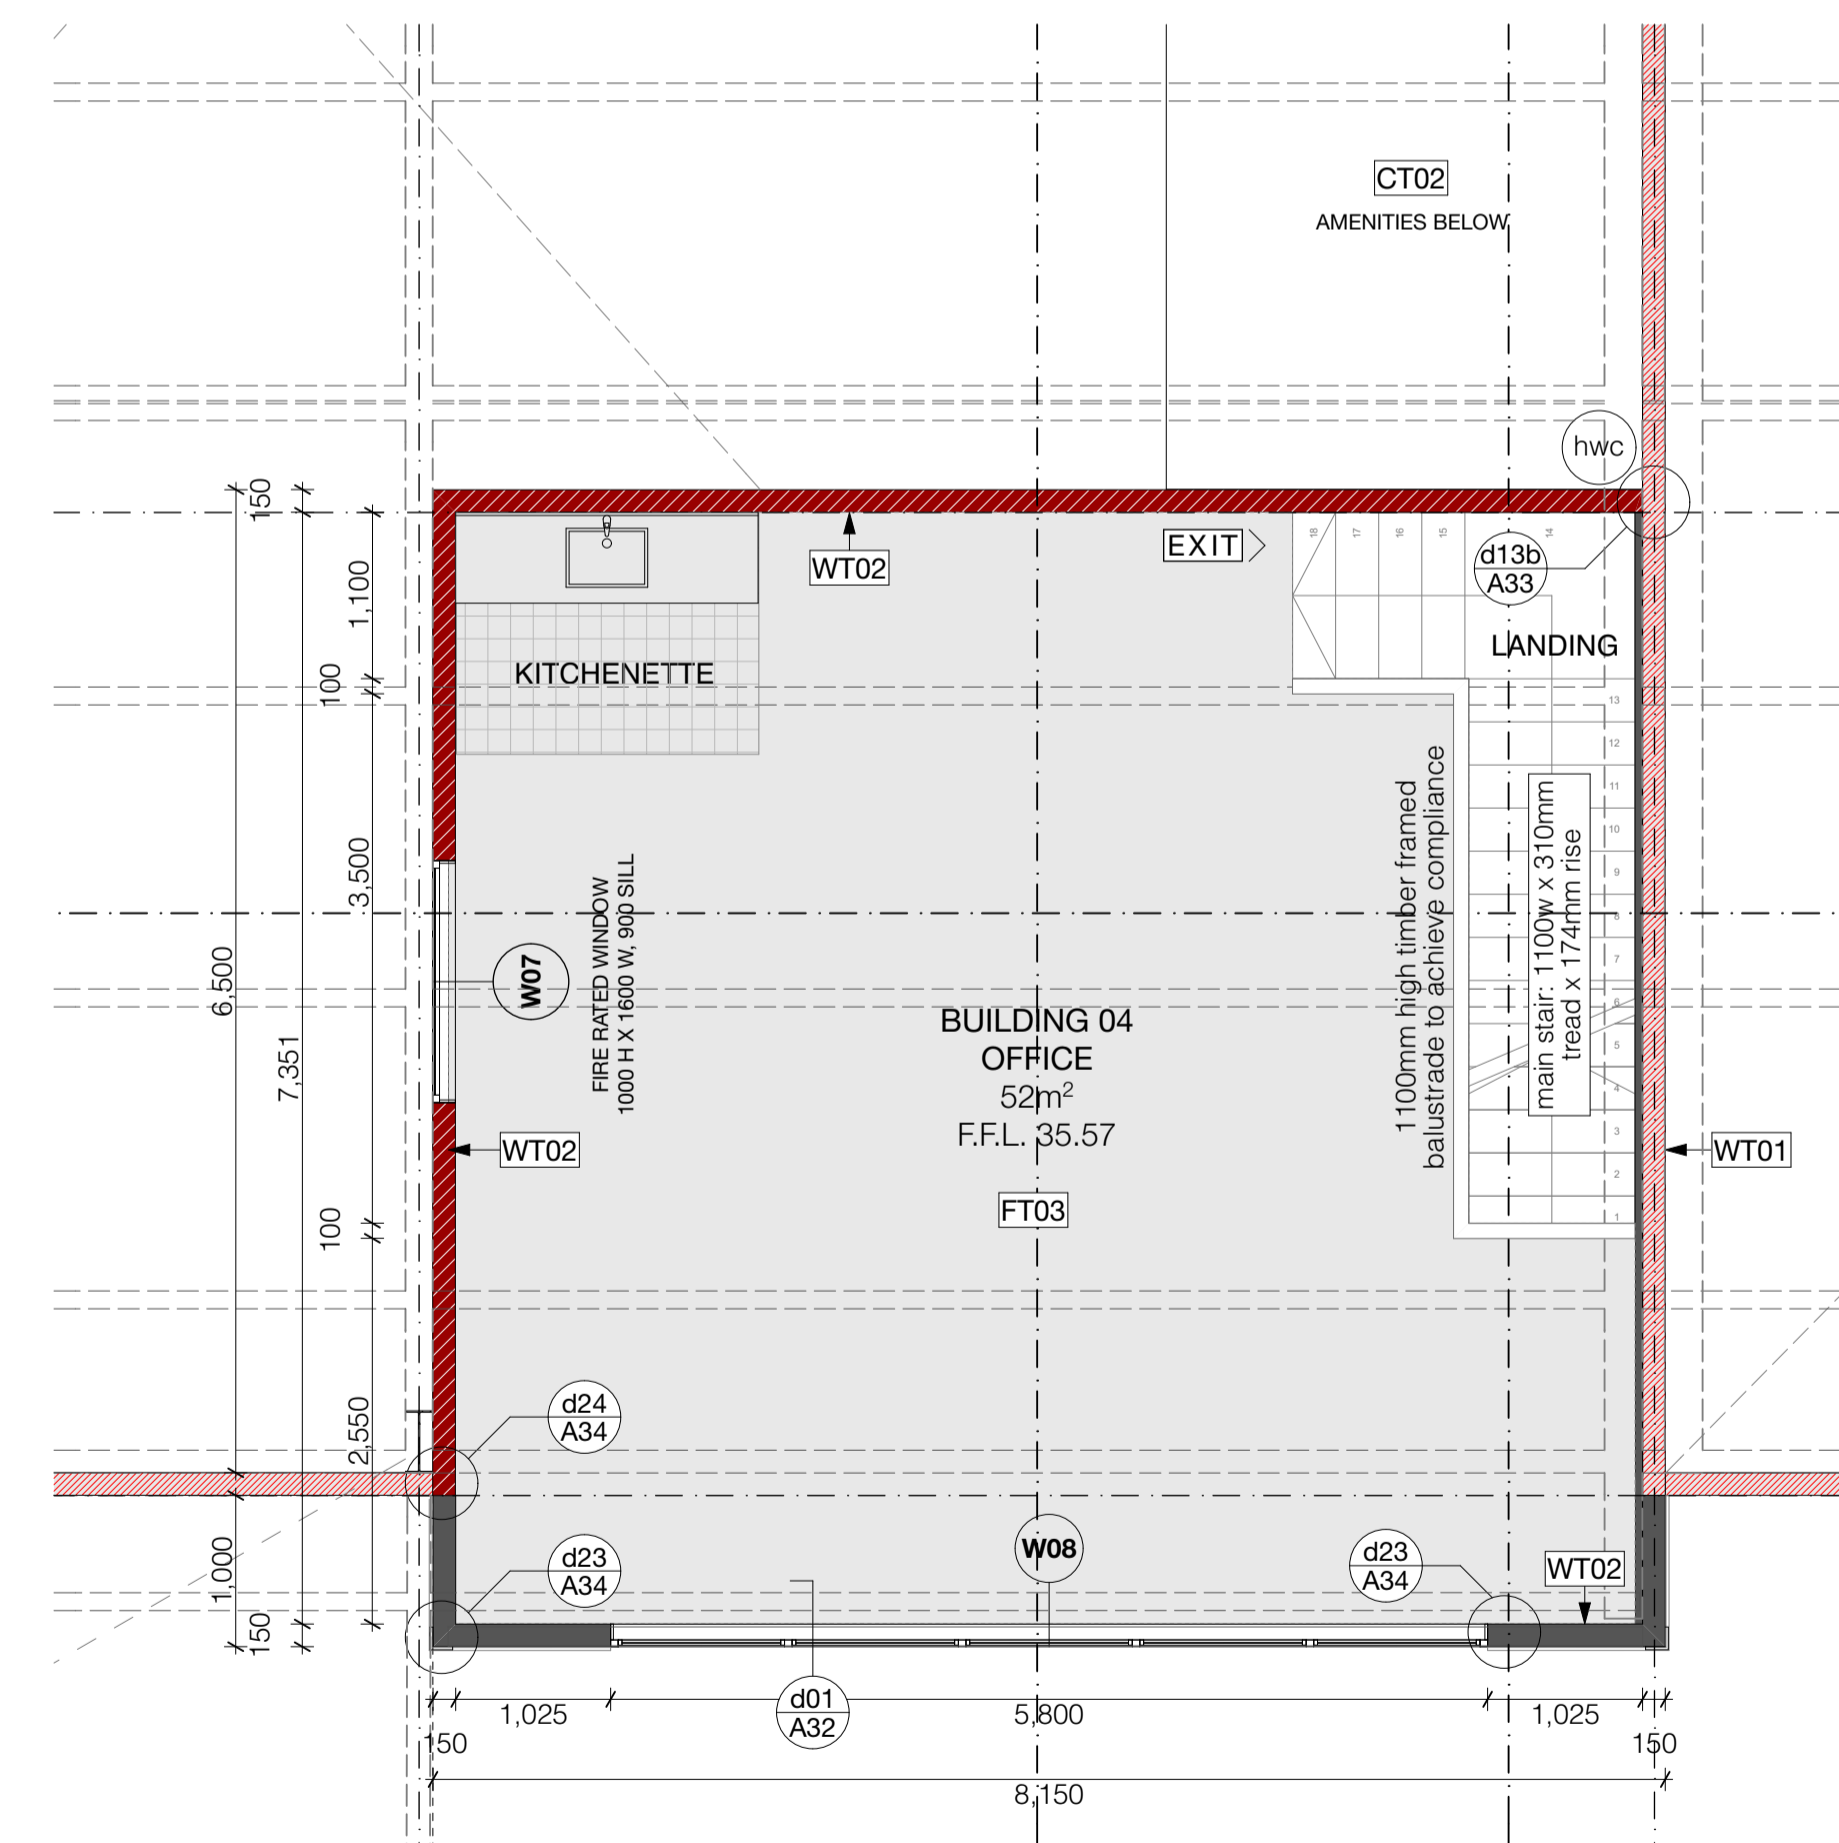

FIRST FLOOR PLAN - BUILDING 04
Scale 1:50

WALL TYPE KEY:

- 150mm thick concrete cast panel 180/180/180 fire walls
- 100mm thick internal GIB fyrline office 60/60/60 fire walls
- 140mm thick GIB fyrline office 60/60/60 fire walls
- 100mm thick internal GIB wall
- 140mm thick office wall
- 100mm thick 1100mm stair balustrade

main notes:

- roof:**
- RT01 Roof: 0.55 BMT Dimond BB900 profiled COLORSTEEL roofing with ENDURA finish over selected THERMAKRAFT COVERTEK 405 roofing underlay over safety mesh on roof structure. Office roof cavity insulated with AUTEX greenstuf insulation to achieve min. R3.0
 - RT02 External gutter: 0.55 BMT box gutter with COLORSTEEL ENDURA finish fixed with hidden brackets to manufacturers specification.
 - RT03 Parapet / apron roof flashings: 0.55 BMT machine folded flashings with COLORSTEEL ENDURA finish.
 - RT04 Warehouse roof skylight: AMPELITE SL translucent sheet roofing to match profile of roof fixed over THERMAKRAFT AUSMESH safety mesh (galv. coated) on roof structure - to provide 15% daylighting to warehouse space.
 - RT05 Canopy Roof & Soffit: 0.55 BMT Dimond BB900 profiled COLORSTEEL roofing with ENDURA finish over roof structure and to underside of soffit to provide bird proofing.

- ceiling:**
- CT01 Internal office ceiling: USG DONN DX suspended ceiling grid system with selected 1200x600 mineral fibre ceiling tiles SLT edged.
 - CT02 Internal ceiling: 13mm GIB AQUALINE ceiling lining fixed to ex75x40mm SG8 timber battens @ 600 crs on 140x45mm joists @ 450 crs covered with 19mm marine ply. Max load 1.5kPa.
 - CT03 Underside of stairs: 16mm GIB FYRLINE lining to underside of timber stair structure in accordance with GIB spec - GBFC60. FR 60/60/60 fire rated lining to extend through to fire rated wall structure

- walls:**
- WT01 150mm FR 180/180/180 thick pre-cast concrete panel walls - refer structural and fire engineers documentation.
 - WT02 Office fire walls: FR 60/60/60 ex150x50 SG8 wall framing with studs at 600 centres lined with 13mm GIB FYRLINE lining to both sides in accordance with GIB specification - GIBTL60. Walls to extend to underside of roof above.
 - WT03 external walls: ex150x50 SG8 wall framing with studs at 600 centres lined with 13mm standard GIB board inside in accordance with GIB specification - GBUW 15. Walls to extend to underside of roof above.
 - WT04 Internal walls: ex100x50 SG8 wall framing with studs at 600 centres lined with 10mm standard GIB board lining to interior. 10mm GIB AQUALINE to be used in wet areas. Where vinyl is continued up wall WPS water proofing membrane to be used in strict accordance with manufacturers specification. Face of office walls to warehouse finished with 9.5mm selected plywood to a height of 2.4m above finished floor level.
 - WT05 Office cladding: METALCRAFT KAHU cladding with COLORSTEEL ENDURA finish fixed vertically over 20mm cavity battens over COVERTEK 403 building wrap on ex150x50 SG8 wall framing with studs at 600 centres. Insulated cavity with AUTEX insulation min R2.5
 - WT06 Warehouse wall cladding: METALCRAFT KAHU cladding with COLORSTEEL ENDURA finish fixed horizontally over 20mm cavity battens over COVERTEK 403 building wrap on precast concrete panel walls.
 - WT07 Joinery: VANTAGE external window 125 FLUSHGLAZE suite in seismic frames with powder coated finish and Magnum door.
 - WT08 Joinery: VANTAGE 40 external window METRO suite with powder coated finish.
 - WT09 Roller door: METALBILT motorised roller shutter door powder coated finish on windsocks all with metal chain and manual back-up.
 - WT10 Horizontal sun screens: INSOL zenith Al sun screen with selected powdercoat finish. Refer manufacturers specifications for all fixings and structural information.
 - WT11 Internal strapped walls: ex50x50 SG8 timber strapping at 600 centres lined with 10mm standard GIB board lining to interior. 10mm GIB AQUALINE to be used in wet areas. AUTEX batt insulation to provide min. R2.5
 - WT12 Internal walls: ex150x50 SG8 wall framing with studs at 600 centres lined with 10mm standard GIB board lining to interior. 10mm GIB AQUALINE to be used in wet areas. Where vinyl is continued up wall WPS water proofing membrane to be used in strict accordance with manufacturers specification. Face of office walls to warehouse finished with 9.5mm selected plywood to a height of 2.4m above finished floor level.

- floors:**
- FT01 Warehouse floor: 150mm thick reinforced concrete slab foundation on DPM and sand blinding on minimum 150mm thick compacted hard fill - refer structural engineers documentation for all structural information.
 - FT02 Office ground floor: 150mm thick reinforced concrete slab foundation on DPM and sand blinding on minimum 150mm thick compacted hard fill - refer structural engineer.
 - FT03 Office first floor: FRR 60/60/60 150mm thick Comfor - refer structural engineer.
 - FT04 Selected commercial grade vinyl flooring

- structural:**
- ST01 Structural framing - refer structural engineer documentation for all structural detail.

- note:**
- All materials, fittings, fixtures, and finishes to be established in strict accordance with manufactures specification.
- This architectural documentation is to be read in conjunction with all specialist documentation and reports. Refer to engineering documentation for all engineering requirements.
- fire design requirements:**
- All precast concrete panel walls to provide FR 180/180/180 (150 thick). Ground floor office to be fire rated and separate to the first floor fire cell - all fire rated FR 60/60/60. All supporting structure, stairs and underside of floors to be fire rated FR 60/60/60.
- FD = fire door. Refer fire report for all fire design requirements.
- W03 Window joinery - Refer D & W schedule
- Refer finishes plans for floor, wall & ceiling finishes

NOTE:
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PROJECT:

Te Rapa Stage 2


CLIENT: Fosters Construction
SITE: Te Rapa Industrial Park, Hamilton

DRAWING TITLE:


PART PLANS - BUILDING 04

FOR CONSTRUCTION ISSUE

PROJECT REF:		T0424 TE RAPA S2	
DATE:	SCALE:	25/06/19	1:50 @ A1
SHEET:	REV:	A10	C01

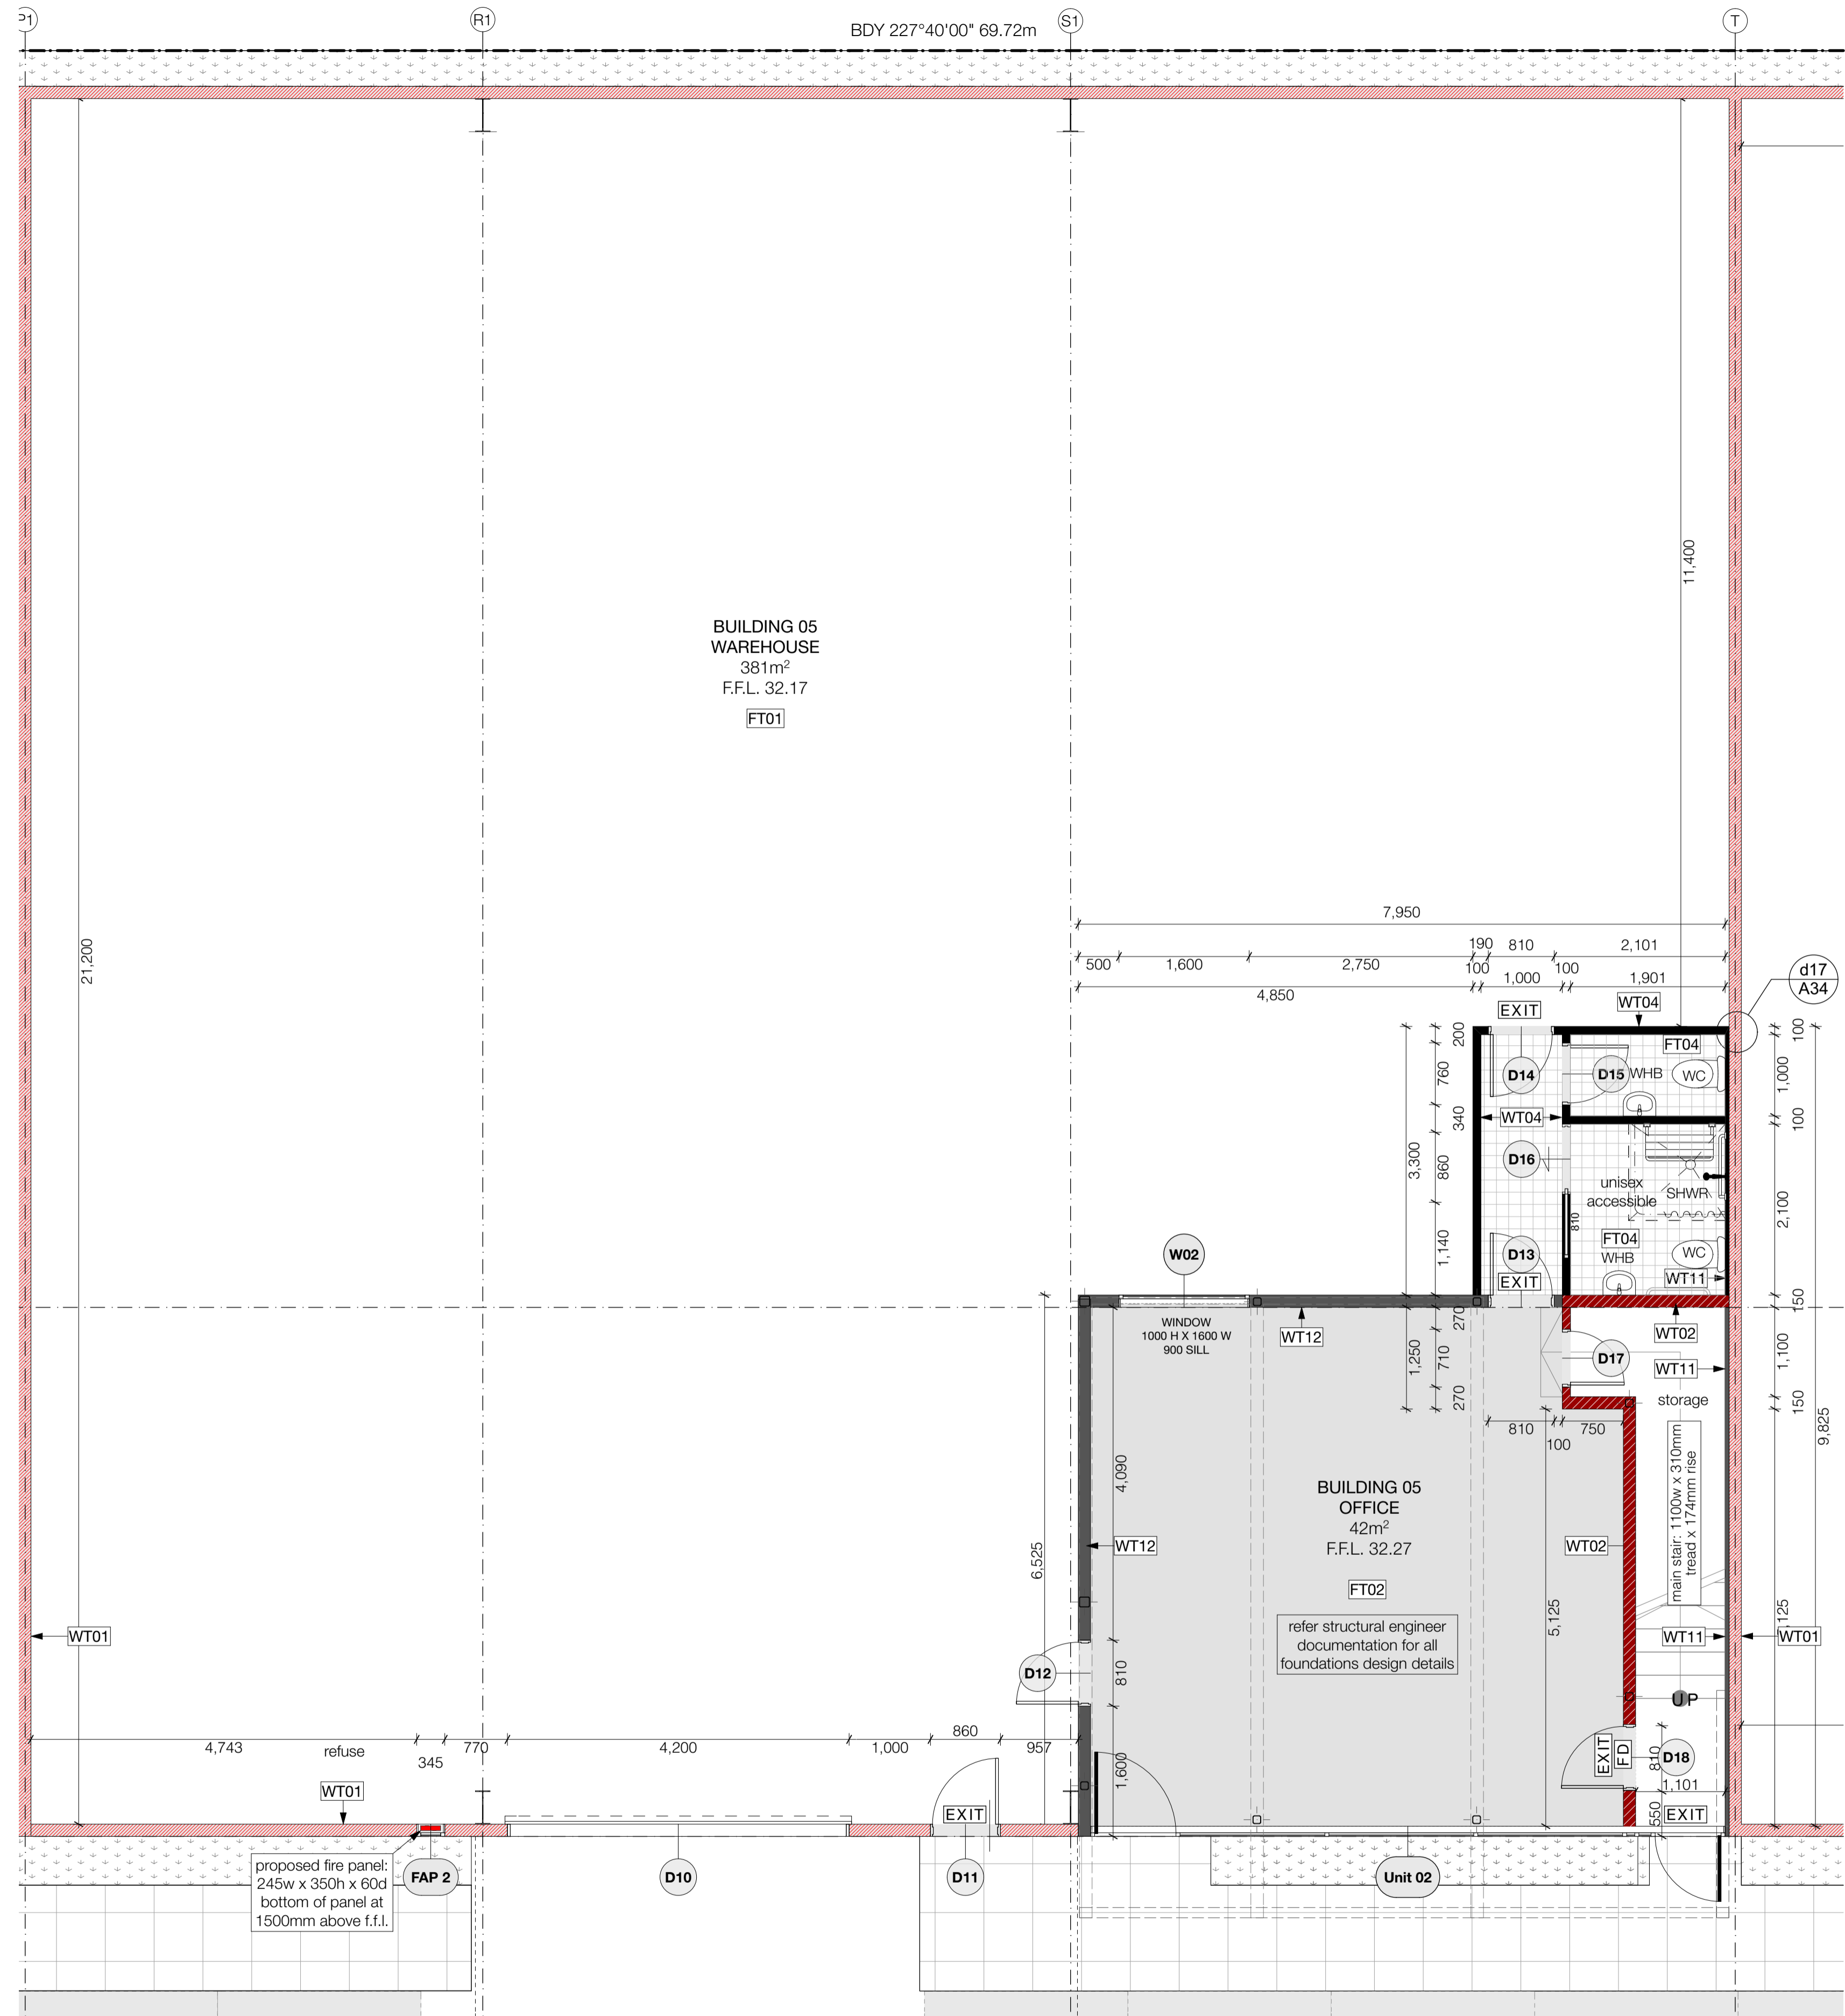

GROUND FLOOR PLAN - BUILDING 05
Scale:1:50

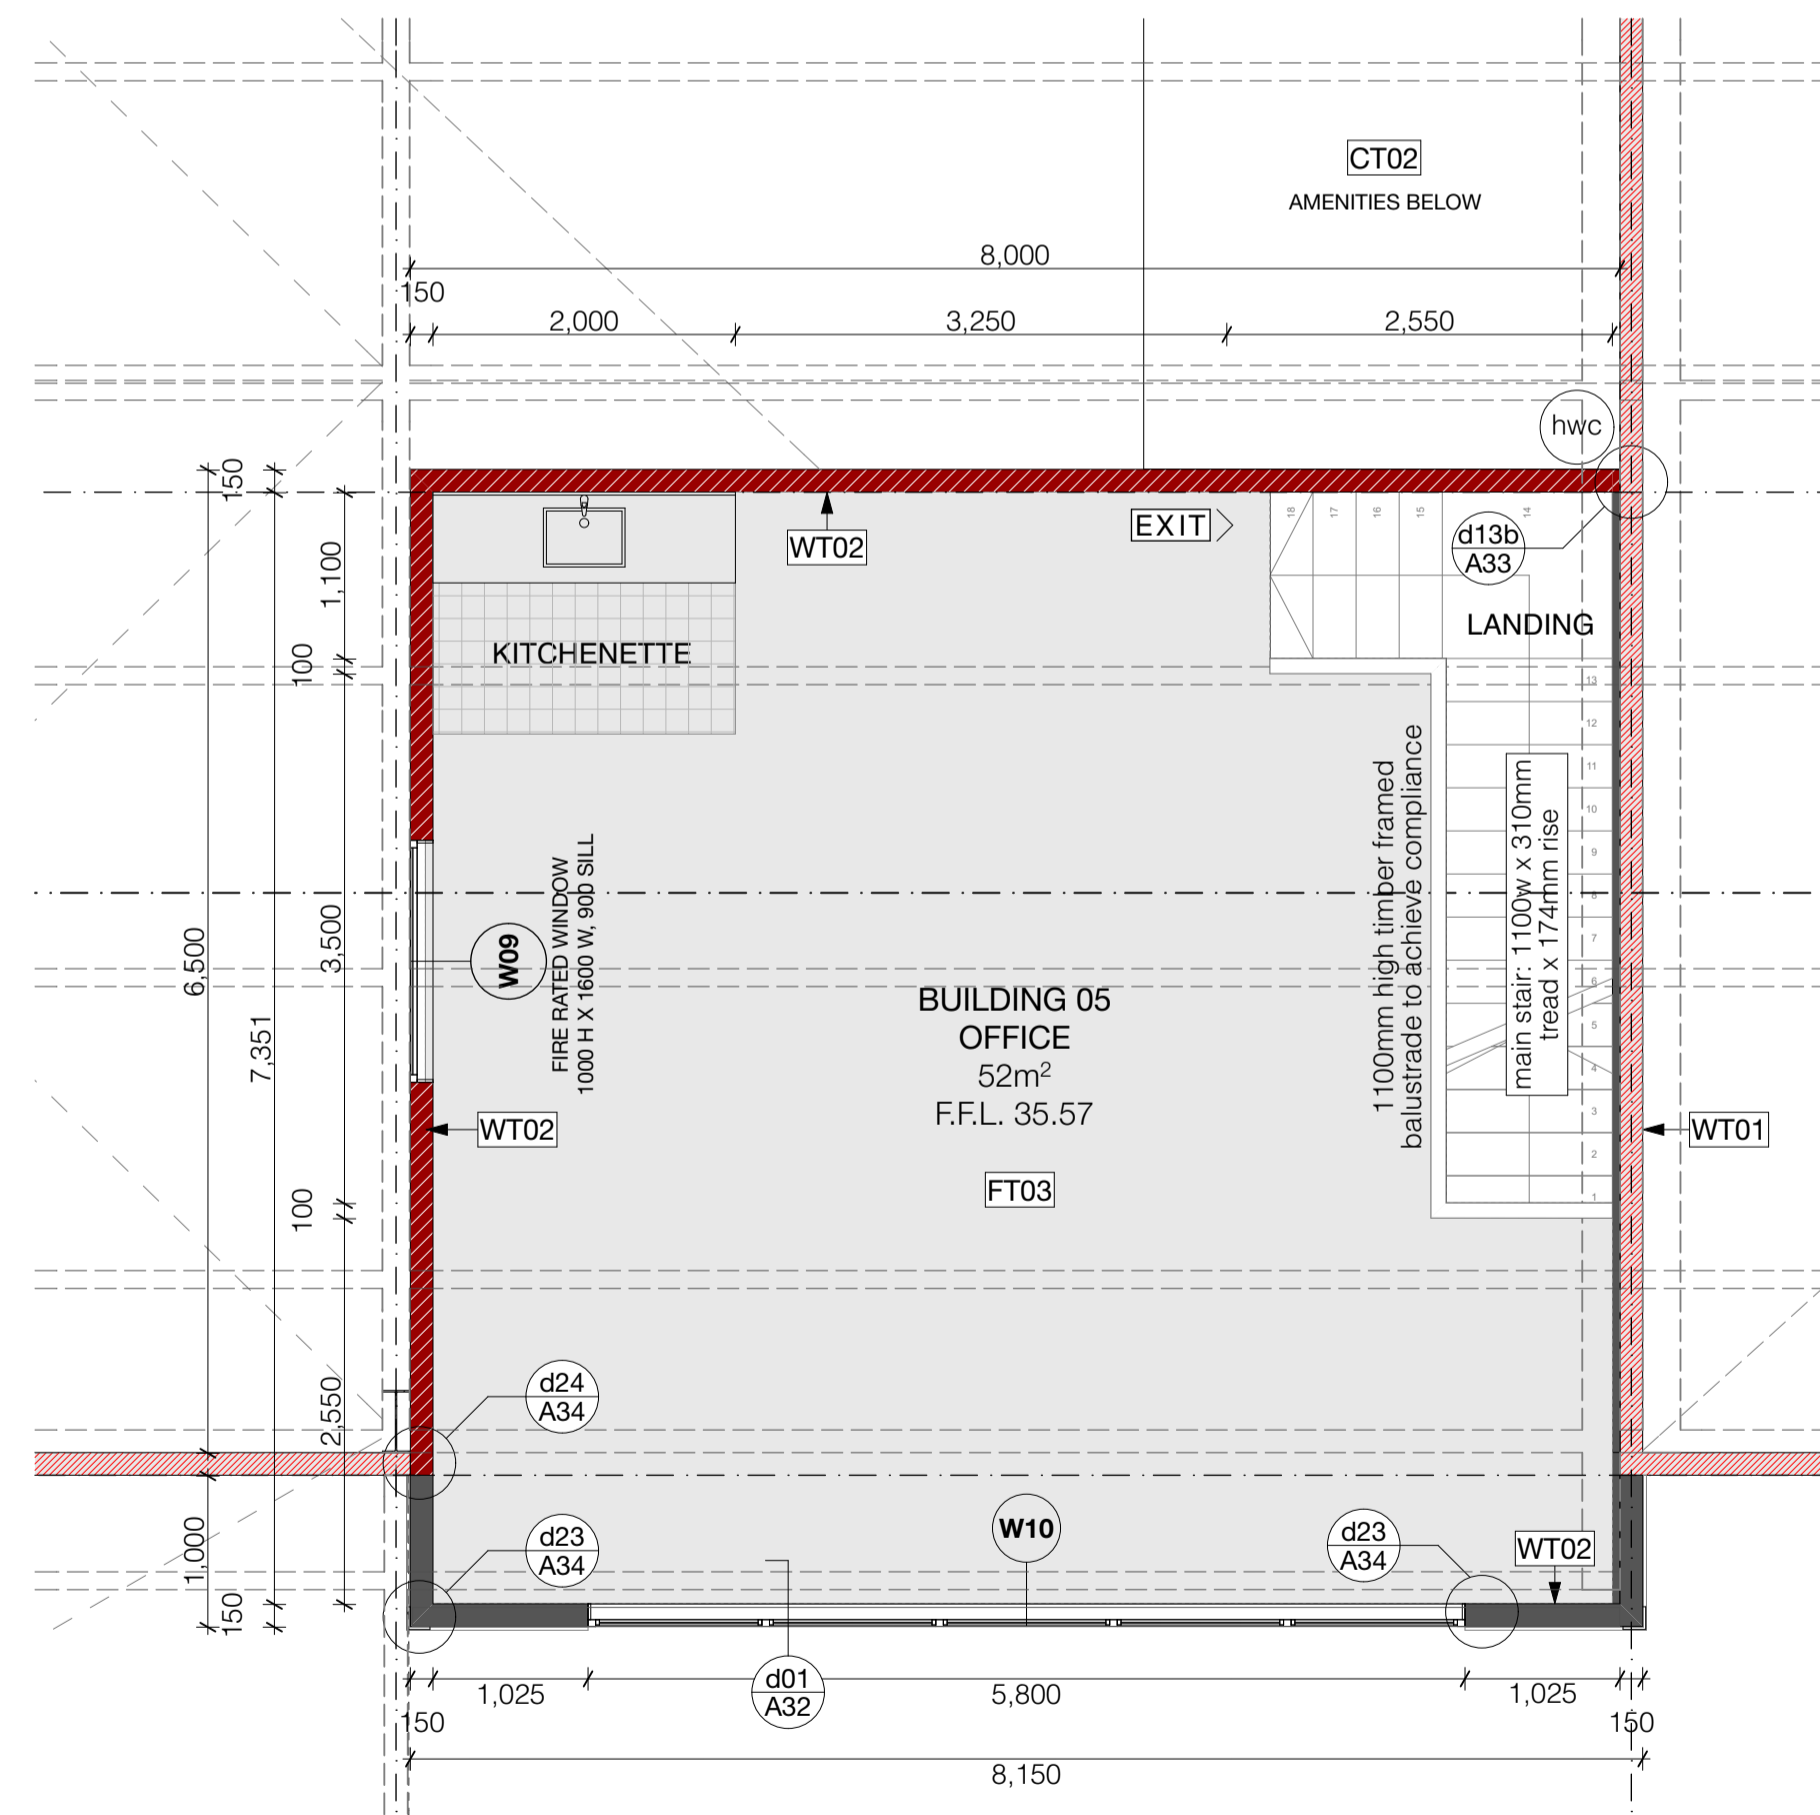

FIRST FLOOR PLAN - BUILDING 05
Scale:1:50

WALL TYPE KEY:

- 150mm thick concrete cast panel 180/180/180 fire walls
- 100mm thick internal GIB fyrline office 60/60/60 fire walls
- 140mm thick GIB fyrline office 60/60/60 fire walls
- 100mm thick internal GIB wall
- 140mm thick office wall
- 100mm thick 1100mm stair balustrade

- main notes:**
- roof:**
 - RT01 Roof: 0.55 BMT Dimond BB900 profiled COLORSTEEL roofing with ENDURA finish over selected THERMAKRAFT COVERTEK 405 roofing underlay over safety mesh on roof structure. Office roof cavity insulated with AUTEX greenstuf insulation to achieve min. R3.0
 - RT02 External gutter: 0.55 BMT box gutter with COLORSTEEL ENDURA finish fixed with hidden brackets to manufacturers specification.
 - RT03 Parapet / apron roof flashings: 0.55 BMT machine folded flashings with COLORSTEEL ENDURA finish.
 - RT04 Warehouse roof skylight: AMPELITE SL translucent sheet roofing to match profile of roof fixed over THERMAKRAFT AUSMESH safety mesh (galv. coated) on roof structure - to provide 15% daylighting to warehouse space.
 - RT05 Canopy Roof & Soffit: 0.55 BMT Dimond BB900 profiled COLORSTEEL roofing with ENDURA finish over roof structure and to underside of soffit to provide bird proofing.
 - ceiling:**
 - CT01 Internal office ceiling: USG DONN DX suspended ceiling grid system with selected 1200x600 mineral fibre ceiling tiles SLT edged.
 - CT02 Internal ceiling: 13mm GIB AQUALINE ceiling lining fixed to ex75x40mm SG8 timber battens @ 600 crs on 140x45mm joists @ 450 crs covered with 19mm marine ply. Max load 1.5kPa.
 - CT03 Underside of stairs: 16mm GIB FYRLINE lining to underside of timber stair structure in accordance with GIB spec - GBFC60. FR 60/60/60 fire rated lining to extend through to fire rated wall structure
 - walls:**
 - WT01 150mm FR 180/180/180 thick pre-cast concrete panel walls - refer structural and fire engineers documentation.
 - WT02 Office fire walls: FR 60/60/60 ex150x50 SG8 wall framing with studs at 600 centres lined with 13mm GIB FYRLINE lining to both sides in accordance with GIB specification - GIBTL60. Walls to extend to underside of roof above.
 - WT03 external walls: ex150x50 SG8 wall framing with studs at 600 centres lined with 13mm standard GIB board inside in accordance with GIB specification - GBUW 15. Walls to extend to underside of roof above.
 - WT04 Internal walls: ex100x50 SG8 wall framing with studs at 600 centres lined with 10mm standard GIB board lining to interior. 10mm GIB AQUALINE to be used in wet areas. Where vinyl is continued up wall WPS water proofing membrane to be used in strict accordance with manufacturers specification. Face of office walls to warehouse finished with 9.5mm selected plywood to a height of 2.4m above finished floor level.
 - WT05 Office cladding: METALCRAFT KAHU cladding with COLORSTEEL ENDURA finish fixed vertically over 20mm cavity battens over COVERTEK 403 building wrap on ex150x50 SG8 wall framing with studs at 600 centres. Insulated cavity with AUTEX insulation min R2.5
 - WT06 Warehouse wall cladding: METALCRAFT KAHU cladding with COLORSTEEL ENDURA finish fixed horizontally over 20mm cavity battens over COVERTEK 403 building wrap on precast concrete panel walls.
 - WT07 Joinery: VANTAGE external window 125 FLUSHGLAZE suite in seismic frames with powder coated finish and Magnum door.
 - WT08 Joinery: VANTAGE 40 external window METRO suite with powder coated finish.
 - WT09 Roller door: METALBILT motorised roller shutter door powder coated finish on windsocks all with metal chain and manual back-up.
 - WT10 Horizontal sun screens: INSQL zenith AI sun screen with selected powdercoat finish. Refer manufacturers specifications for all fixings and structural information.
 - WT11 Internal strapped walls: ex50x50 SG8 timber strapping at 600 centres with 10mm standard GIB board lining to interior. 10mm GIB AQUALINE to be used in wet areas. AUTEX batt insulation to provide min. R2.5
 - WT12 Internal walls: ex150x50 SG8 wall framing with studs at 600 centres lined with 10mm standard GIB board lining to interior. 10mm GIB AQUALINE to be used in wet areas. Where vinyl is continued up wall WPS water proofing membrane to be used in strict accordance with manufacturers specification. Face of office walls to warehouse finished with 9.5mm selected plywood to a height of 2.4m above finished floor level.
 - floors:**
 - FT01 Warehouse floor: 150mm thick reinforced concrete slab foundation on DPM and sand blinding on minimum 150mm thick compacted hard fill - refer structural engineers documentation for all structural information.
 - FT02 Office ground floor: 150mm thick reinforced concrete slab foundation on DPM and sand blinding on minimum 150mm thick compacted hard fill - refer structural engineer.
 - FT03 Office first floor: FRR 60/60/60 150mm thick Comfor - refer structural engineer.
 - FT04 Selected commercial grade vinyl flooring
 - structural:**
 - ST01 Structural framing - refer structural engineer documentation for all structural detail.
 - note:**

All materials, fittings, fixtures, and finishes to be established in strict accordance with manufactures specification.

This architectural documentation is to be read in conjunction with all specialist documentation and reports. Refer to engineering documentation for all engineering requirements.
 - fire design requirements:**

All precast concrete panel walls to provide FR 180/180/180 (150 thick). Ground floor office to be fire rated and separate to the first floor fire cell - all fire rated FR 60/60/60. All supporting structure, stairs and underside of floors to be fire rated FR 60/60/60.
 - FD** FD = fire door. Refer fire report for all fire design requirements.
 - W03** Window joinery - Refer D & W schedule
- Refer finishes plans for floor, wall & ceiling finishes

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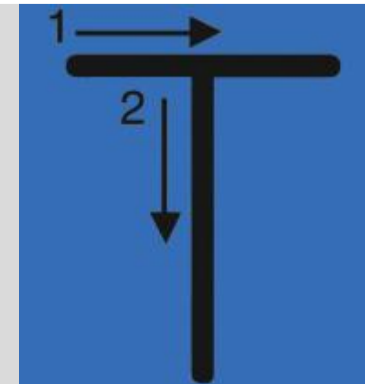
C01

DATE:

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PROJECT:

Te Rapa Stage 2

CLIENT: Fosters Construction
SITE: Te Rapa Industrial Park, Hamilton

FOR CONSTRUCTION ISSUE

DRAWING TITLE:

PART PLANS - BUILDING 05

PROJECT REF:

T0424 TE RAPA S2

DATE:

25/06/19

SHEET:

A11

SCALE:

1:50 @ A1

REV:


C01

main notes:


- roof:**
- RT01 Roof: 0.55 BMT Dimond BB900 profiled COLORSTEEL roofing with ENDURA finish over selected THERMAKRAFT COVERTEK 405 roofing underlay over safety mesh on roof structure. Office roof cavity insulated with AUTEX greenstuff insulation to achieve min. R3.0
 - RT02 External gutter: 0.55 BMT box gutter with COLORSTEEL ENDURA finish fixed with hidden brackets to manufacturers specification.
 - RT03 Parapet / apron roof flashings: 0.55 BMT machine folded flashings with COLORSTEEL ENDURA finish.
 - RT04 Warehouse roof skylight: AMPELITE SL translucent sheet roofing to match profile of roof fixed over THERMAKRAFT AUSMESH safety mesh (galv. coated) on roof structure - to provide 15% daylighting to warehouse space.
 - RT05 Canopy Roof & Soffit: 0.55 BMT Dimond BB900 profiled COLORSTEEL roofing with ENDURA finish over roof structure and to underside of soffit to provide bird proofing.
- ceiling:**
- CT01 Internal office ceiling: USG DONN DX suspended ceiling grid system with selected 1200x600 mineral fibre ceiling tiles SLT edged.
 - CT02 Internal ceiling: 13mm GIB AQUALINE ceiling lining fixed to ex75x40mm SG8 timber battens @ 600 crs on 140x45mm joists @ 450 crs covered with 19mm marine ply. Max load 1.5kPa.
 - CT03 Underside of stairs: 16mm GIB FYRLINE lining to underside of timber stair structure in accordance with GIB spec - GBFC60. FR 60/60/60 fire rated lining to extend through to fire rated wall structure
- walls:**
- WT01 150mm FR 180/180/180 thick pre-cast concrete panel walls - refer structural and fire engineers documentation.
 - WT02 Office fire walls: FR 60/60/60 ex150x50 SG8 wall framing with studs at 600 centres lined with 13mm GIB FYRLINE lining to both sides in accordance with GIB specification GBTL60. Walls to extend to underside of roof above.
 - WT03 external walls: ex150x50 SG8 wall framing with studs at 600 centres lined with 13mm standard GIB board inside in accordance with GIB specification - GBUW 15. Walls to extend to underside of roof above.
 - WT04 Internal walls: ex100x50 SG8 wall framing with studs at 600 centres lined with 10mm standard GIB board lining to interior. 10mm GIB AQUALINE to be used in wet areas. Where vinyl is continued up wall WPS water proofing membrane to be used in strict accordance with manufacturers specification. Face of office walls to warehouse finished with 9.5mm selected plywood to a height of 2.4m above finished floor level.
 - WT05 Office cladding: METALCRAFT KAHU cladding with COLORSTEEL ENDURA finish fixed vertically over 20mm cavity battens over COVERTEK 403 building wrap on ex150x50 SG8 wall framing with studs at 600 centres. Insulated cavity with AUTEX insulation min R2.5
 - WT06 Warehouse wall cladding: METALCRAFT KAHU cladding with COLORSTEEL ENDURA finish fixed horizontally over 20mm cavity battens over COVERTEK 403 building wrap on precast concrete panel walls.
 - WT07 Joinery: VANTAGE external window 125 FLUSHGLAZE suite in seismic frames with powder coated finish and Magnum door.
 - WT08 Joinery: VANTAGE 40 external window METRO suite with powder coated finish.
 - WT09 Roller door: METALBLIT motorised roller shutter door powder coated finish on windssocks all with metal chain and manual back-up.
 - WT10 Horizontal sun screens: INSQL zenith AI sun screen with selected powdercoat finish. Refer manufacturers specifications for all fixings and structural information.
 - WT11 Internal strapped walls: ex50x50 SG8 timber strapping at 600 centres lined with 10mm standard GIB board lining to interior. 10mm GIB AQUALINE to be used in wet areas. AUTEX batt insulation to provide min. R2.5
 - WT12 Internal walls: ex150x50 SG8 wall framing with studs at 600 centres lined with 10mm standard GIB board lining to interior. 10mm GIB AQUALINE to be used in wet areas. Where vinyl is continued up wall WPS water proofing membrane to be used in strict accordance with manufacturers specification. Face of office walls to warehouse finished with 9.5mm selected plywood to a height of 2.4m above finished floor level.
- floors:**
- FT01 Warehouse floor: 150mm thick reinforced concrete slab foundation on DPM and sand blinding on minimum 150mm thick compacted hard fill - refer structural engineers documentation for all structural information.
 - FT02 Office ground floor: 150mm thick reinforced concrete slab foundation on DPM and sand blinding on minimum 150mm thick compacted hard fill - refer structural engineer.
 - FT03 Office first floor: FRR 60/60/60 150mm thick Comfloor - refer structural engineer.
 - FT04 Selected commercial grade vinyl flooring
- structural:**
- ST01 Structural framing - refer structural engineer documentation for all structural detail.
- note:**
- All materials, fittings, fixtures, and finishes to be established in strict accordance with manufactures specification.
- This architectural documentation is to be read in conjunction with all specialist documentation and reports. Refer to engineering documentation for all engineering requirements.
- fire design requirements:**
- All precast concrete panel walls to provide FR 180/180/180 (150 thick). Ground floor office to be fire rated and separate to the first floor fire cell - all fire rated FR 60/60/60. All supporting structure, stairs and underside of floors to be fire rated FR 60/60/60.
- FD = fire door. Refer fire report for all fire design requirements.
- W03 Window joinery - Refer D & W schedule
- Refer finishes plans for floor, wall & ceiling finishes

WALL TYPE KEY:

- 150mm thick concrete cast panel 180/180/180 fire walls
- 100mm thick internal GIB fyrline office 60/60/60 fire walls
- 140mm thick GIB fyrline office 60/60/60 fire walls
- 100mm thick internal GIB wall
- 140mm thick office wall
- 100mm thick 1100mm stair balustrade

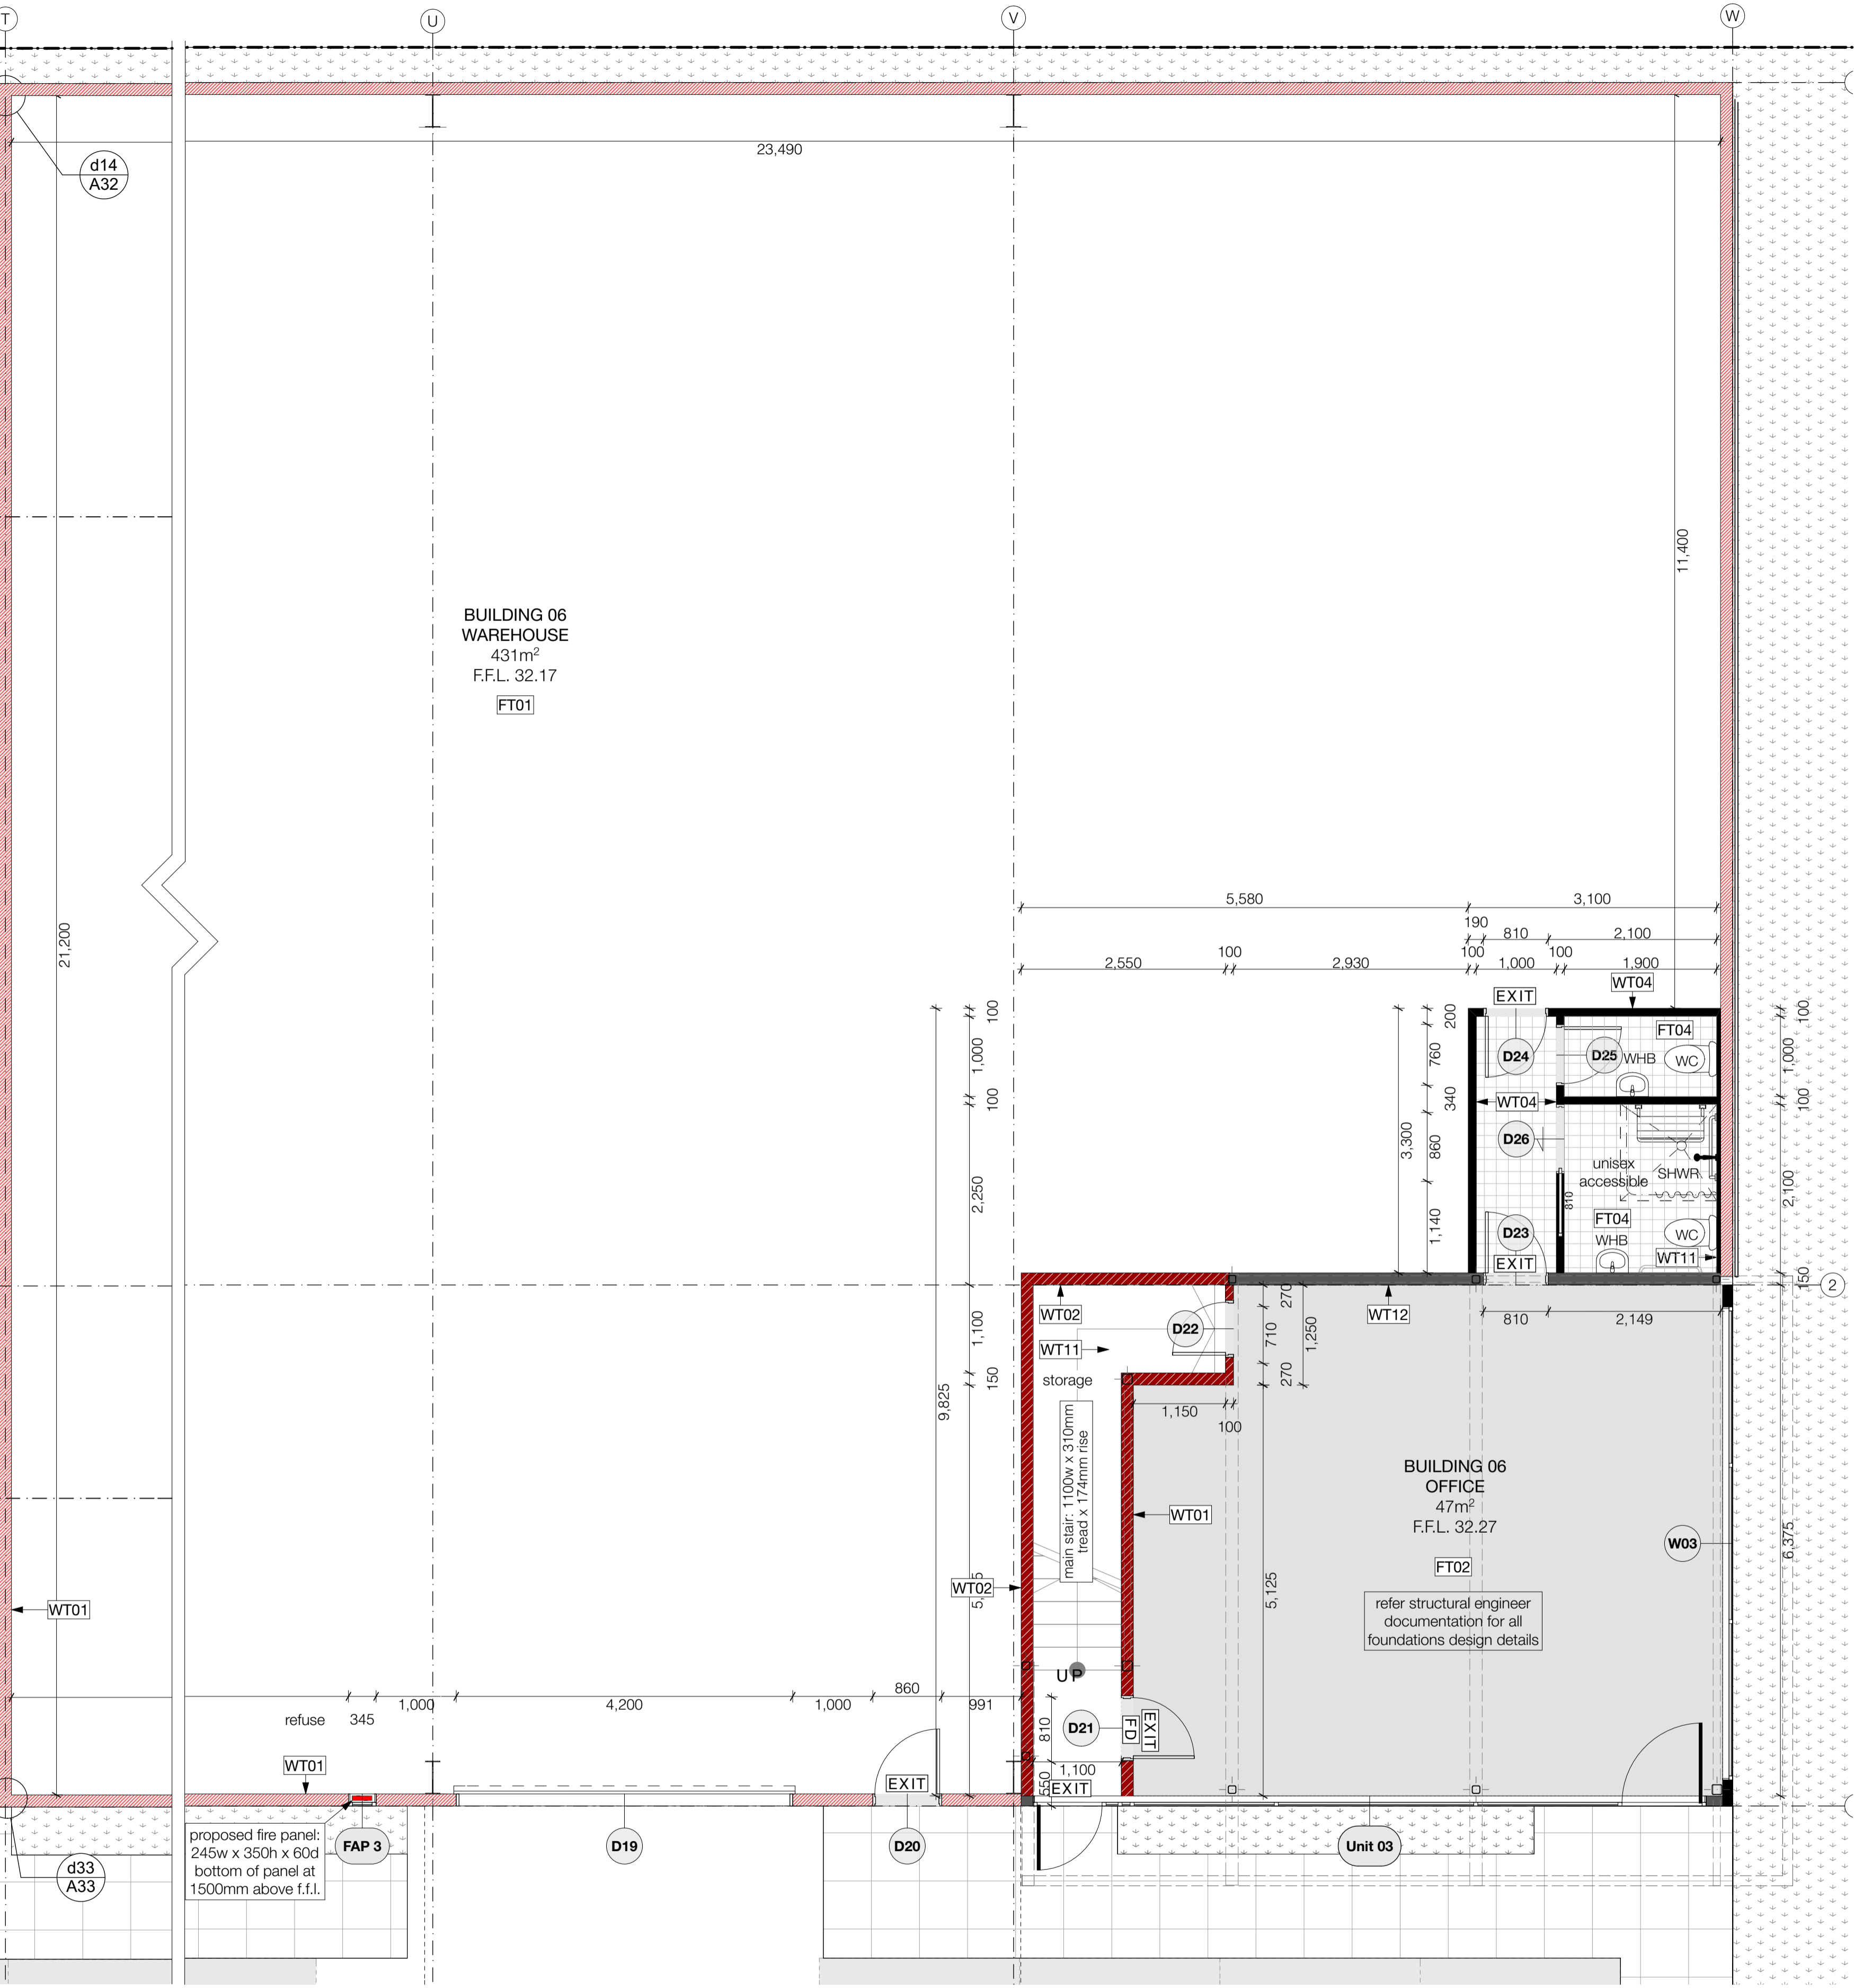

GROUND FLOOR PLAN - BUILDING 06
Scale 1:50

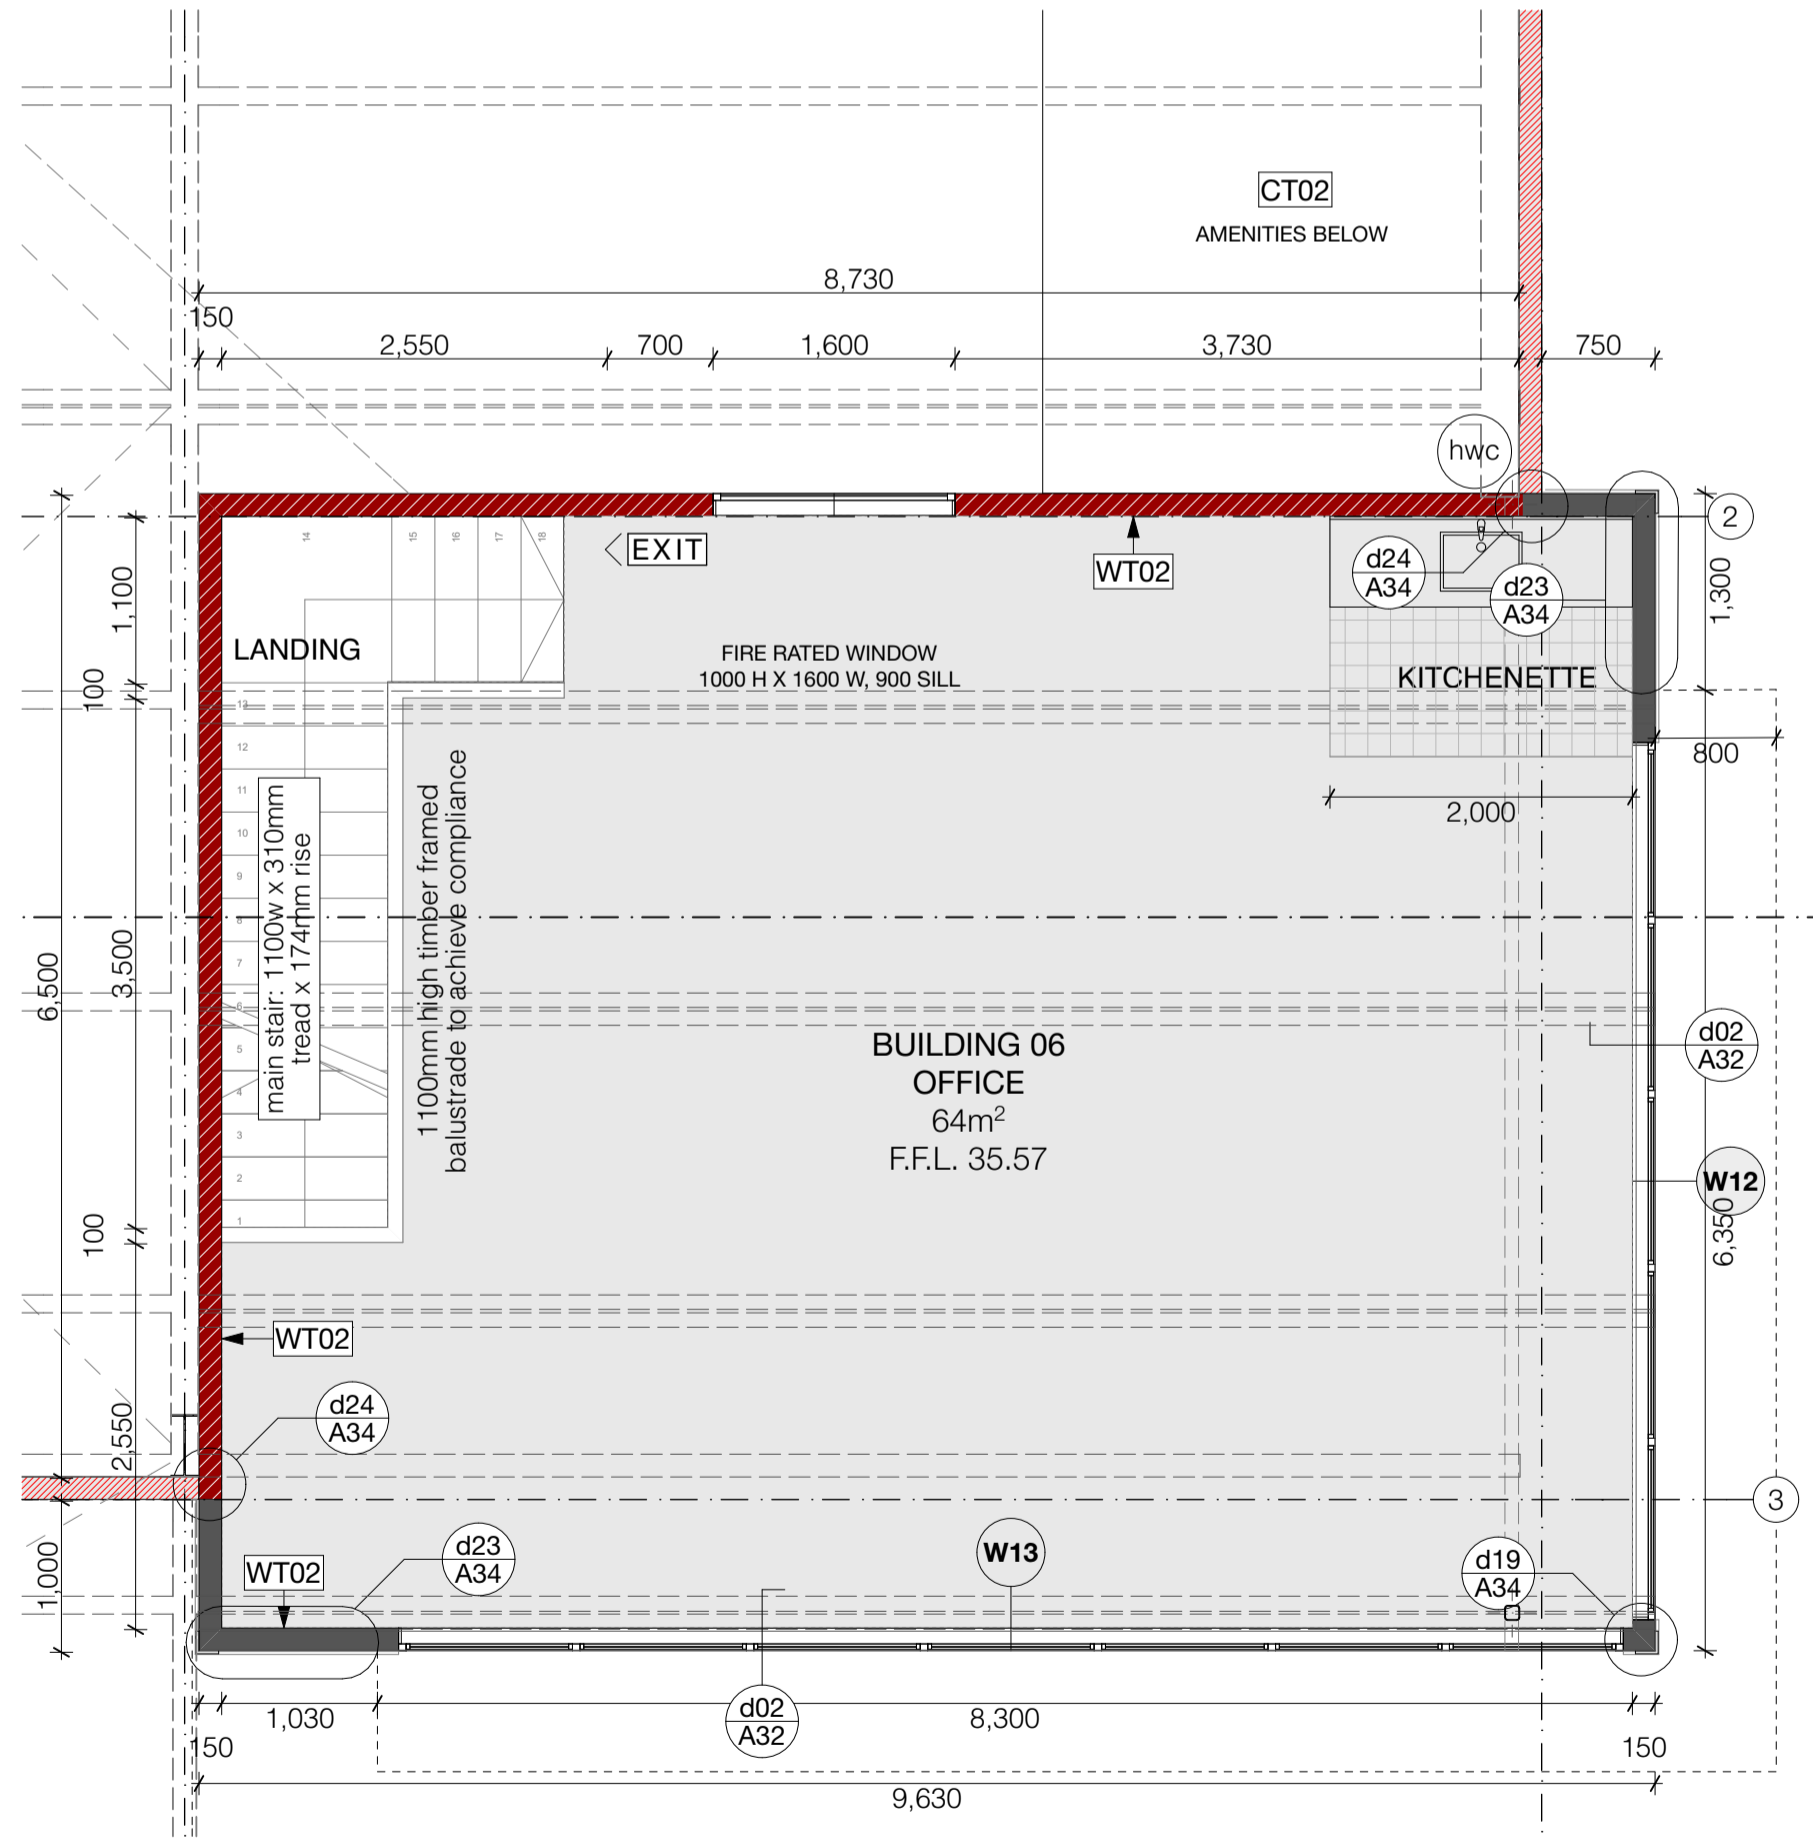

FIRST FLOOR PLAN - BUILDING 06
Scale 1:50

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NOTE:
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FOSTER CONSTRUCTION

ISSUE: C01
DATE: 25/06/19


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PROJECT: Te Rapa Stage 2
CLIENT: Fosters Construction
SITE: Te Rapa Industrial Park, Hamilton

DRAWING TITLE: PART PLANS - BUILDING 06




PROJECT REF: T0424 TE RAPA S2	
DATE: 25/06/19	SCALE: 1:50 @ A1
SHEET: A12	REV: C01



FIRST FLOOR PLUMBING PLAN - BUILDING 03
Scale 1:50

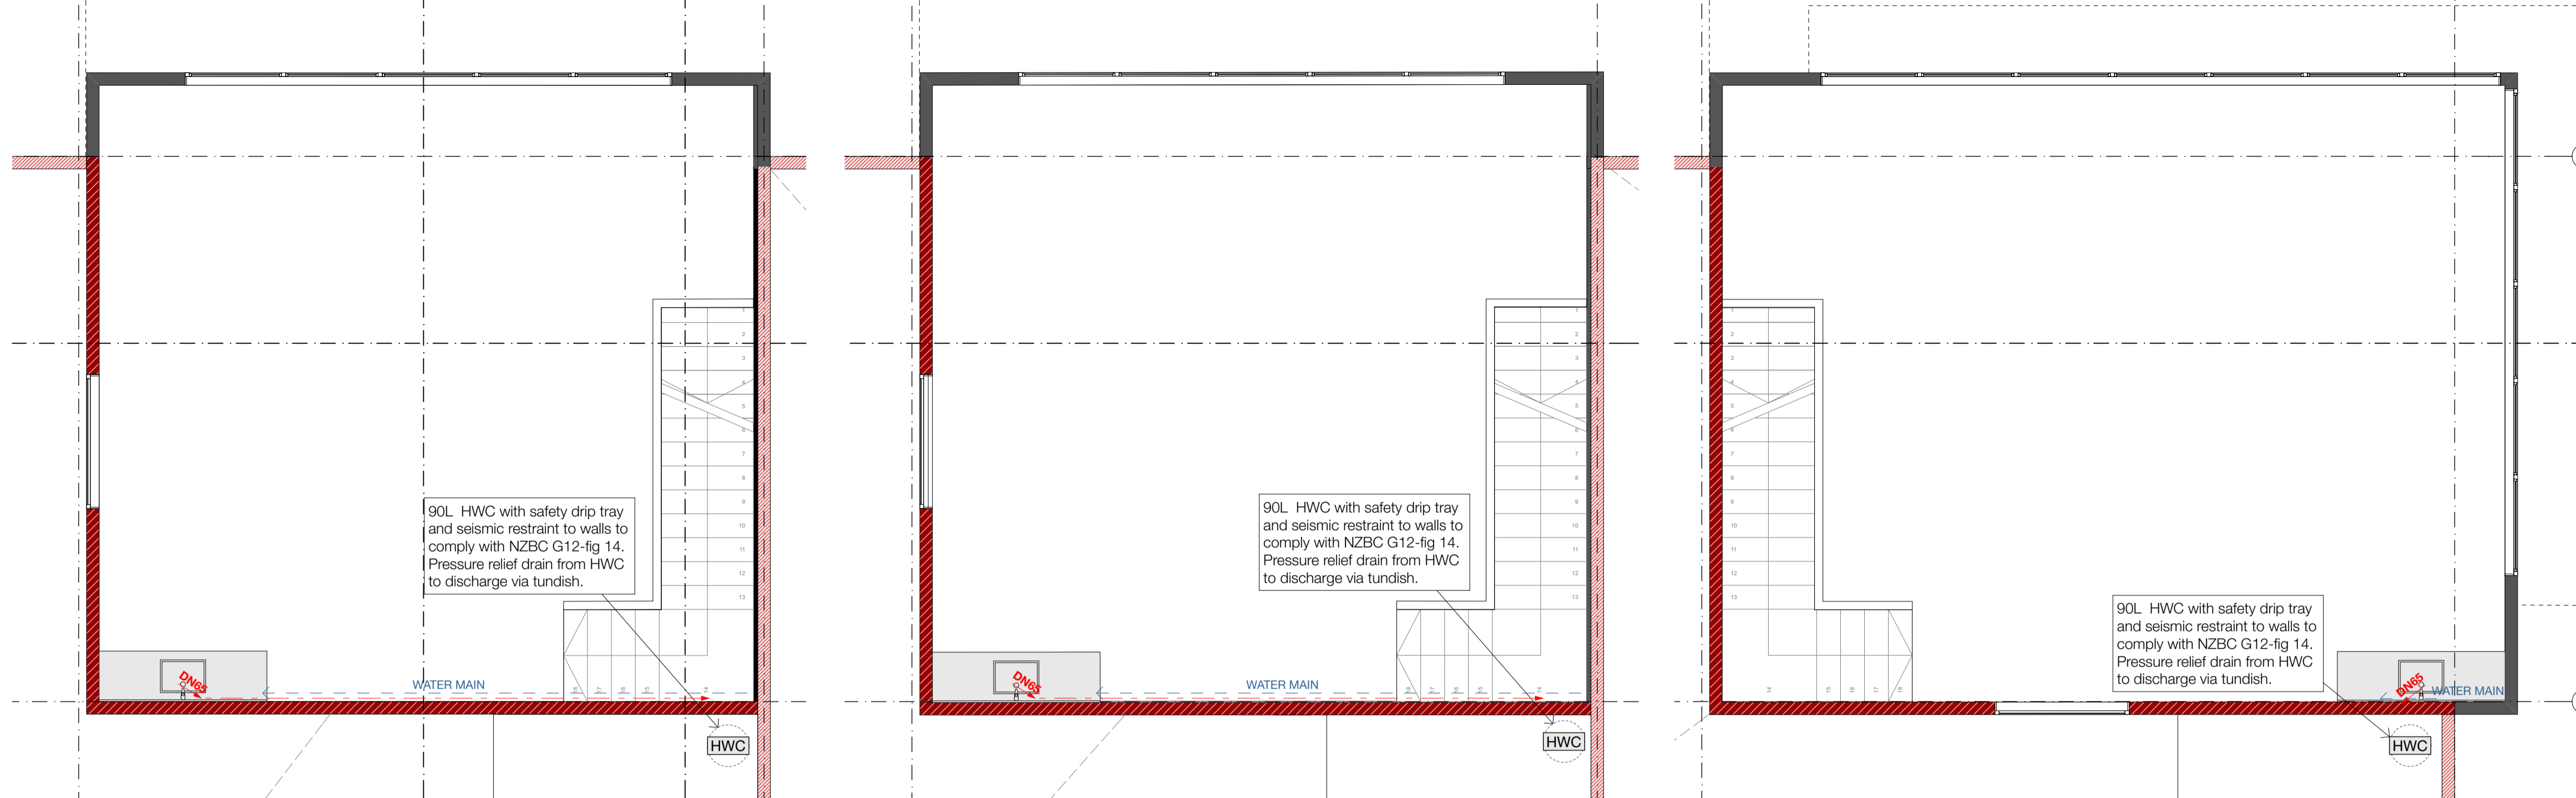FIRST FLOOR PLUMBING PLAN - BUILDING 02
Scale 1:50

FIRST FLOOR PLUMBING PLAN - BUILDING 01
Scale 1:50

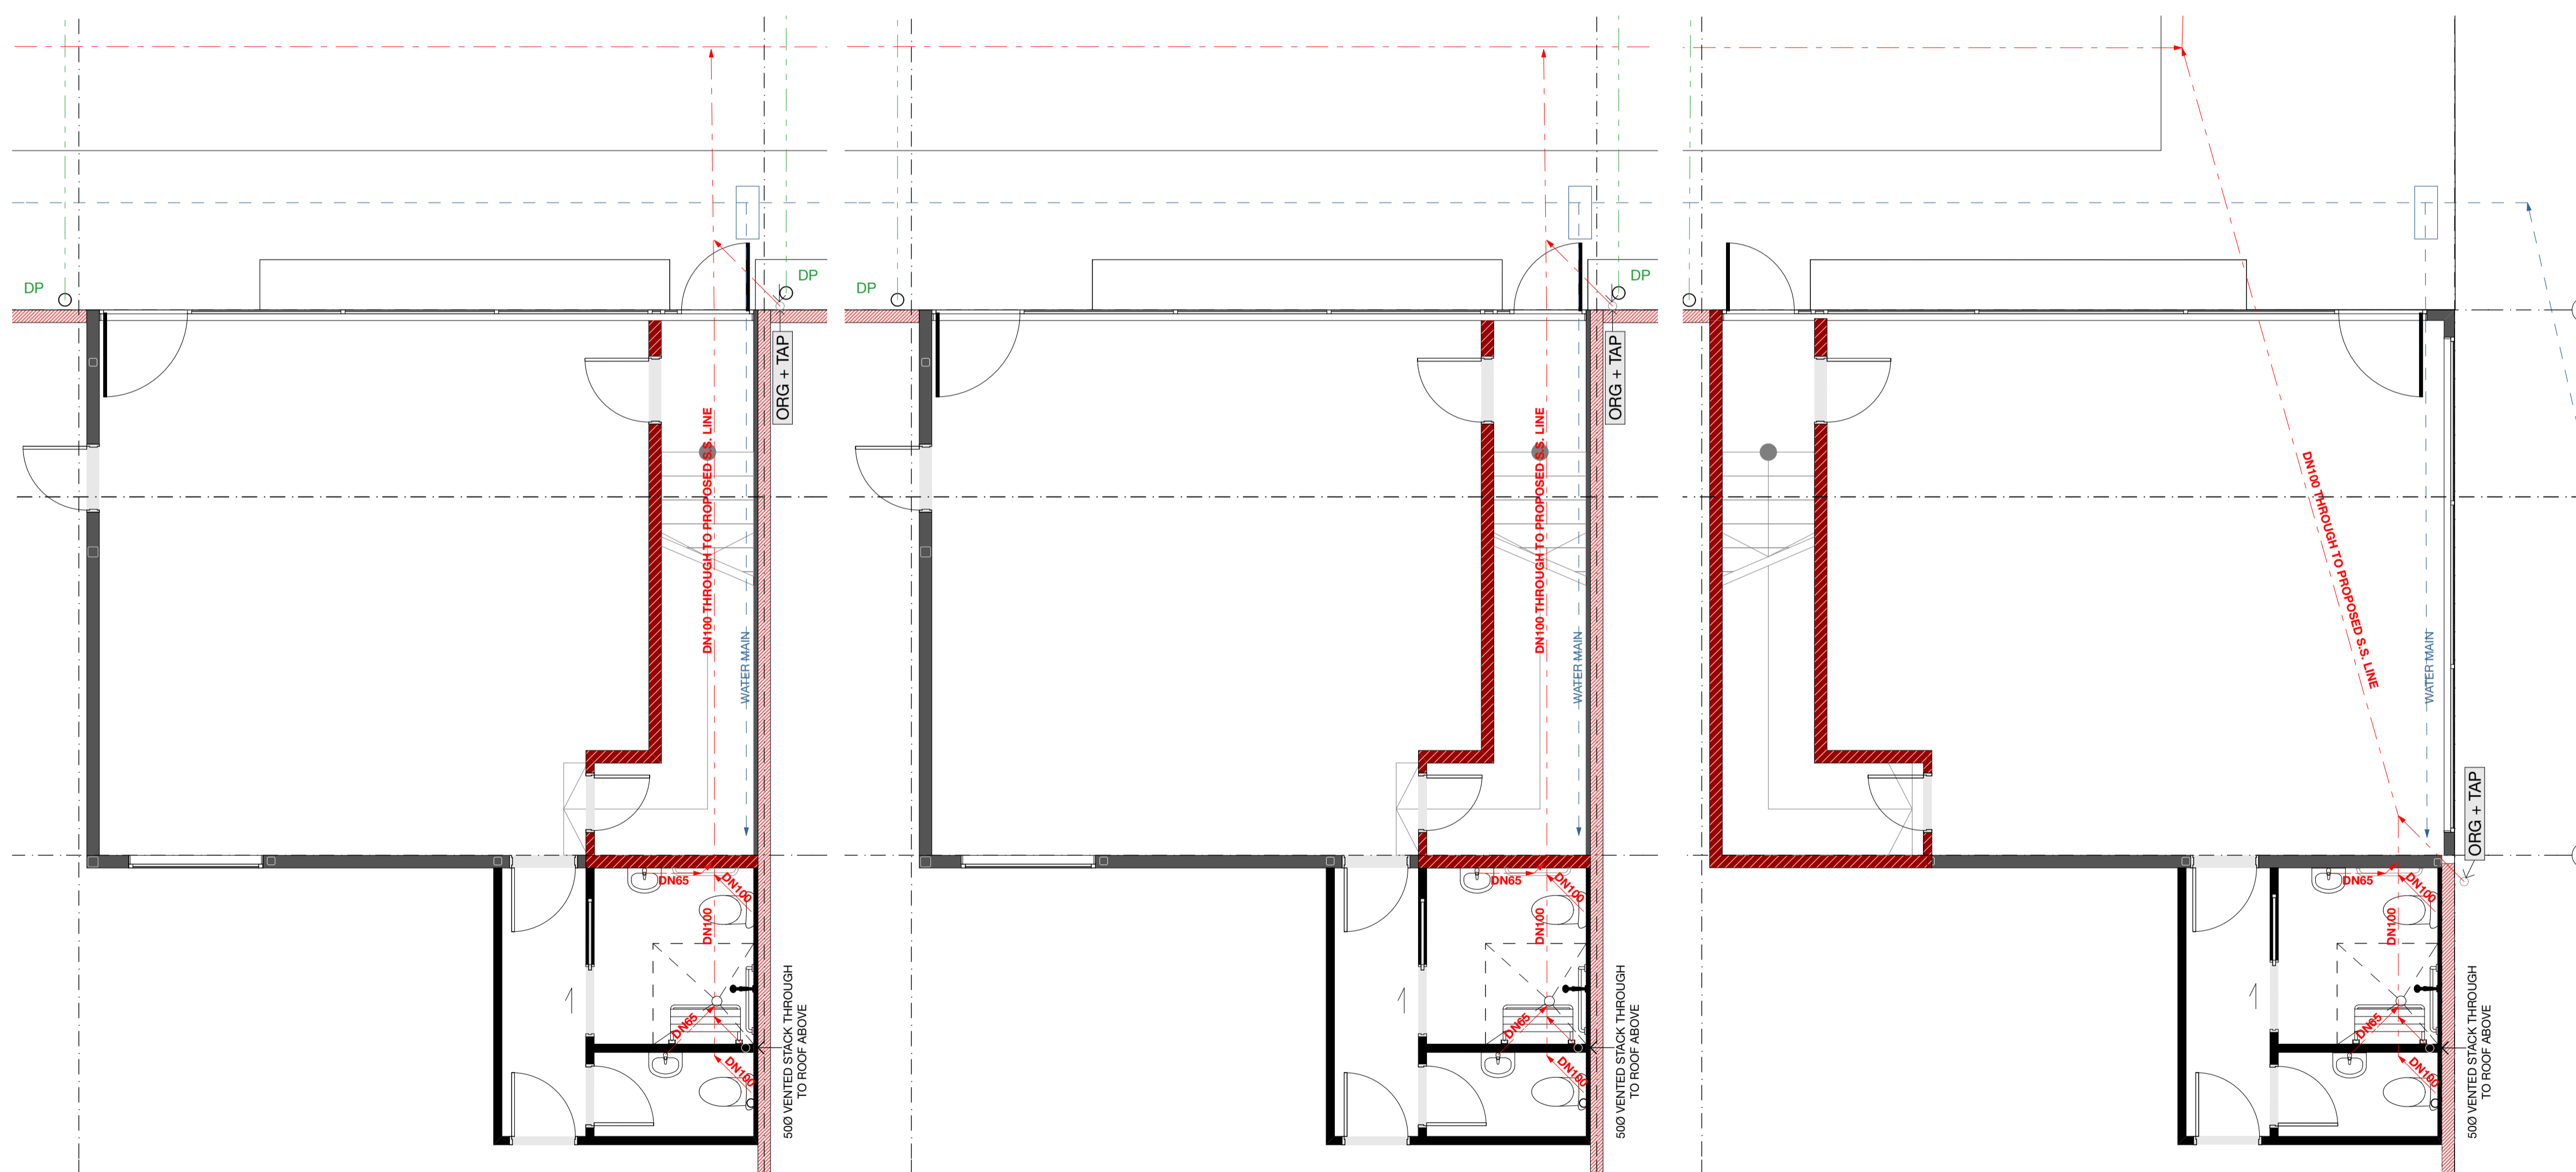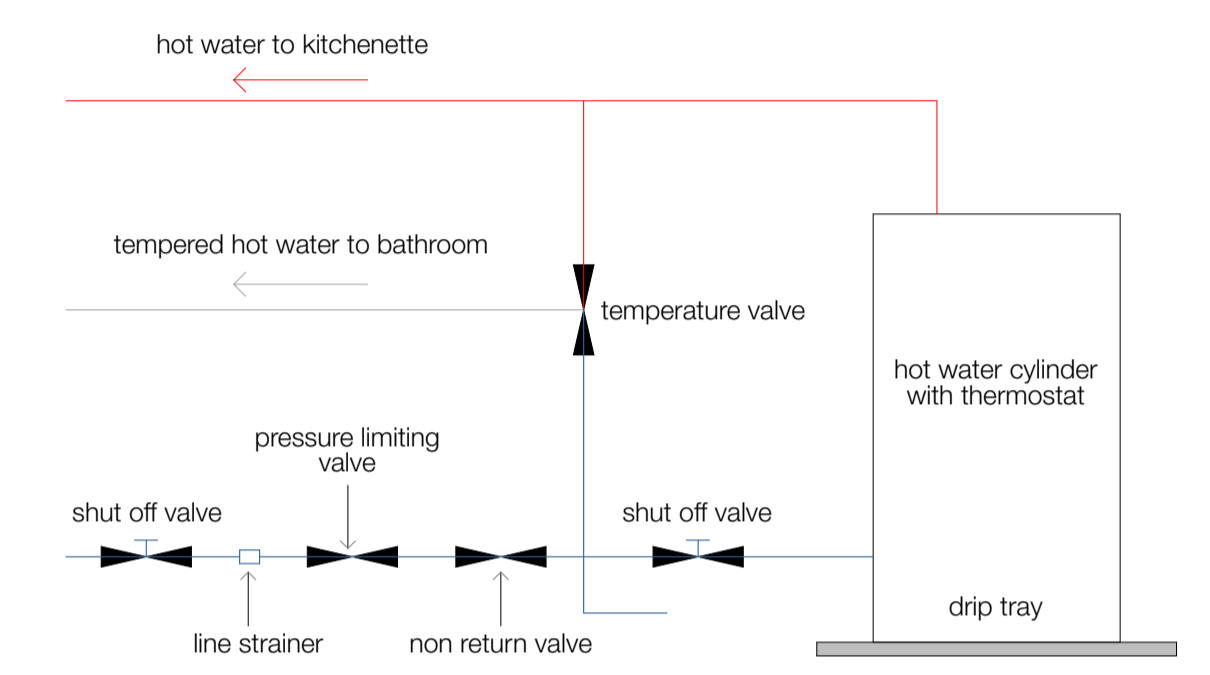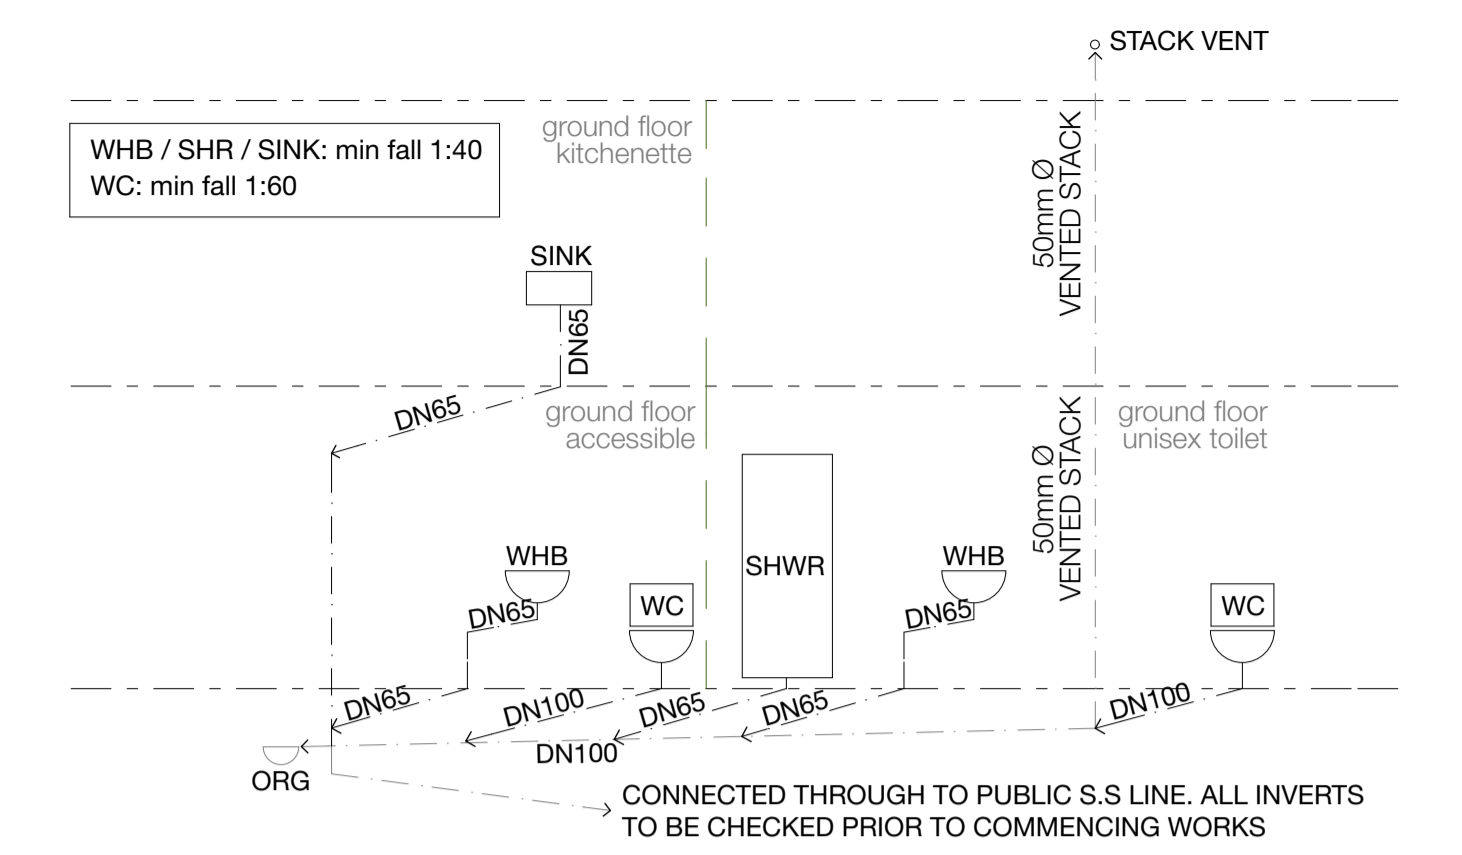

GROUND FLOOR PLUMBING PLAN - BUILDING 03
Scale 1:50

GROUND FLOOR PLUMBING PLAN - BUILDING 02
Scale 1:50

GROUND FLOOR PLUMBING PLAN - BUILDING 01
Scale 1:50


PLUMBING AND DRAINAGE KEY:		NOTE
	WASTE WATER LINE	ALL PLUMBING AND DRAINAGE IS TO COMPLY WITH AS/NZS 3500.2 AND ALL LOCAL COUNCIL BYLAWS.
	STORM WATER LINE	
ABBREVIATIONS:		ORG'S TO HAVE WATER TAP INSTALLED OVERHEAD.
CP	CESSPIT	ALL EXTERNAL TAPS TO BE FITTED WITH VACUUM BREAKERS (HCVB) TESTED IN ACCORDANCE WITH AS/NZS 2845 : 1 : 2010.
DP	DOWNPIPE	
FH	FIRE HYDRANT	PLUMBING PIPE MINIMUM FALLS IN ACCORDANCE WITH NZS 3500.2:
ORG	OVERFLOW RELIEF GULLY	
SHR	SHOWER	65ø 1:40
S	SINK	80ø 1:60
SS	SANITARY SEWER	100ø 1:60
SW	STORMWATER	150ø 1:100
TV	TERMINAL VENT	
WC	WATER CLOSET	
WHB	WASH HAND BASIN	REFER CIVIL ENGINEERS DESIGN DOCUMENTATION FOR ALL DRAINAGE INFORMATION BEYOND THE LINE OF THE BUILDINGS.
WM	WATERMAIN	HWC VALVES TO BE CONFIRMED WITH FINAL SELECTION OF HWC.

NOTE:
It is the responsibility of the contractor to verify all dimensions on site prior to commencing all work. The contractor is to ensure that all work complies with the New Zealand Building Code, all amendments thereof and all relevant New Zealand Standards. All proprietary items and materials shall be fixed and applied in strict accordance with manufacturers specifications. **TAYLORED** architecture & environments Ltd under no circumstances accepts responsibility for payment of any products or services specified.

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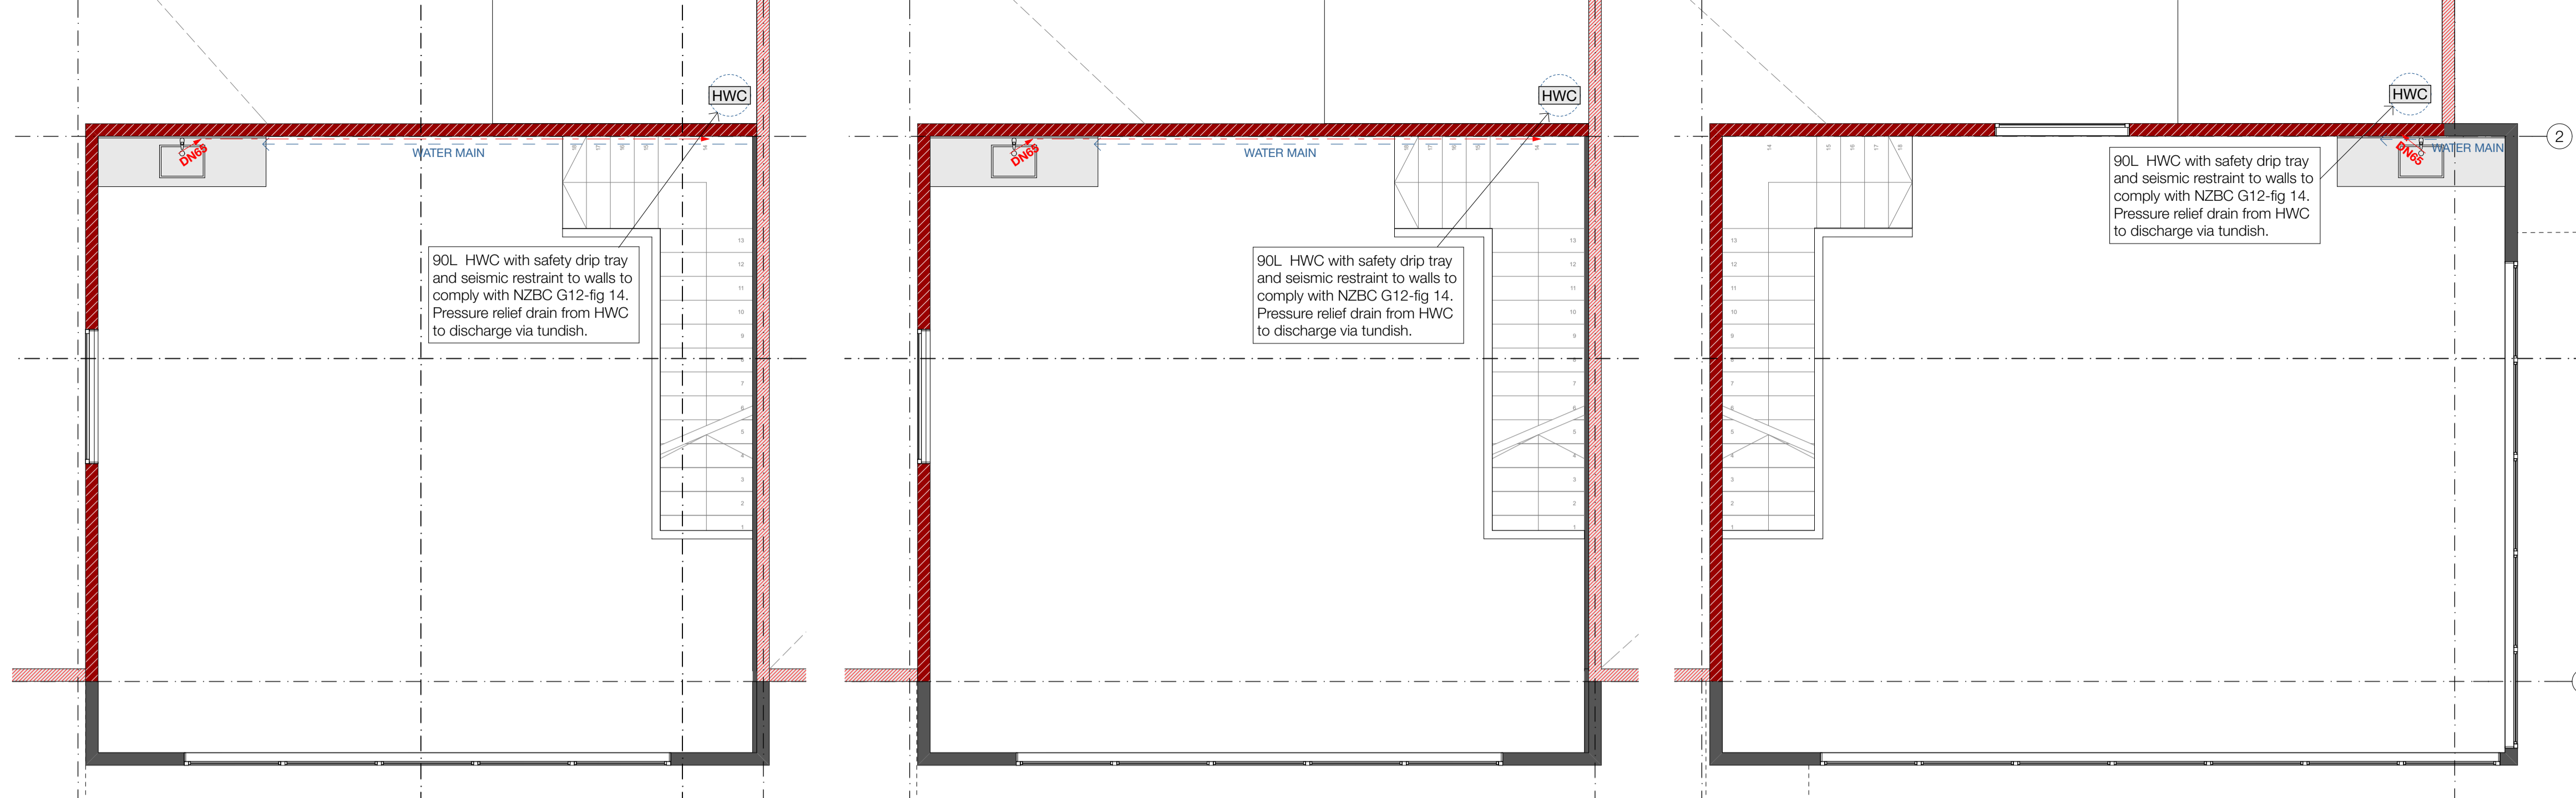


PROJECT: Te Rapa Stage 2
CLIENT: Fosters Construction
SITE: Te Rapa Industrial Park, Hamilton

DRAWING TITLE: PROPOSED PLUMBING PLANS - BUILDINGS 01-03

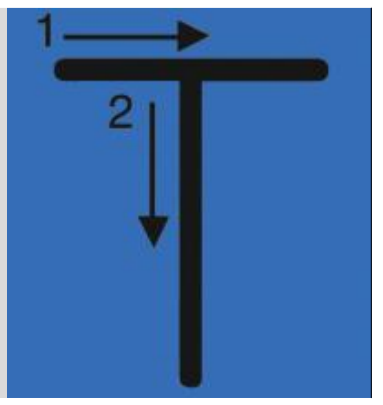PROJECT REF: T0424 TE RAPA S2	
DATE: 25/06/19	SCALE: 1:50 @ A1
SHEET: A13	REV: C01




FOR CONSTRUCTION ISSUE



FIRST FLOOR PLUMBING PLAN - BUILDING 04
Scale 1:50

FIRST FLOOR PLUMBING PLAN - BUILDING 05
Scale 1:50

FIRST FLOOR PLUMBING PLAN - BUILDING 06
Scale 1:50

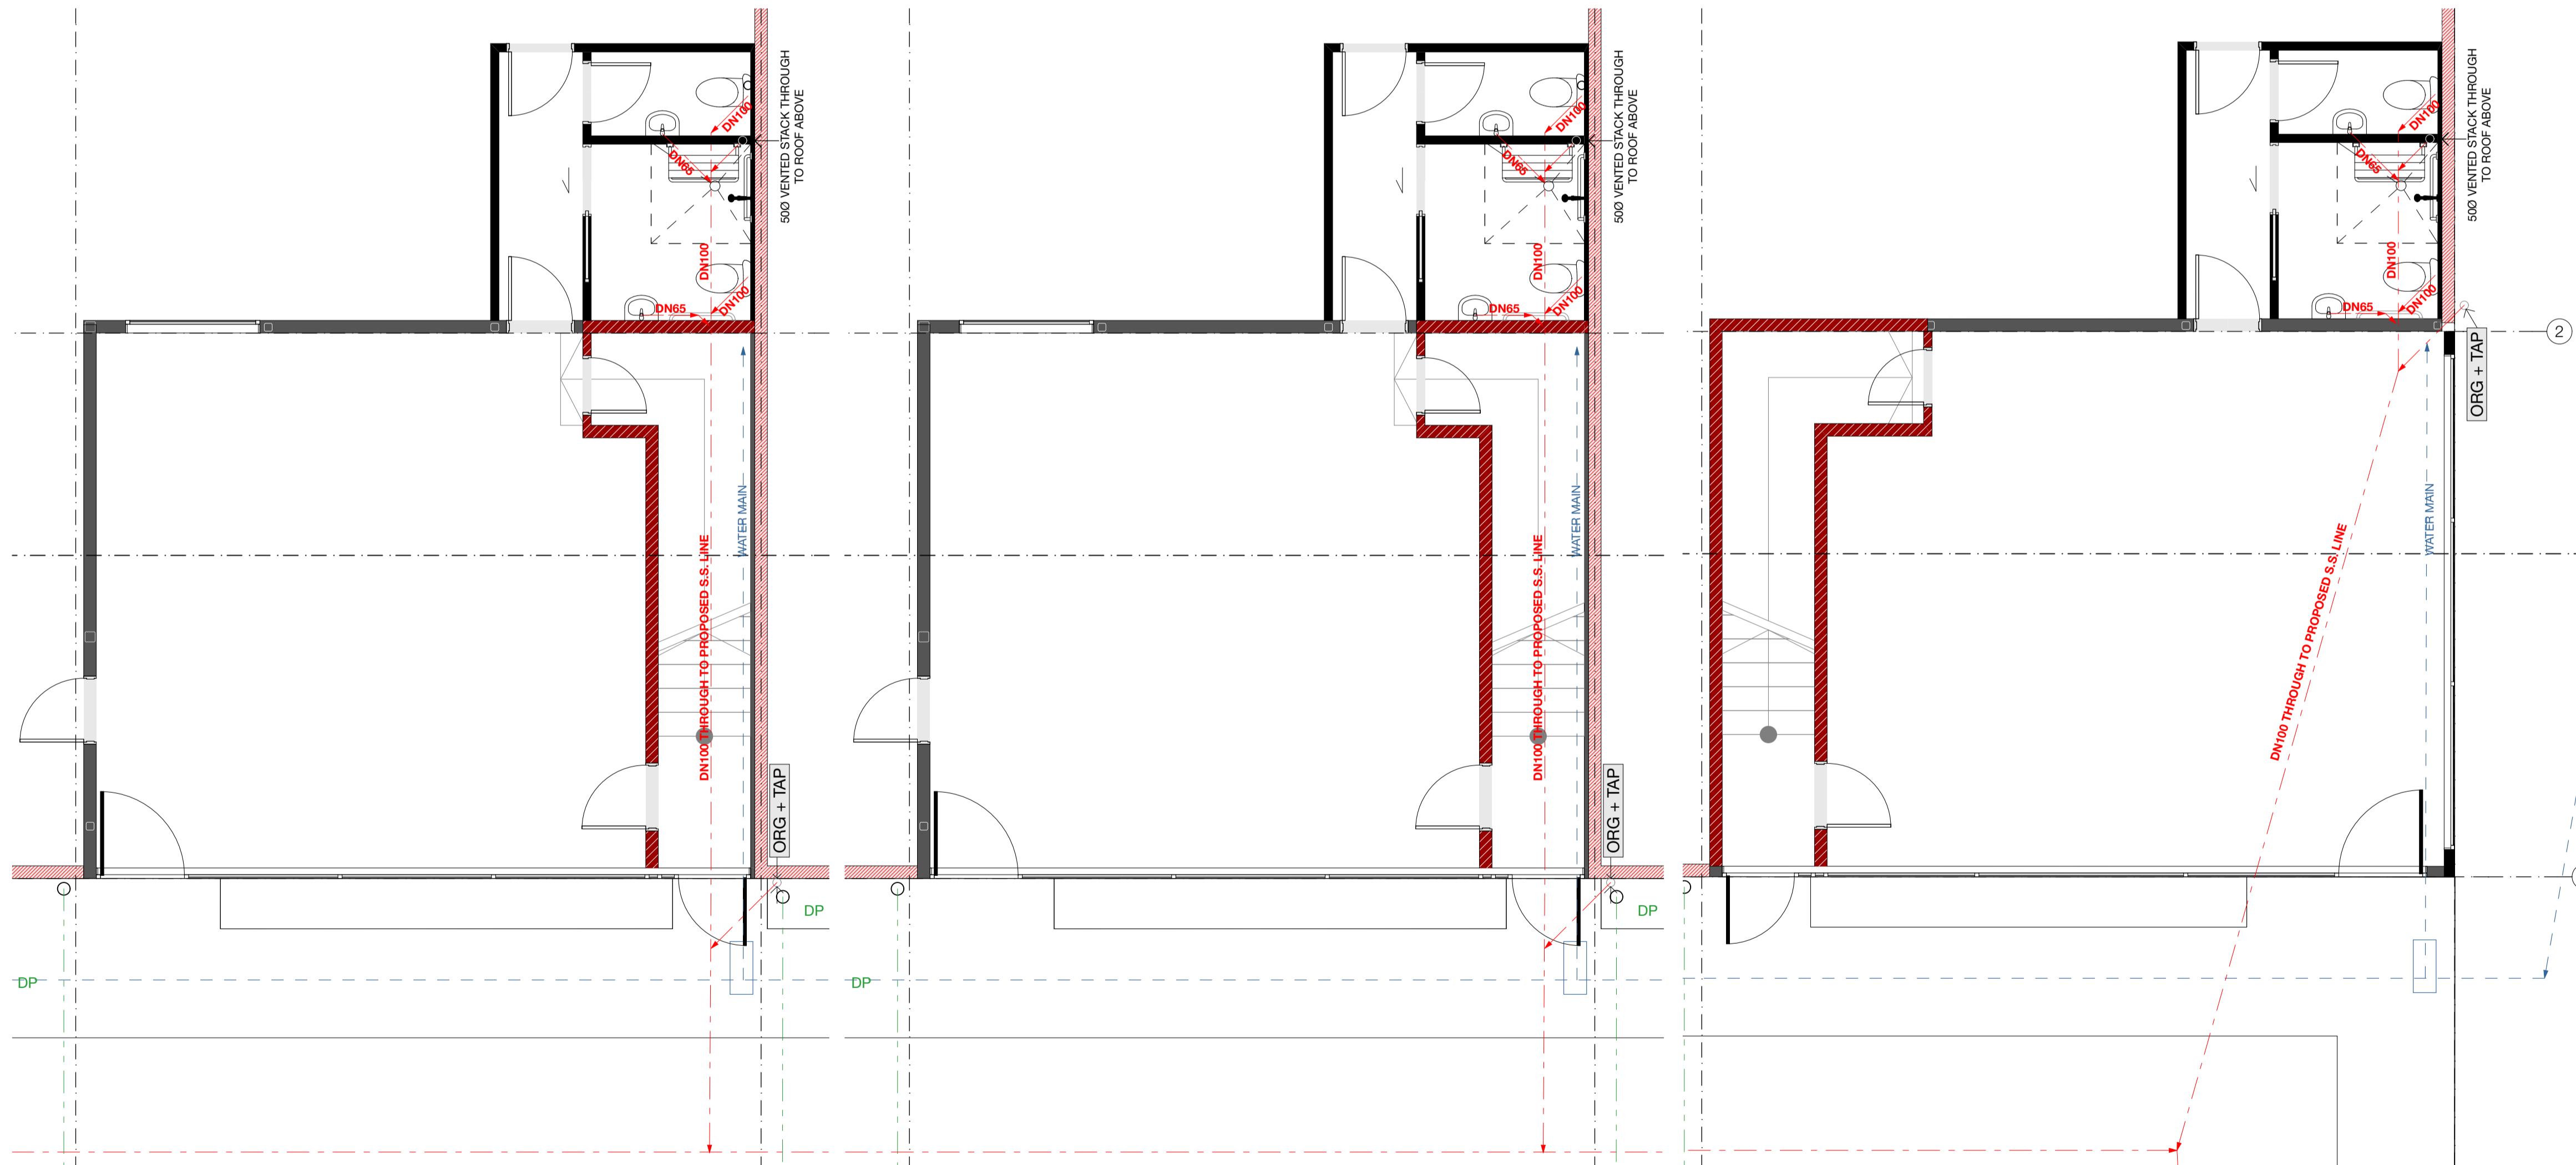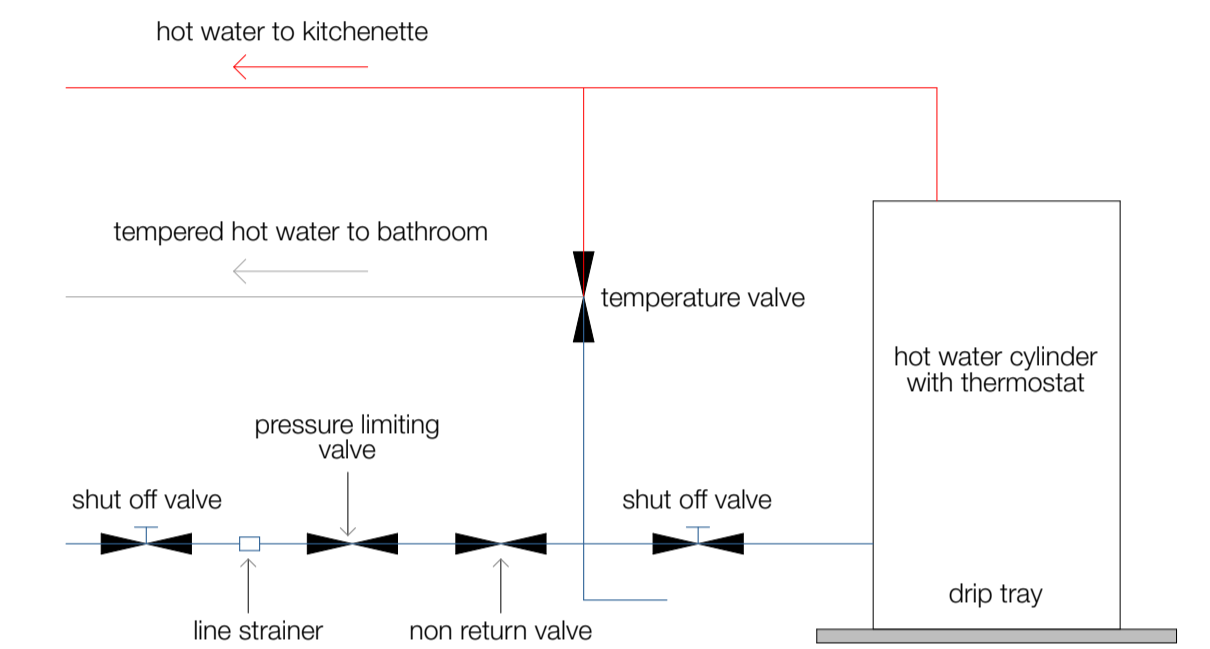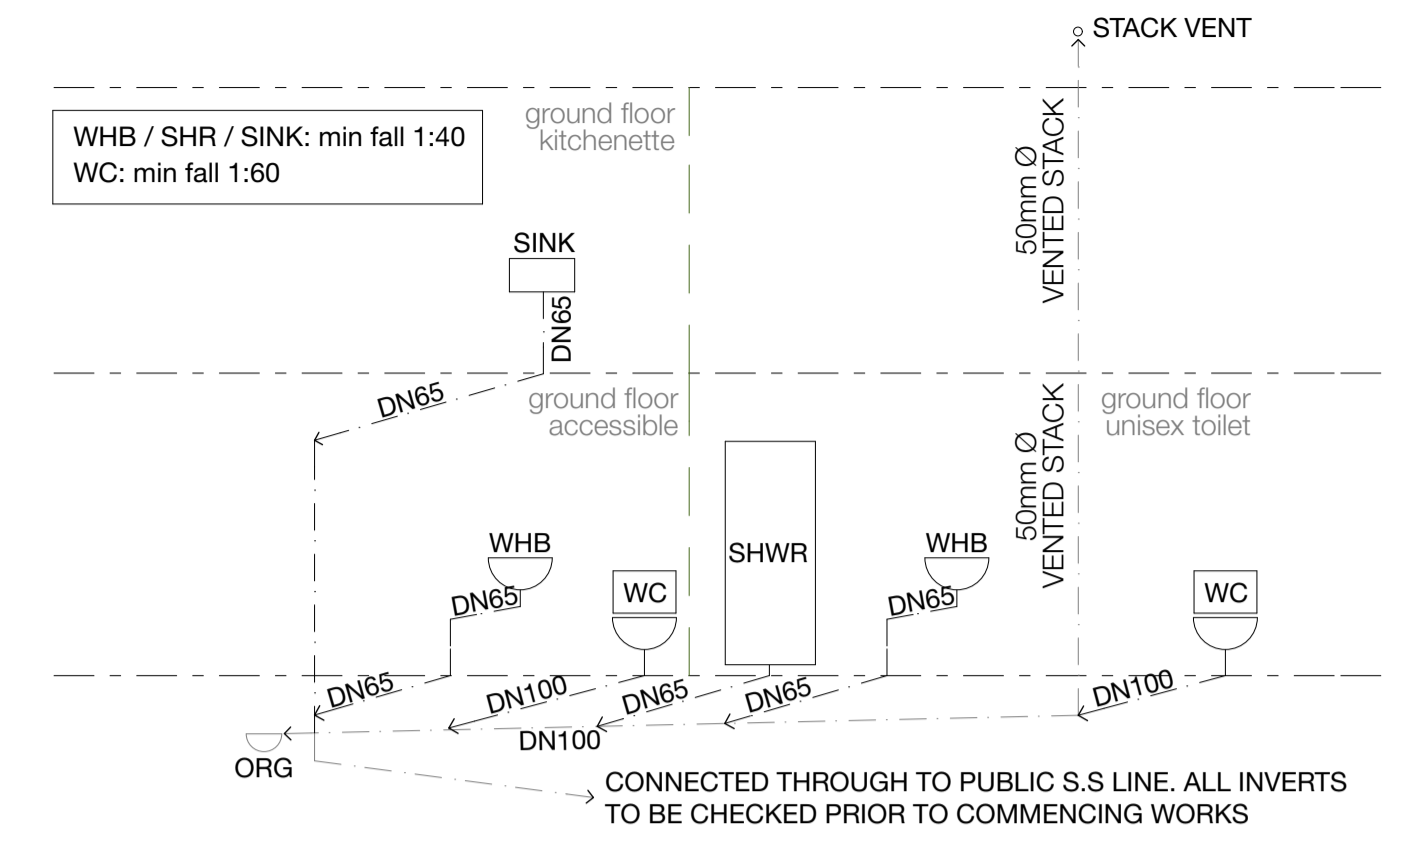

GROUND FLOOR PLUMBING PLAN - BUILDING 04
Scale 1:50

GROUND FLOOR PLUMBING PLAN - BUILDING 05
Scale 1:50

GROUND FLOOR PLUMBING PLAN - BUILDING 06
Scale 1:50

PLUMBING AND DRAINAGE KEY:		NOTE
	WASTE WATER LINE	ALL PLUMBING AND DRAINAGE IS TO COMPLY WITH AS/NZS 3500.2 AND ALL LOCAL COUNCIL BYLAWS.
	STORM WATER LINE	
ABBREVIATIONS:		ORG'S TO HAVE WATER TAP INSTALLED OVERHEAD.
CP	CESSPIT	ALL EXTERNAL TAPS TO BE FITTED WITH VACUUM BREAKERS (HCVB) TESTED IN ACCORDANCE WITH AS/NZS 2845 : 1 : 2010.
DP	DOWNPIPE	
FH	FIRE HYDRANT	PLUMBING PIPE MINIMUM FALLS IN ACCORDANCE WITH NZS 3500.2:
ORG	OVERFLOW RELIEF GULLY	
SHR	SHOWER	65ø 1:40
S	SINK	80ø 1:60
SS	SANITARY SEWER	100ø 1:60
SW	STORMWATER	150ø 1:100
TV	TERMINAL VENT	
WC	WATER CLOSET	
WHB	WASH HAND BASIN	REFER CIVIL ENGINEERS DESIGN DOCUMENTATION FOR ALL DRAINAGE INFORMATION BEYOND THE LINE OF THE BUILDINGS.
WM	WATERMAIN	HWC VALVES TO BE CONFIRMED WITH FINAL SELECTION OF HWC.

FOR CONSTRUCTION ISSUE


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PROJECT:
Te Rapa Stage 2


CLIENT: Fosters Construction
SITE: Te Rapa Industrial Park, Hamilton

DRAWING TITLE:
PROPOSED PLUMBING PLANS - BUILDINGS 04-06


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DATE: 25/06/19	SCALE: 1:50 @ A1
SHEET: A14	REV: C01

main notes:

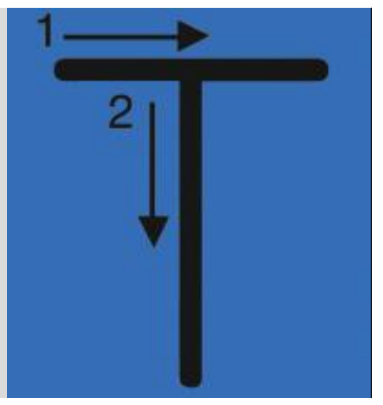
- RT01** Roof: 0.55 BMT Dimond BB900 profiled COLORSTEEL roofing with ENDURA finish over selected THERMOKRAFT COVERTEK 405 roofing underlay over safety mesh on roof structure. Office roof cavity insulated with AUTEX greenstuff insulation to achieve min. R3.0
- RT02** External gutter: 0.55 BMT box gutter with COLORSTEEL ENDURA finish fixed with hidden brackets to manufacturers specification.
- RT03** Parapet / apron roof flashings: 0.55 BMT machine folded flashings with COLORSTEEL ENDURA finish.
- RT04** Warehouse roof skylight: AMPELITE SL translucent sheet roofing to match profile of roof fixed over THERMOKRAFT AUSMESH safety mesh (galv. coated) on roof structure - to provide 15% daylighting to warehouse space.
- RT05** Canopy Roof & Soffit: 0.55 BMT Dimond BB900 profiled COLORSTEEL roofing with ENDURA finish over roof structure and to underside of soffit to provide bird proofing.
- ceiling:**
- CT01** Internal office ceiling: USG DONN DX suspended ceiling grid system with selected 1200x600 mineral fibre ceiling tiles SLT edged.
- CT02** Internal ceiling: 13mm GIB AQUALINE ceiling lining fixed to ex75x40mm SG8 timber battens @ 600 crs on 140x45mm joists @ 450 crs covered with 19mm marine ply. Max load 1.5kPa.
- CT03** Underside of stairs: 16mm GIB FYRLINE lining to underside of timber stair structure in accordance with GIB spec - GBFC60. FR 60/60/60 fire rated lining to extend through to fire rated wall structure
- walls:**
- WT01** 150mm FR 180/180/180 thick pre-cast concrete panel walls - refer structural and fire engineers documentation.
- WT02** Office fire walls: FR 60/60/60 ex150x50 SG8 wall framing with studs at 300 centres lined with 13mm GIB FYRLINE lining to both sides in accordance with GIB specification - GBT160. Walls to extend to underside of roof above.
- WT03** external walls: ex150x50 SG8 wall framing with studs at 600 centres lined with 13mm standard GIB board inside in accordance with GIB specification - GBUW 15. Walls to extend to underside of roof above.
- WT04** Internal walls: ex100x50 SG8 wall framing with studs at 600 centres lined with 10mm standard GIB board lining to interior. 10mm GIB AQUALINE to be used in wet areas. Where vinyl is continued up wall WPS water proofing membrane to be used in strict accordance with manufacturers specification. Face of office walls to warehouse finished with 9.5mm selected plywood to a height of 2.4m above finished floor level.
- WT05** Office cladding: METALCRAFT KAHU cladding with COLORSTEEL ENDURA finish fixed vertically over 20mm cavity battens over COVERTEK 403 building wrap on ex150x50 SG8 wall framing with studs at 600 centres. Insulated cavity with AUTEX insulation min R2.5
- WT06** Warehouse wall cladding: METALCRAFT KAHU cladding with COLORSTEEL ENDURA finish fixed horizontally over 20mm cavity battens over COVERTEK 403 building wrap on precast concrete panel walls.
- WT07** Joinery: VANTAGE external window 125 FLUSHGLAZE suite in seismic frames with powder coated finish and Magnum door.
- WT08** Joinery: VANTAGE 40 external window METRO suite with powder coated finish.
- WT09** Roller door: METALBLT motorised roller shutter door powder coated finish on windsocks all with metal chain and manual back-up.
- WT10** Horizontal sun screens: INSQL zenith Al sun screen with selected powdercoat finish. Refer manufacturers specifications for all fixings and structural information.
- WT11** Internal strapped walls: ex50x50 SG8 timber strapping at 600 centres lined with 10mm standard GIB board lining to interior. 10mm GIB AQUALINE to be used in wet areas. AUTEX batt insulation to provide min. R2.5
- WT12** Internal walls: ex150x50 SG8 wall framing with studs at 600 centres lined with 10mm standard GIB board lining to interior. 10mm GIB AQUALINE to be used in wet areas. Where vinyl is continued up wall WPS water proofing membrane to be used in strict accordance with manufacturers specification. Face of office walls to warehouse finished with 9.5mm selected plywood to a height of 2.4m above finished floor level.
- floors:**
- FT01** Warehouse floor: 150mm thick reinforced concrete slab foundation on DPM and sand blinding on minimum 150mm thick compacted hard fill - refer structural engineers documentation for all structural information.
- FT02** Office ground floor: 150mm thick reinforced concrete slab foundation on DPM and sand blinding on minimum 150mm thick compacted hard fill - refer structural engineer.
- FT03** Office first floor: FRR 60/60/60 150mm thick Comflor - refer structural engineer.
- FT04** Selected commercial grade vinyl flooring
- structural:**
- ST01** Structural framing - refer structural engineer documentation for all structural detail.
- note:**
- All materials, fittings, fixtures, and finishes to be established in strict accordance with manufactures specification.
- This architectural documentation is to be read in conjunction with all specialist documentation and reports. Refer to engineering documentation for all engineering requirements.
- fire design requirements:**
- All precast concrete panel walls to provide FR 180/180/180 (150 thick). Ground floor office to be fire rated and separate to the first floor fire cell - all fire rated FR 60/60/60. All supporting structure, stairs and underside of floors to be fire rated FR 60/60/60.
- FD** FD = fire door. Refer fire report for all fire design requirements.
- W03** Window joinery - Refer D & W schedule
- Refer finishes plans for floor, wall & ceiling finishes

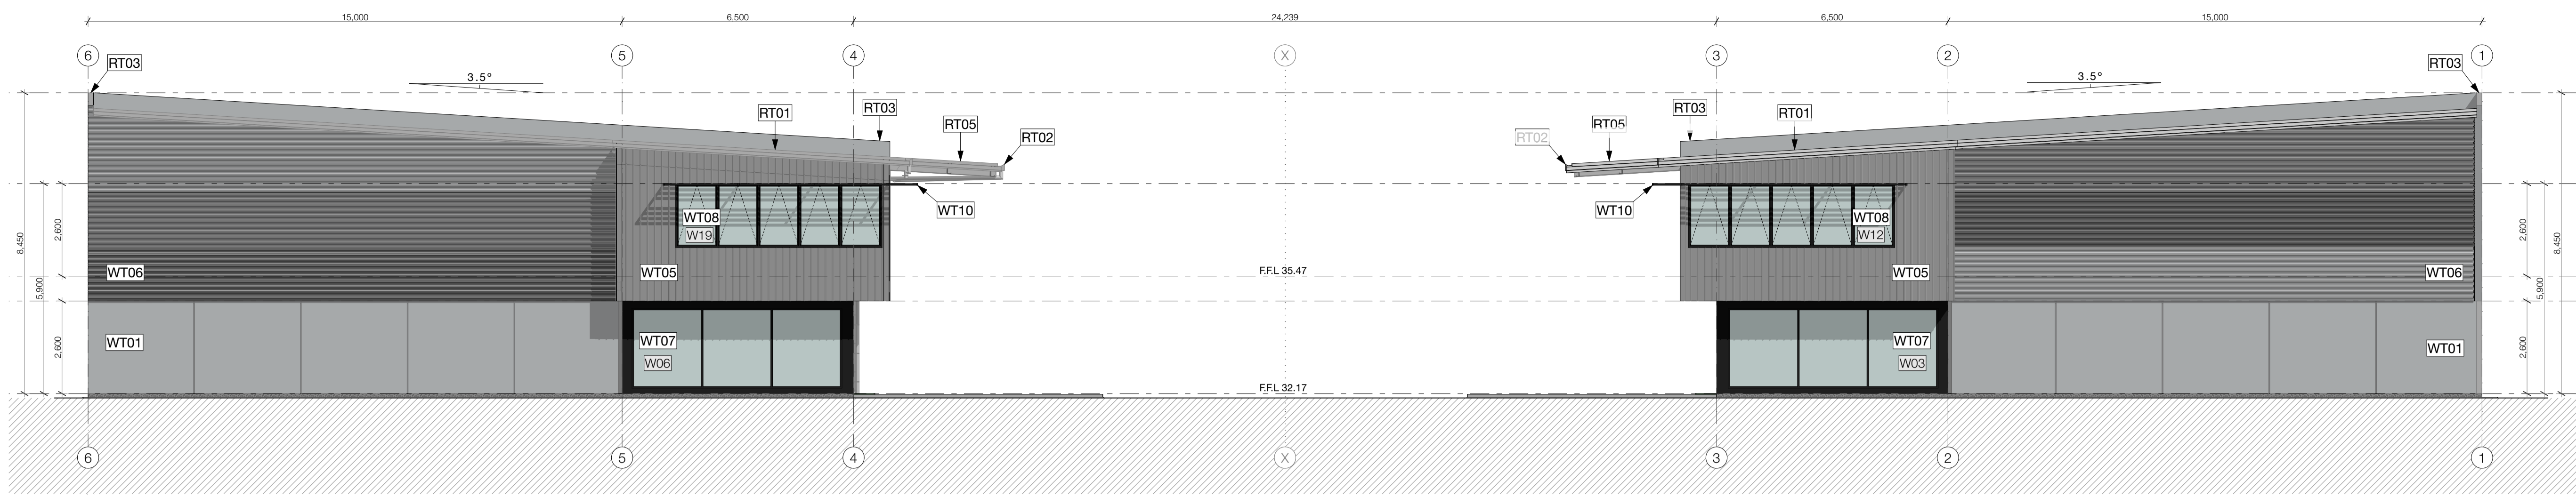

E01
A15
ELEVATION 01
1:100

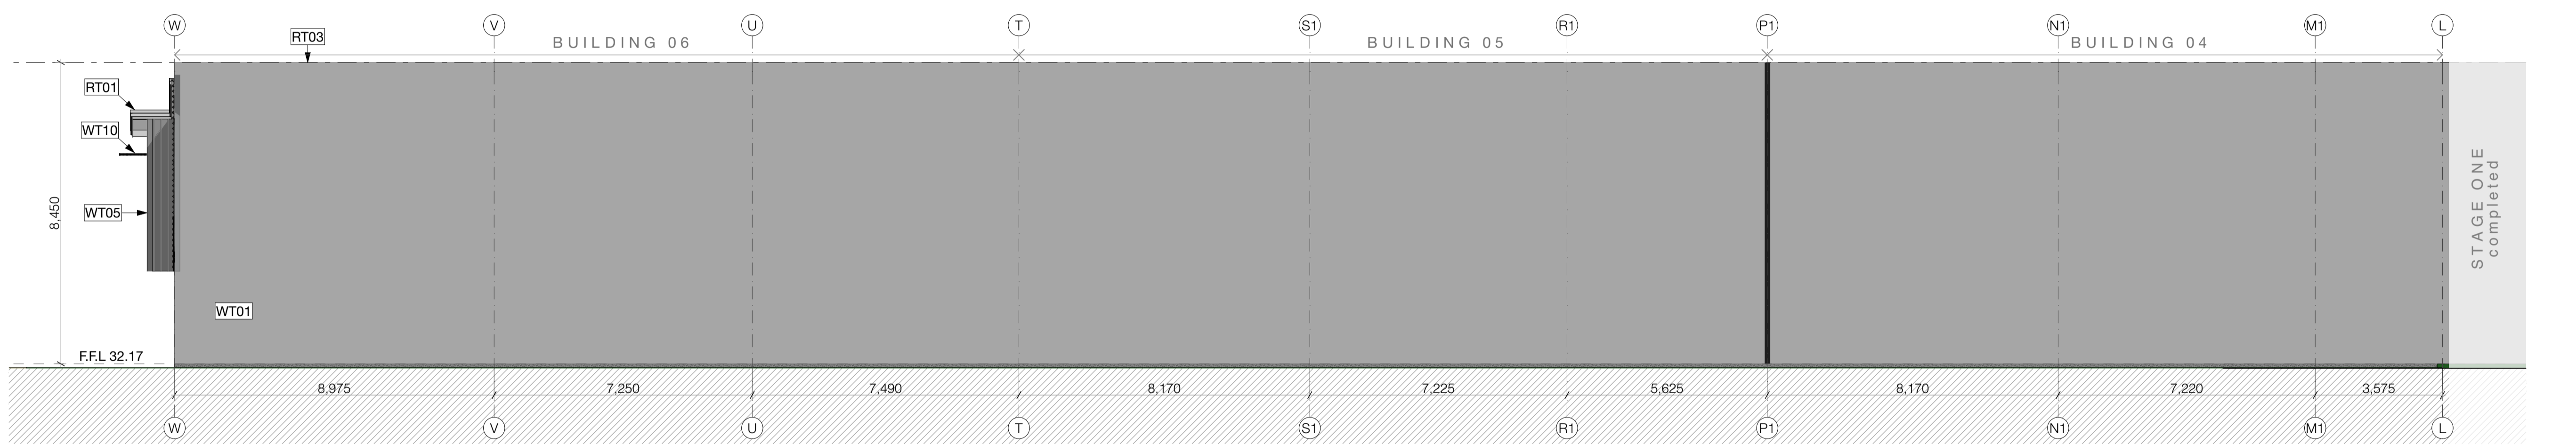

E02
A15
ELEVATION 02
1:100

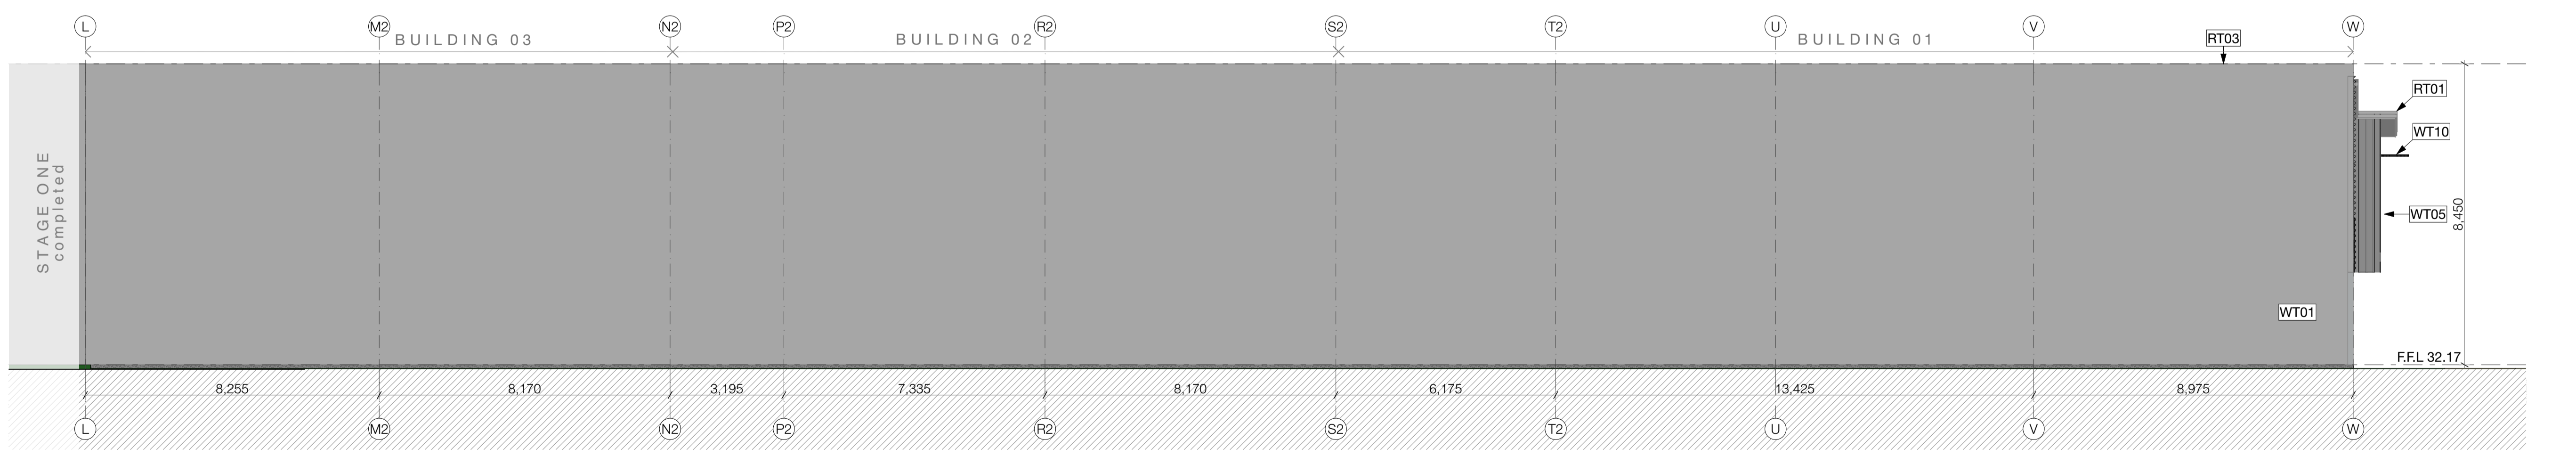

E03
A15
ELEVATION 03
1:100

FOR CONSTRUCTION ISSUE

NOTE:
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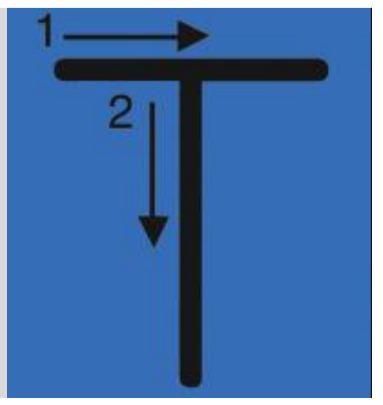
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ISSUE:
C01

DATE:
25/06/19


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PROJECT:
Te Rapa Stage 2

CLIENT: Fosters Construction
SITE: Te Rapa Industrial Park, Hamilton



DRAWING TITLE:
PROPOSED ELEVATIONS 1

PROJECT REF: T0424 TE RAPA S2	
DATE: 25/06/19	SCALE: 1:100, 1:50 @ A1
SHEET: A15	REV: C01

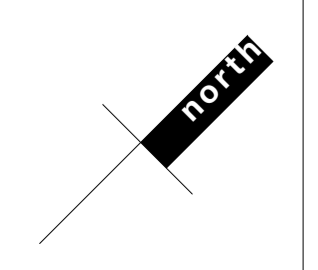main notes:
roof:

- RT01 Roof: 0.55 BMT Dimond BB900 profiled COLORSTEEL roofing with ENDURA finish over selected THERMAKRAFT COVERTEK 405 roofing underlay over safety mesh on roof structure. Office roof cavity insulated with AUTEX greenstuf insulation to achieve min. R3.0
- RT02 External gutter: 0.55 BMT box gutter with COLORSTEEL ENDURA finish fixed with hidden brackets to manufacturers specification.
- RT03 Parapet / apron roof flashings: 0.55 BMT machine folded flashings with COLORSTEEL ENDURA finish.
- RT04 Warehouse roof skylight: AMPELITE SL translucent sheet roofing to match profile of roof fixed over THERMAKRAFT AUSMESH safety mesh (galv. coated) on roof structure - to provide 15% daylighting to warehouse space.
- RT05 Canopy Roof & Soffit: 0.55 BMT Dimond BB900 profiled COLORSTEEL roofing with ENDURA finish over roof structure and to underside of soffit to provide bird proofing.

- ceiling:**
- CT01 Internal office ceiling: USG DONN DX suspended ceiling grid system with selected 1200x600 mineral fibre ceiling tiles SLT edged.
 - CT02 Internal ceiling: 13mm GIB AQUALINE ceiling lining fixed to ex75x40mm SG8 timber battens @ 600 crs on 140x45mm joists @ 450 crs covered with 19mm marine ply. Max load 1.5kPa.
 - CT03 Underside of stairs: 16mm GIB FIBRLINE lining to underside of timber stair structure in accordance with GIB spec - GBFC60. FR 60/60/60 fire rated lining to extend through to fire rated wall structure.

- walls:**
- WT01 150mm FR 180/180/180 thick pre-cast concrete panel walls - refer structural and fire engineers documentation.
 - WT02 Office fire walls: FR 60/60/60 ex150x50 SG8 wall framing with studs at 600 centres lined with 13mm GIB FIBRLINE lining to both sides in accordance with GIB specification GBT1.60. Walls to extend to underside of roof above.
 - WT03 external walls: ex150x50 SG8 wall framing with studs at 600 centres lined with 13mm standard GIB board inside in accordance with GIB specification - GBUW 15. Walls to extend to underside of roof above.
 - WT04 Internal walls: ex100x50 SG8 wall framing with studs at 600 centres lined with 10mm standard GIB board lining to interior. 10mm GIB AQUALINE to be used in wet areas. Where vinyl is continued up wall WPS water proofing membrane to be used in strict accordance with manufacturers specification. Face of office walls to warehouse finished with 9.5mm selected plywood to a height of 2.4m above finished floor level.
 - WT05 Office cladding: METALCRAFT KAHU cladding with COLORSTEEL ENDURA finish fixed vertically over 20mm cavity battens over COVERTEK 403 building wrap on ex150x50 SG8 wall framing with studs at 600 centres. Insulated cavity with AUTEX insulation min R2.5
 - WT06 Warehouse wall cladding: METALCRAFT KAHU cladding with COLORSTEEL ENDURA finish fixed horizontally over 20mm cavity battens over COVERTEK 403 building wrap on precast concrete panel walls.

- WT07 Joinery: VANTAGE external window 125 FLUSHGLAZE suite in seismic frames with powder coated finish and Magnum door.
- WT08 Joinery: VANTAGE 40 external window METRO suite with powder coated finish.
- WT09 Roller door: METALBILT motorised roller shutter door powder coated finish on windsocks all with metal chain and manual back-up.
- WT10 Horizontal sun screens: INSOL zenith AI sun screen with selected powdercoat finish. Refer manufacturers specifications for all fixings and structural information.
- WT11 Internal strapped walls: ex50x50 SG8 timber strapping at 600 centres lined with 10mm standard GIB board lining to interior. 10mm GIB AQUALINE to be used in wet areas. AUTEX batt insulation to provide min. R2.5
- WT12 Internal walls: ex150x50 SG8 wall framing with studs at 600 centres lined with 10mm standard GIB board lining to interior. 10mm GIB AQUALINE to be used in wet areas. Where vinyl is continued up wall WPS water proofing membrane to be used in strict accordance with manufacturers specification. Face of office walls to warehouse finished with 9.5mm selected plywood to a height of 2.4m above finished floor level.

- floors:**
- FT01 Warehouse floor: 150mm thick reinforced concrete slab foundation on DPM and sand blinding on minimum 150mm thick compacted hard fill - refer structural engineers documentation for all structural information.
 - FT02 Office ground floor: 150mm thick reinforced concrete slab foundation on DPM and sand blinding on minimum 150mm thick compacted hard fill - refer structural engineer.
 - FT03 Office first floor: FRR 60/60/60 150mm thick Comflor - refer structural engineer.
 - FT04 Selected commercial grade vinyl flooring

- structural:**
- ST01 Structural framing - refer structural engineer documentation for all structural detail.


note:
All materials, fittings, fixtures, and finishes to be established in strict accordance with manufactures specification.
This architectural documentation is to be read in conjunction with all specialist documentation and reports. Refer to engineering documentation for all engineering requirements.

fire design requirements:
All precast concrete panel walls to provide FR 180/180/180 (150 thick). Ground floor office to be fire rated and separate to the first floor fire cell - all fire rated FR 60/60/60. All supporting structure, stairs and underside of floors to be fire rated FR 60/60/60.

- FD FD = fire door. Refer fire report for all fire design requirements.
- W03 Window joinery - Refer D & W schedule
Refer finishes plans for floor, wall & ceiling finishes



E04
A16 ELEVATION 04
1:100

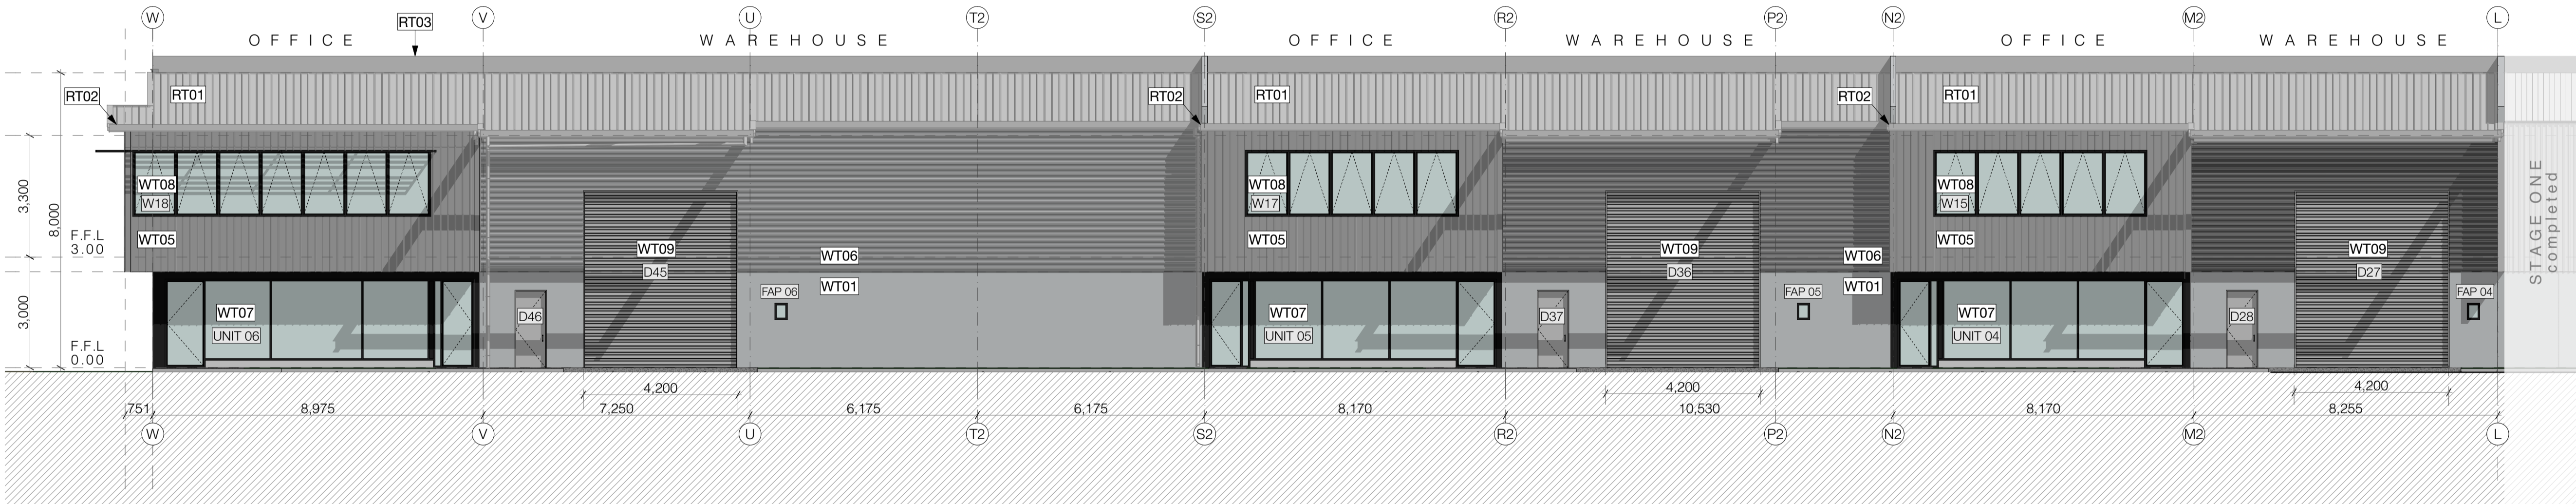

E05
A16 ELEVATION 05
1:100

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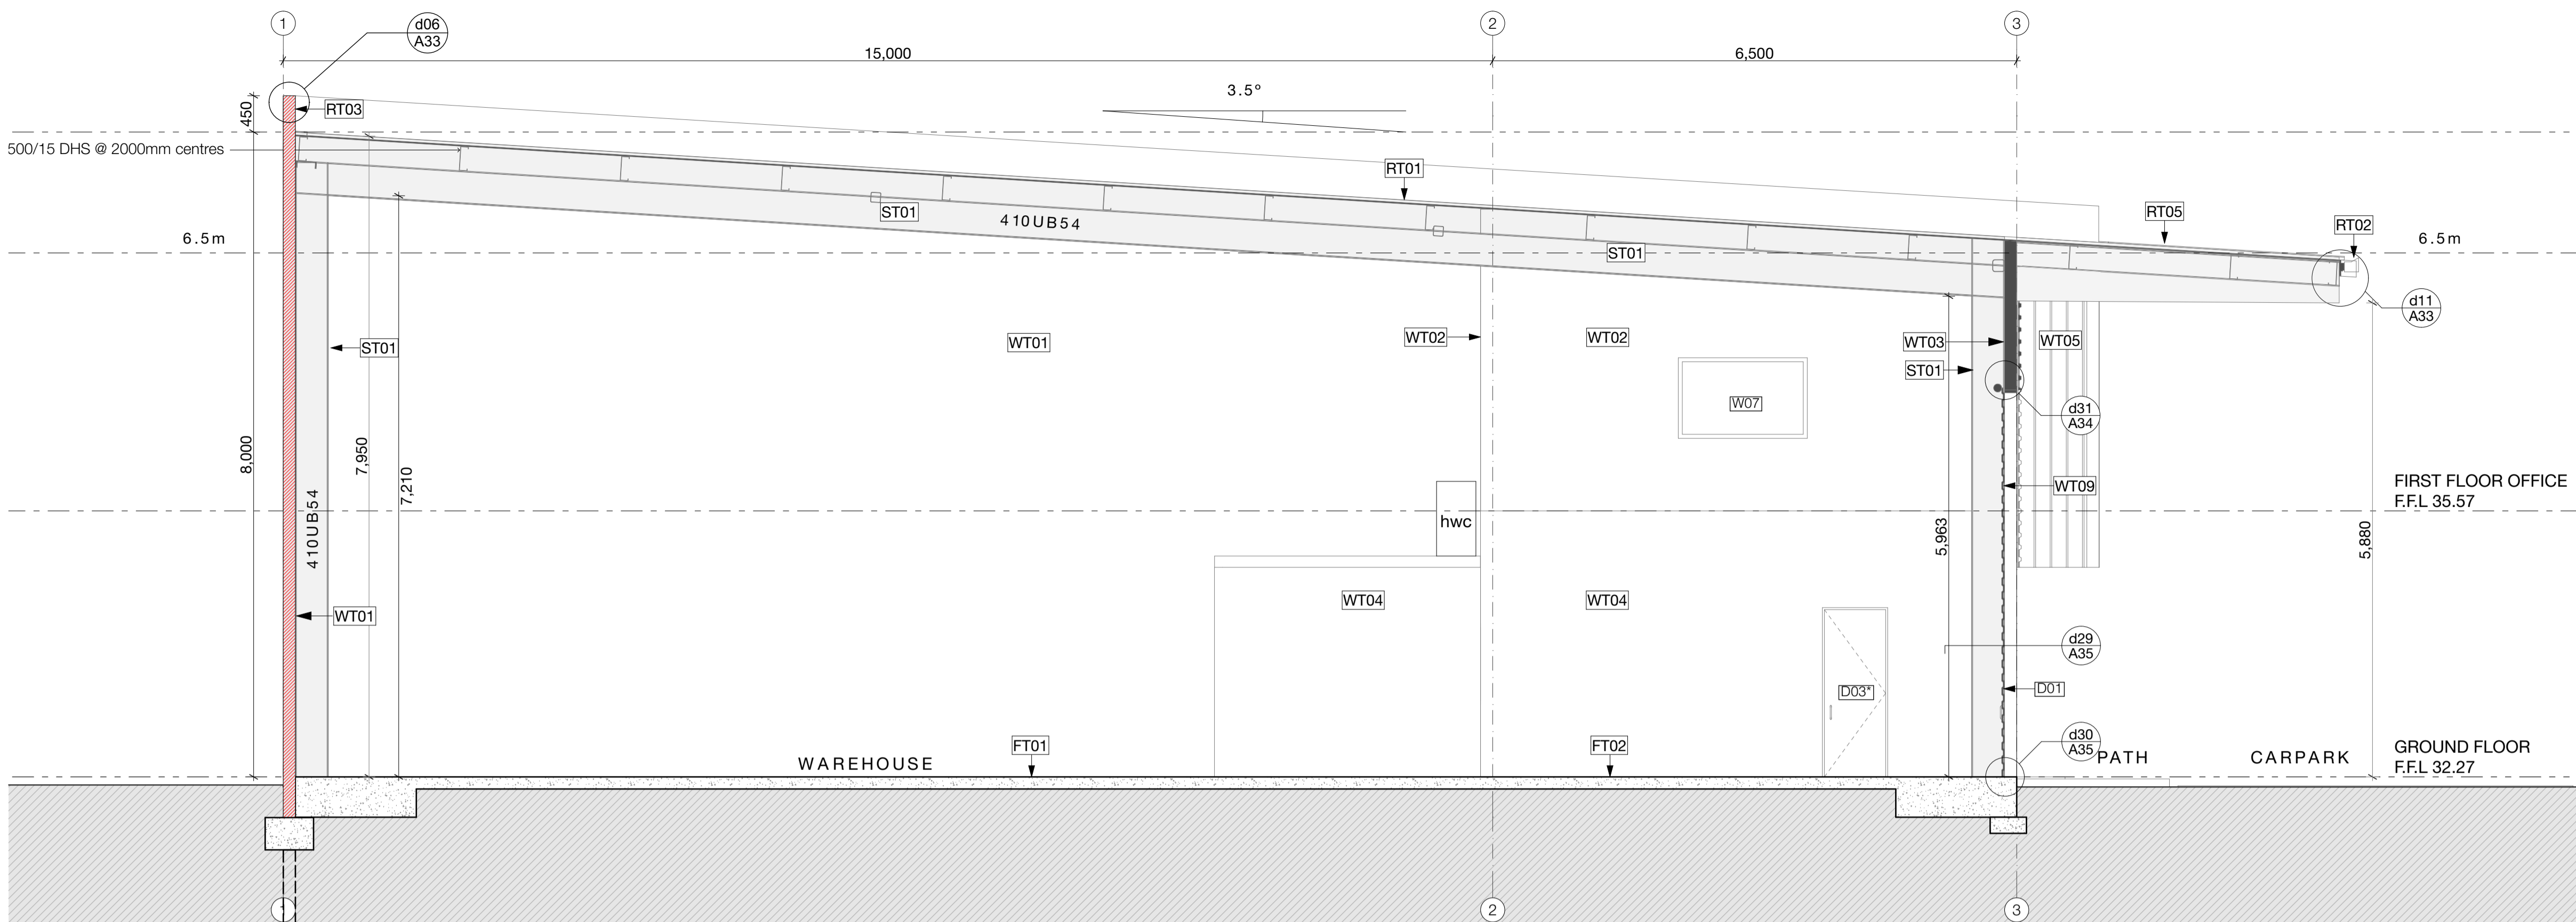
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PROJECT: Te Rapa Stage 2
CLIENT: Fosters Construction
SITE: Te Rapa Industrial Park, Hamilton


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DRAWING TITLE: PROPOSED ELEVATIONS 2

PROJECT REF: T0424 TE RAPA S2	
DATE: 25/06/19	SCALE: 1:100, 1:50 @ A1
SHEET: A16	REV: C01



SECTION 01
1:50

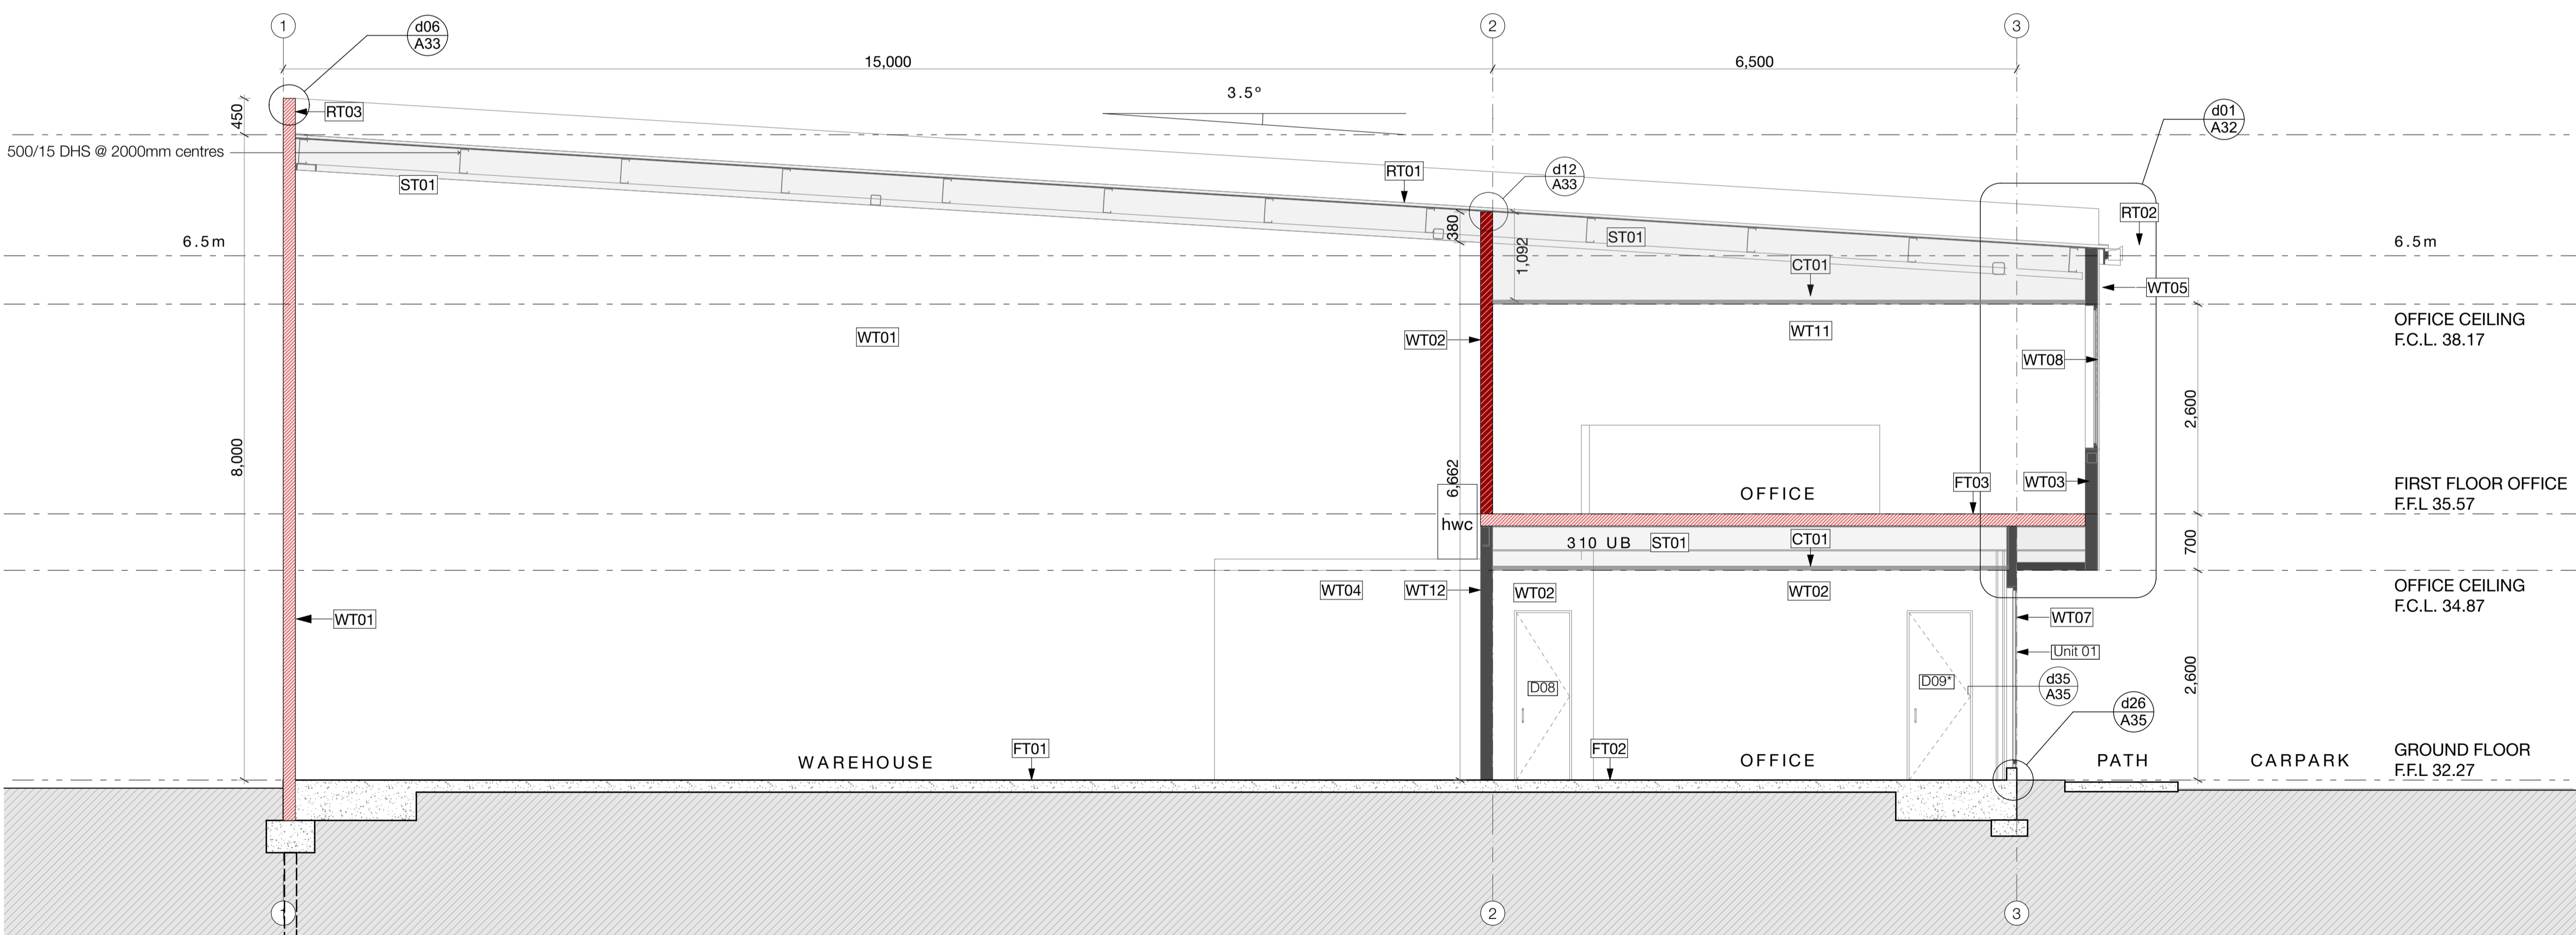

SECTION 02
Scale 1:50

main notes:

- RT01** Roof: 0.55 BMT Dimond BB900 profiled COLORSTEEL roofing with ENDURA finish over selected THERMOKRAFT COVERTEK 405 roofing underlay over safety mesh on roof structure. Office roof cavity insulated with AUTEX greenstuff insulation to achieve min. R3.0
- RT02** External gutter: 0.55 BMT box gutter with COLORSTEEL ENDURA finish fixed with hidden brackets to manufacturers specification.
- RT03** Parapet / apron roof flashings: 0.55 BMT machine folded flashings with COLORSTEEL ENDURA finish.
- RT04** Warehouse roof skylight: AMPELITE SL translucent sheet roofing to match profile of roof fixed over THERMOKRAFT AUSMESH safety mesh (galv. coated) on roof structure - to provide 15% daylighting to warehouse space.
- RT05** Canopy Roof & Soffit: 0.55 BMT Dimond BB900 profiled COLORSTEEL roofing with ENDURA finish over roof structure and to underside of soffit to provide bird proofing.
- ceiling:**
- CT01** Internal office ceiling: USG DONN DX suspended ceiling grid system with selected 1200x600 mineral fibre ceiling tiles SLT edged.
- CT02** Internal ceiling: 13mm GIB AQUALINE ceiling lining fixed to ex75x40mm SG8 timber battens @ 600 crs on 140x45mm joists @ 450 crs covered with 19mm marine ply. Max load 1.5kPa.
- CT03** Underside of stairs: 16mm GIB FYRLINE lining to underside of timber stair structure in accordance with GIB spec - GBFC60. FR 60/60/60 fire rated lining to extend through to fire rated wall structure.
- walls:**
- WT01** 150mm FR 180/180/180 thick pre-cast concrete panel walls - refer structural and fire engineers documentation.
- WT02** Office fire walls: FR 60/60/60 ex150x50 SG8 wall framing with studs at 300 centres lined with 13mm GIB FYRLINE lining to both sides in accordance with GIB specification GBTL60. Walls to extend to underside of roof above.
- WT03** external walls: ex150x50 SG8 wall framing with studs at 600 centres lined with 13mm standard GIB board inside in accordance with GIB specification - GBUW 15. Walls to extend to underside of roof above.
- WT04** Internal walls: ex100x50 SG8 wall framing with studs at 600 centres lined with 10mm standard GIB board lining to interior. 10mm GIB AQUALINE to be used in wet areas. Where vinyl is continued up wall WPS water proofing membrane to be used in strict accordance with manufacturers specification. Face of office walls to warehouse finished with 9.5mm selected plywood to a height of 2.4m above finished floor level.
- WT05** Office cladding: METALCRAFT KAHU cladding with COLORSTEEL ENDURA finish fixed vertically over 20mm cavity battens over COVERTEK 403 building wrap on ex150x50 SG8 wall framing with studs at 600 centres. Insulated cavity with AUTEX insulation min R2.5
- WT06** Warehouse wall cladding: METALCRAFT KAHU cladding with COLORSTEEL ENDURA finish fixed horizontally over 20mm cavity battens over COVERTEK 403 building wrap on precast concrete panel walls.
- WT07** Joinery: VANTAGE external window 125 FLUSHGLAZE suite in seismic frames with powder coated finish and Magnum door.
- WT08** Joinery: VANTAGE 40 external window METRO suite with powder coated finish.
- WT09** Roller door: METALBILT motorised roller shutter door powder coated finish on windssocks all with metal chain and manual back-up.
- WT10** Horizontal sun screens: INSCOL zenith Al sun screen with selected powdercoat finish. Refer manufacturers specifications for all fixings and structural information.
- WT11** Internal strapped walls: ex50x50 SG8 timber strapping at 600 centres with 10mm standard GIB board lining to interior. 10mm GIB AQUALINE to be used in wet areas. AUTEX batt insulation to provide min. R2.5
- WT12** Internal walls: ex150x50 SG8 wall framing with studs at 600 centres lined with 10mm standard GIB board lining to interior. 10mm GIB AQUALINE to be used in wet areas. Where vinyl is continued up wall WPS water proofing membrane to be used in strict accordance with manufacturers specification. Face of office walls to warehouse finished with 9.5mm selected plywood to a height of 2.4m above finished floor level.
- floors:**
- FT01** Warehouse floor: 150mm thick reinforced concrete slab foundation on DPM and sand blinding on minimum 150mm thick compacted hard fill - refer structural engineers documentation for all structural information.
- FT02** Office ground floor: 150mm thick reinforced concrete slab foundation on DPM and sand blinding on minimum 150mm thick compacted hard fill - refer structural engineer.
- FT03** Office first floor: FRR 60/60/60 150mm thick Comflor - refer structural engineer.
- FT04** Selected commercial grade vinyl flooring
- structural:**
- ST01** Structural framing - refer structural engineer documentation for all structural detail.
- note:**
- All materials, fittings, fixtures, and finishes to be established in strict accordance with manufactures specification.
- This architectural documentation is to be read in conjunction with all specialist documentation and reports. Refer to engineering documentation for all engineering requirements.
- fire design requirements:**
- All precast concrete panel walls to provide FR 180/180/180 (150 thick). Ground floor office to be fire rated and separate to the first floor fire cell - all fire rated FR 60/60/60. All supporting structure, stairs and underside of floors to be fire rated FR 60/60/60.
- FD** FD = fire door. Refer fire report for all fire design requirements.
- W03** Window joinery - Refer D & W schedule
- Refer finishes plans for floor, wall & ceiling finishes


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ISSUE:	DATE:
C01	25/06/19

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PROJECT:
Te Rapa Stage 2

CLIENT: Fosters Construction
SITE: Te Rapa Industrial Park, Hamilton


FOR CONSTRUCTION ISSUE

DRAWING TITLE:
PROPOSED CROSS SECTIONS

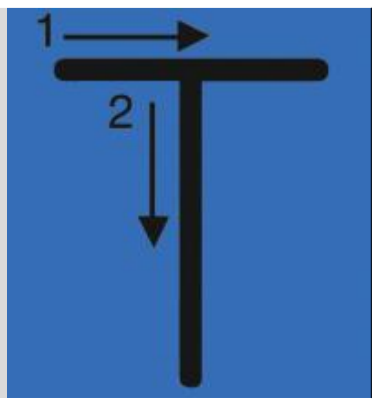
PROJECT REF: T0424 TE RAPA S2	
DATE: 25/06/19	SCALE: 1:50 @ A1
SHEET: A17	REV: C01

main notes:

- roof:**
- RT01 Roof: 0.55 BMT Dimond BB900 profiled COLORSTEEL roofing with ENDURA finish over selected THERMAKRAFT COVERTEK 405 roofing underlay over safety mesh on roof structure. Office roof cavity insulated with AUTEX greenstuf insulation to achieve min. R3.0
 - RT02 External gutter: 0.55 BMT box gutter with COLORSTEEL ENDURA finish fixed with hidden brackets to manufacturers specification.
 - RT03 Parapet / apron roof flashings: 0.55 BMT machine folded flashings with COLORSTEEL ENDURA finish.
 - RT04 Warehouse roof skylight: AMPELITE SL translucent sheet roofing to match profile of roof fixed over THERMAKRAFT AUSMESH safety mesh (galv. coated) on roof structure - to provide 15% daylighting to warehouse space.
 - RT05 Canopy Roof & Soffit: 0.55 BMT Dimond BB900 profiled COLORSTEEL roofing with ENDURA finish over roof structure and to underside of soffit to provide bird proofing.
- ceiling:**
- CT01 Internal office ceiling: USG DONN DX suspended ceiling grid system with selected 1200x600 mineral fibre ceiling tiles SLT edged.
 - CT02 Internal ceiling: 13mm GIB AQUALINE ceiling lining fixed to ex75x40mm SG8 timber battens @ 600 crs on 140x45mm joists @ 450 crs covered with 19mm marine ply. Max load 1.5kPa.
 - CT03 Underside of stairs: 16mm GIB FYRLINE lining to underside of timber stair structure in accordance with GIB spec - GBFC60. FR 60/60/60 fire rated lining to extend through to fire rated wall structure
- walls:**
- WT01 150mm FR 180/180/180 thick pre-cast concrete panel walls - refer structural and fire engineers documentation.
 - WT02 Office fire walls: FR 60/60/60 ex150x50 SG8 wall framing with studs at 300 centres lined with 13mm GIB FYRLINE lining to both sides in accordance with GIB specification - GBTL60. Walls to extend to underside of roof above.
 - WT03 external walls: ex150x50 SG8 wall framing with studs at 600 centres lined with 13mm standard GIB board inside in accordance with GIB specification - GBUW 15. Walls to extend to underside of roof above.
 - WT04 Internal walls: ex100x50 SG8 wall framing with studs at 600 centres lined with 10mm standard GIB board lining to interior. 10mm GIB AQUALINE to be used in wet areas. Where vinyl is continued up wall WPS water proofing membrane to be used in strict accordance with manufacturers specification. Face of office walls to warehouse finished with 9.5mm selected plywood to a height of 2.4m above finished floor level.
 - WT05 Office cladding: METALCRAFT KAHU cladding with COLORSTEEL ENDURA finish fixed vertically over 20mm cavity battens over COVERTEK 403 building wrap on ex150x50 SG8 wall framing with studs at 600 centres. Insulated cavity with AUTEX insulation min R2.5
 - WT06 Warehouse wall cladding: METALCRAFT KAHU cladding with COLORSTEEL ENDURA finish fixed horizontally over 20mm cavity battens over COVERTEK 403 building wrap on precast concrete panel walls.
 - WT07 Joinery: VANTAGE external window 125 FLUSHGLAZE suite in seismic frames with powder coated finish and Magnum door.
 - WT08 Joinery: VANTAGE 40 external window METRO suite with powder coated finish.
 - WT09 Roller door: METALBILT motorised roller shutter door powder coated finish on windssocks all with metal chain and manual back-up.
 - WT10 Horizontal sun screens: INSOL zenith AI sun screen with selected powdercoat finish. Refer manufacturers specifications for all fixings and structural information.
 - WT11 Internal strapped walls: ex50x50 SG8 timber strapping at 600 centres with 10mm standard GIB board lining to interior. 10mm GIB AQUALINE to be used in wet areas. AUTEX batt insulation to provide min. R2.5
 - WT12 Internal walls: ex150x50 SG8 wall framing with studs at 600 centres lined with 10mm standard GIB board lining to interior. 10mm GIB AQUALINE to be used in wet areas. Where vinyl is continued up wall WPS water proofing membrane to be used in strict accordance with manufacturers specification. Face of office walls to warehouse finished with 9.5mm selected plywood to a height of 2.4m above finished floor level.
- floors:**
- FT01 Warehouse floor: 150mm thick reinforced concrete slab foundation on DPM and sand blinding on minimum 150mm thick compacted hard fill - refer structural engineers documentation for all structural information.
 - FT02 Office ground floor: 150mm thick reinforced concrete slab foundation on DPM and sand blinding on minimum 150mm thick compacted hard fill - refer structural engineer.
 - FT03 Office first floor: FRR 60/60/60 150mm thick Comfor - refer structural engineer.
 - FT04 Selected commercial grade vinyl flooring
- structural:**
- ST01 Structural framing - refer structural engineer documentation for all structural detail.
- note:**
- All materials, fittings, fixtures, and finishes to be established in strict accordance with manufactures specification.
- This architectural documentation is to be read in conjunction with all specialist documentation and reports. Refer to engineering documentation for all engineering requirements.
- fire design requirements:**
- All precast concrete panel walls to provide FR 180/180/180 (150 thick). Ground floor office to be fire rated and separate to the first floor fire cell - all fire rated FR 60/60/60. All supporting structure, stairs and underside of floors to be fire rated FR 60/60/60.
- FD = fire door. Refer fire report for all fire design requirements.
- W03 Window joinery - Refer D & W schedule
- Refer finishes plans for floor, wall & ceiling finishes

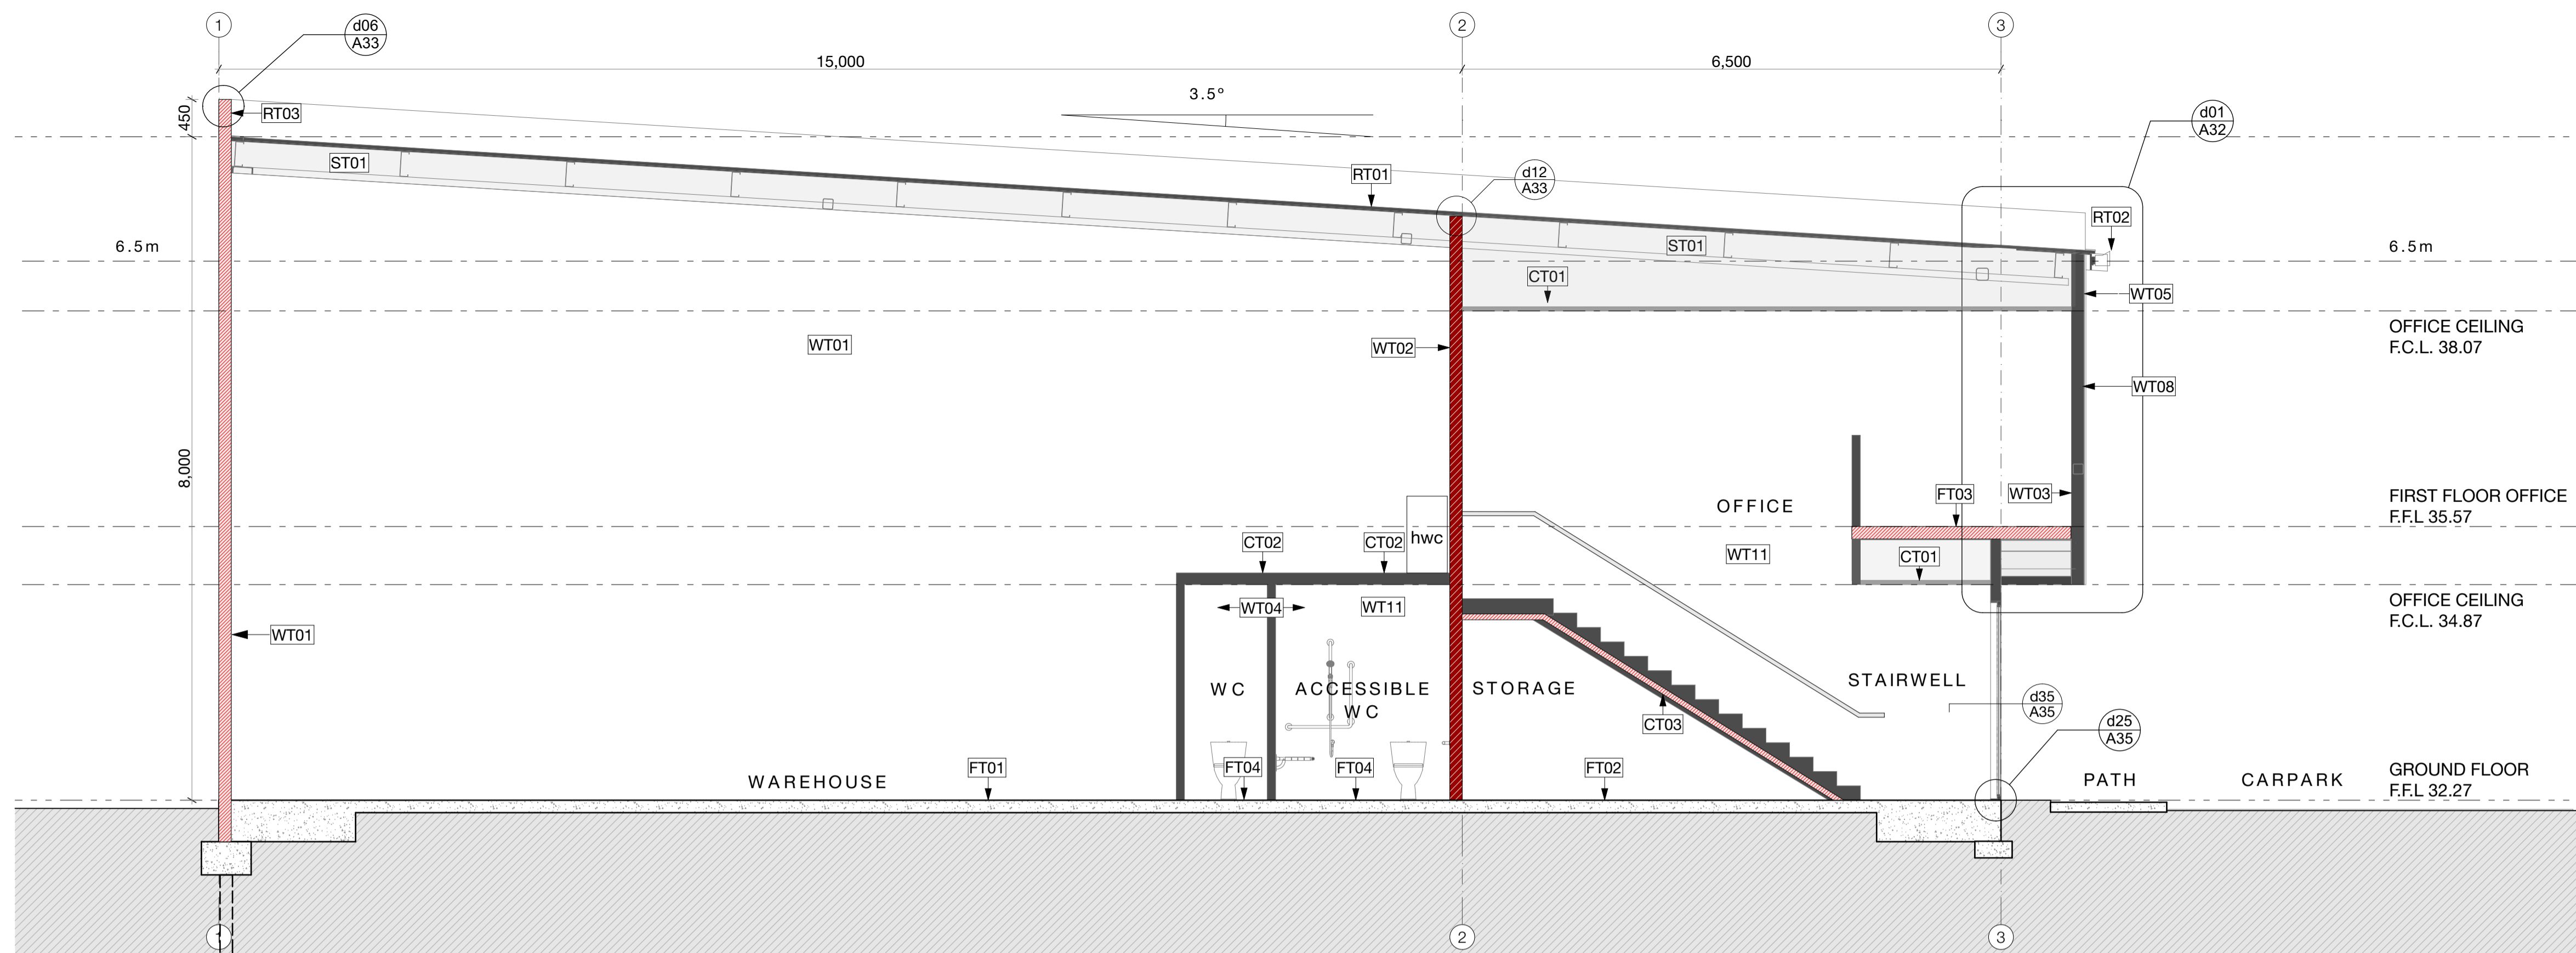

S03 A18 SECTION 03 Scale 1:50

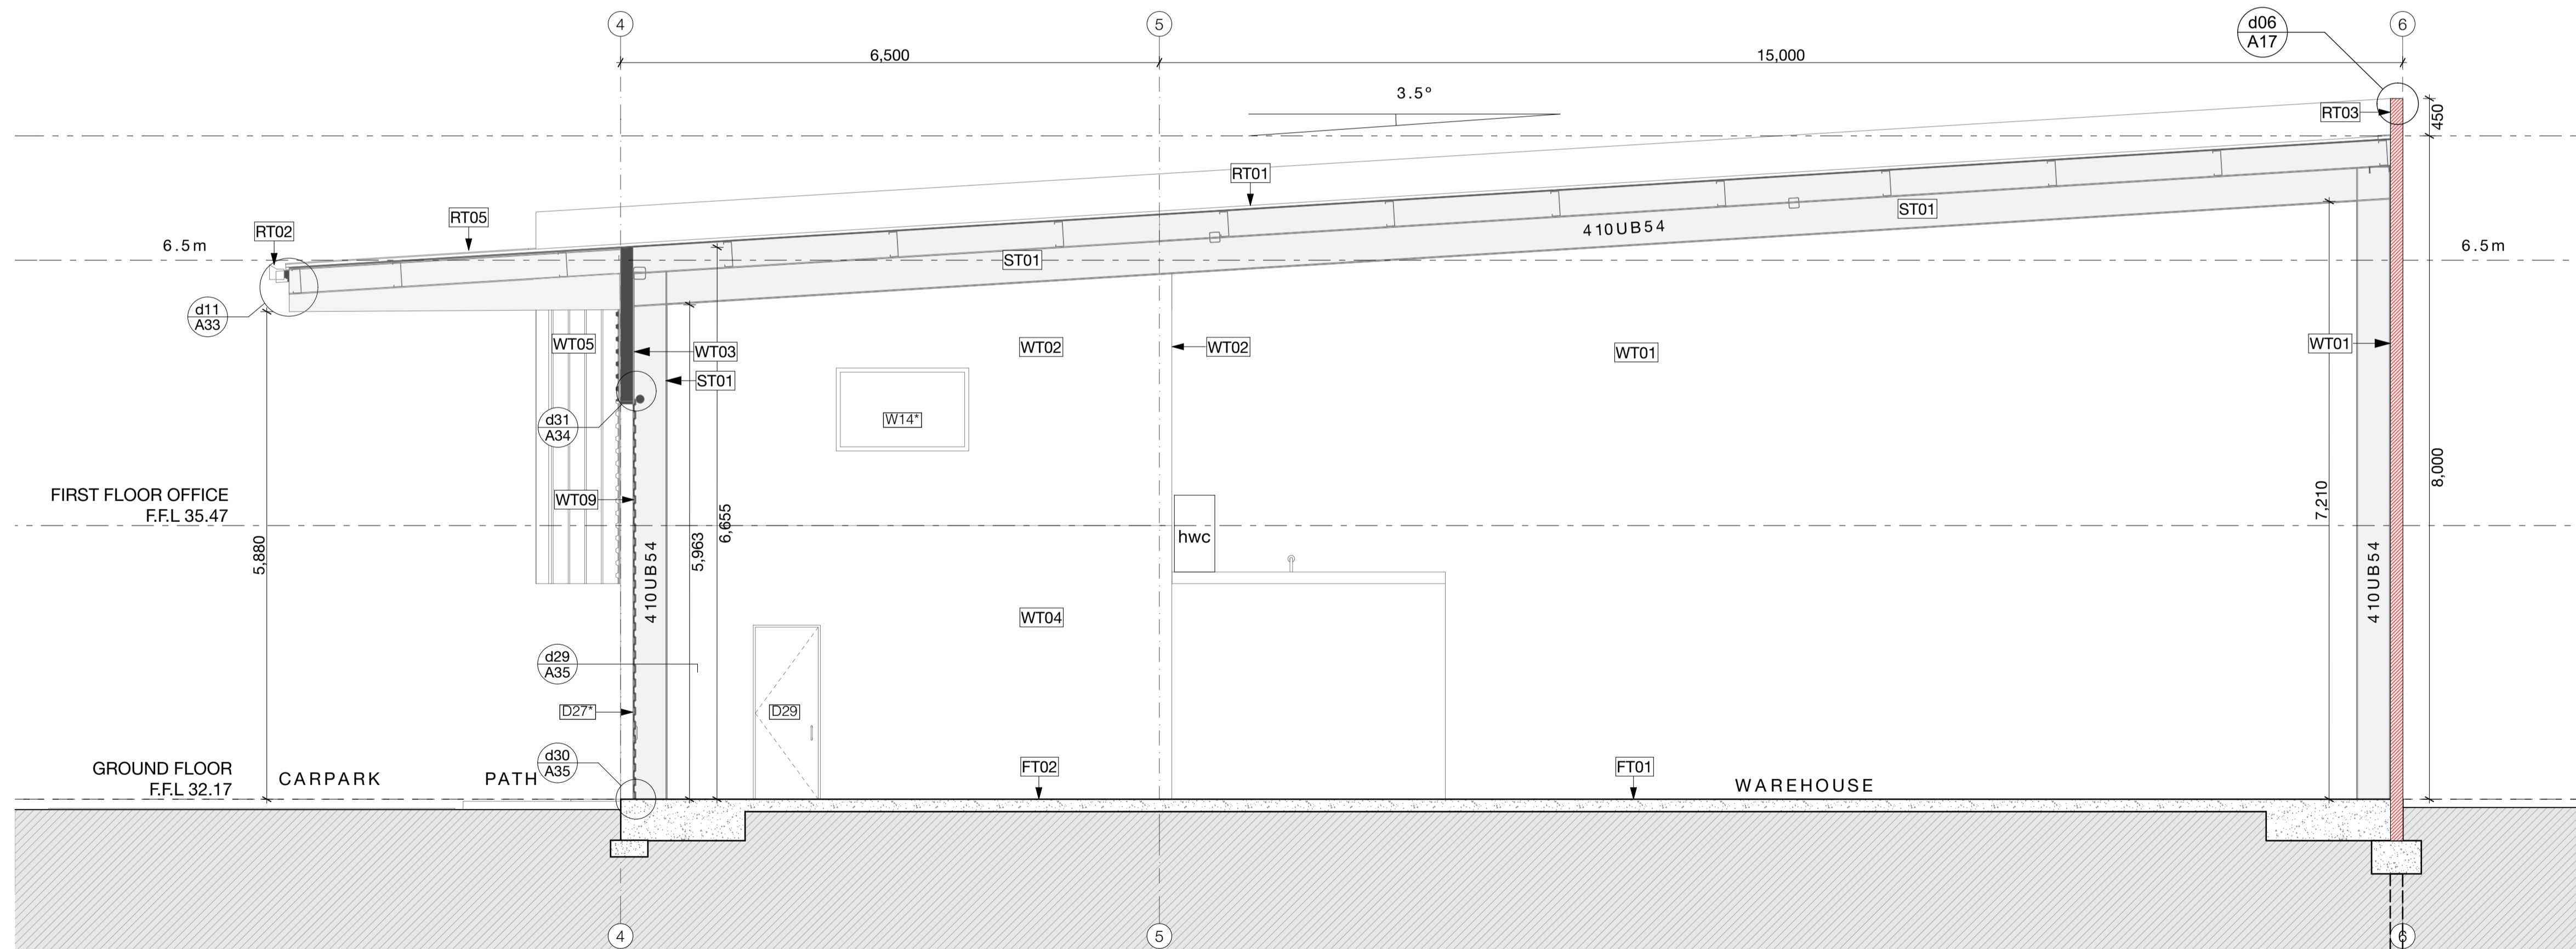

S04 A18 SECTION 04 Scale 1:50

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TE RAPA GATEWAY

FOSTER CONSTRUCTION

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C01	25/06/19

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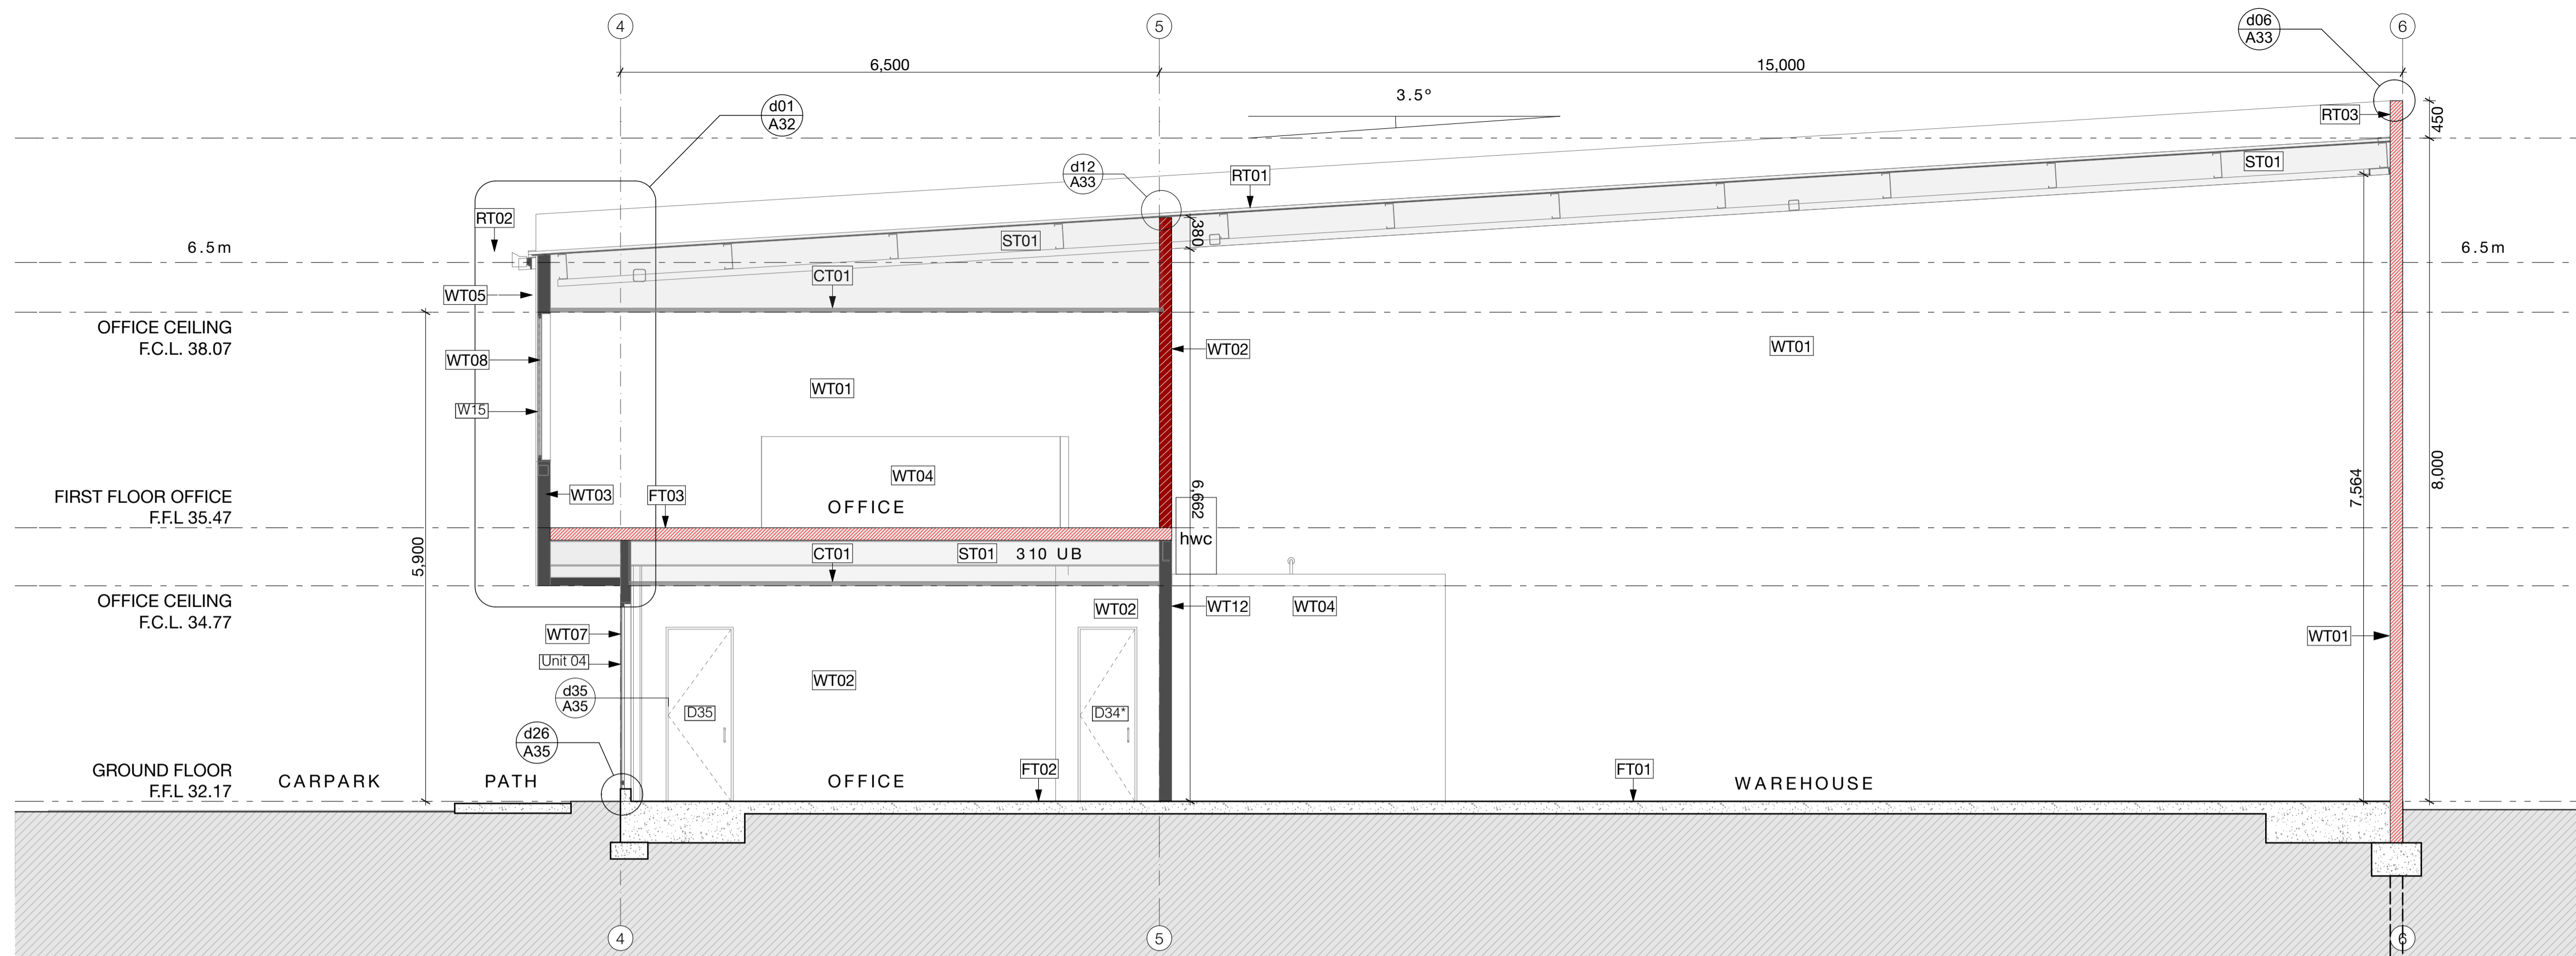
PROJECT:
Te Rapa Stage 2

CLIENT: Fosters Construction
SITE: Te Rapa Industrial Park, Hamilton


FOR CONSTRUCTION ISSUE

DRAWING TITLE:
PROPOSED CROSS SECTIONS

PROJECT REF: T0424 TE RAPA S2	
DATE: 25/06/19	SCALE: 1:50 @ A1
SHEET: A18	REV: C01



S05
A19 SECTION 05
Scale 1:50

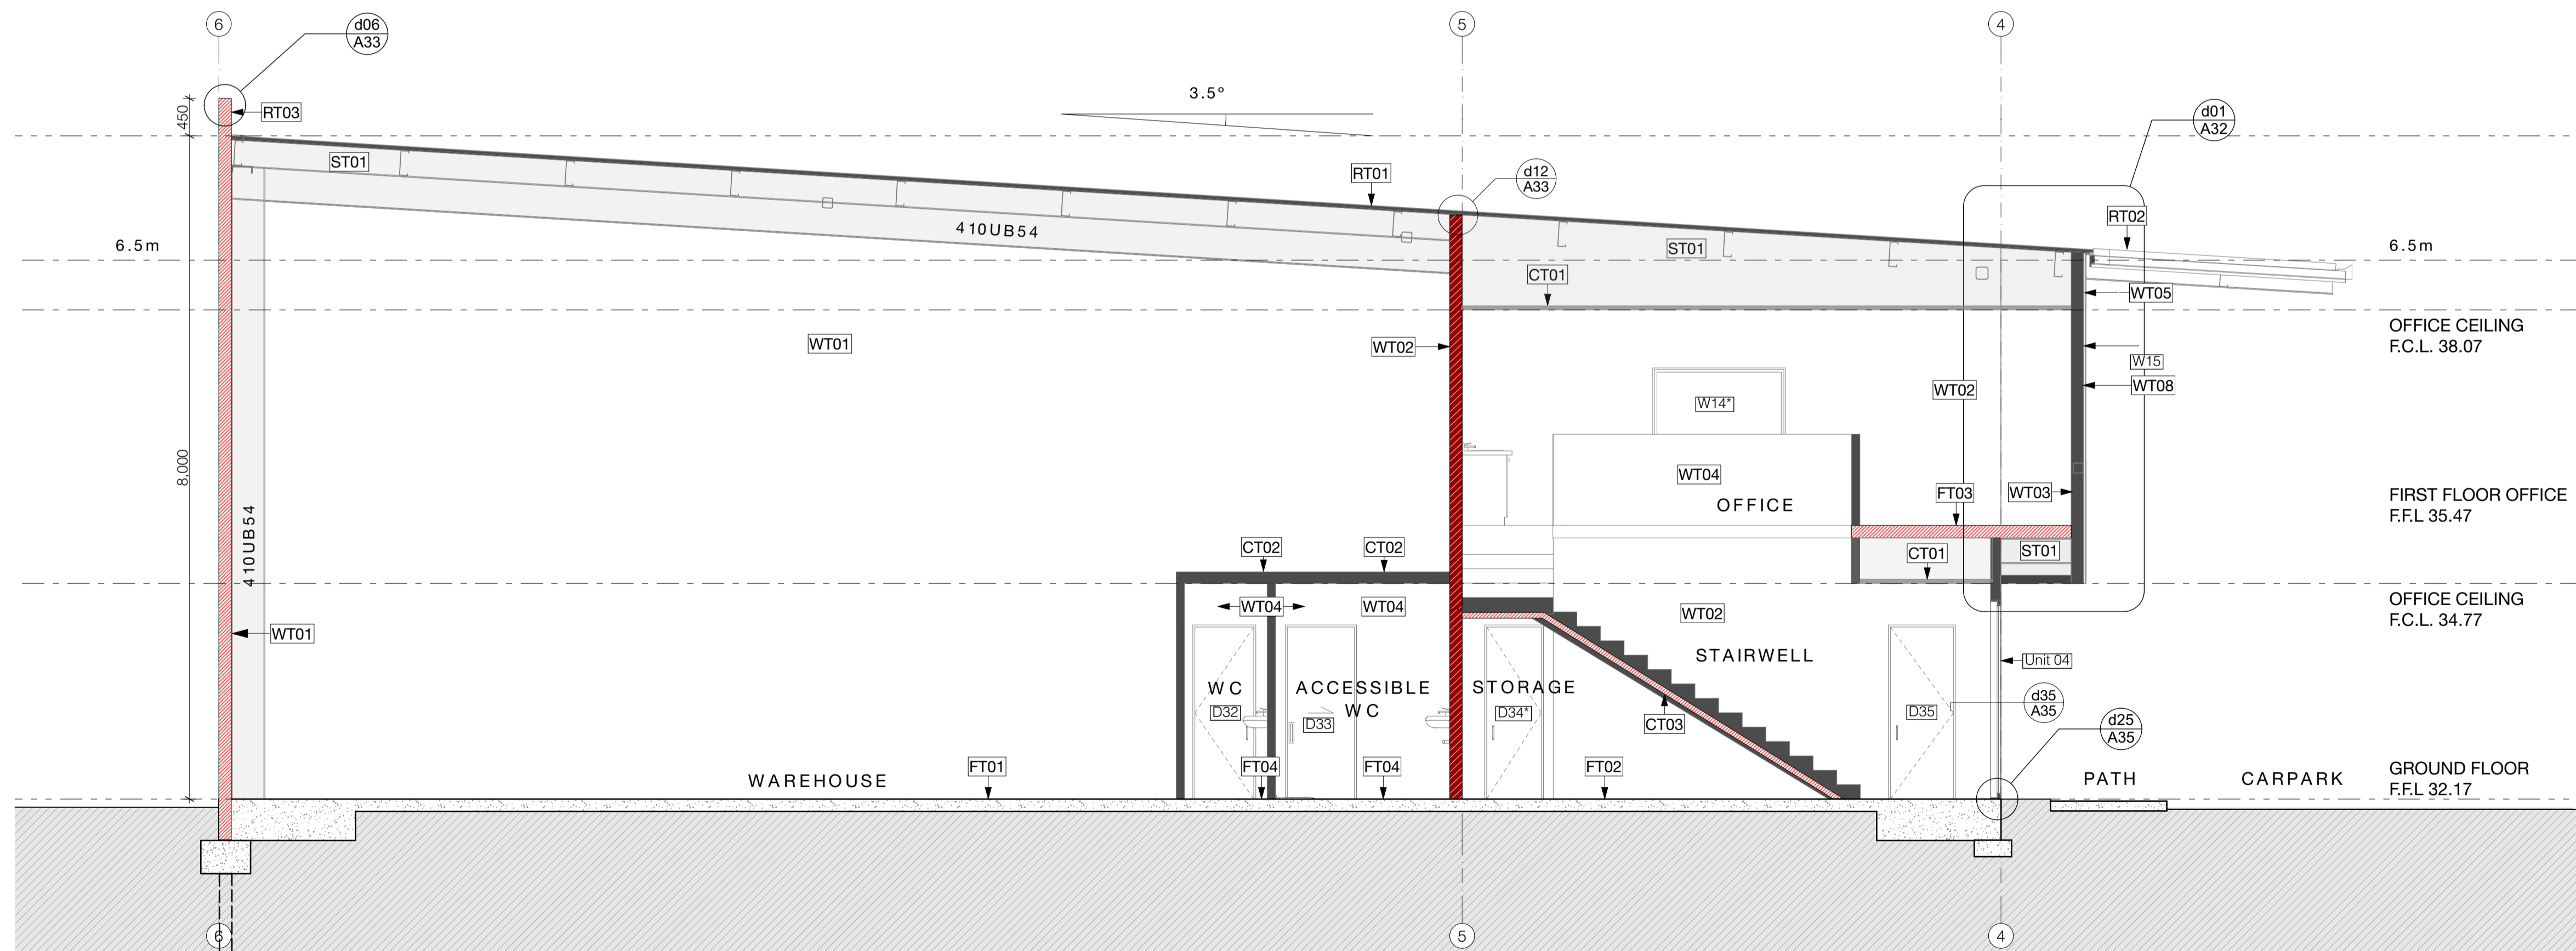

S06
A19 SECTION 06
Scale 1:50

main notes:

- RT01 Roof: 0.55 BMT Dimond BB900 profiled COLORSTEEL roofing with ENDURA finish over selected THERMAKRAFT COVERTEK 405 roofing underlay over safety mesh on roof structure. Office roof cavity insulated with AUTEX greenstuff insulation to achieve min. R3.0
- RT02 External gutter: 0.55 BMT box gutter with COLORSTEEL ENDURA finish fixed with hidden brackets to manufacturers specification.
- RT03 Parapet / apron roof flashings: 0.55 BMT machine folded flashings with COLORSTEEL ENDURA finish.
- RT04 Warehouse roof skylight: AMPELITE SL translucent sheet roofing to match profile of roof fixed over THERMAKRAFT AUSMESH safety mesh (galv. coated) on roof structure - to provide 15% daylighting to warehouse space.
- RT05 Canopy Roof & Soffit: 0.55 BMT Dimond BB900 profiled COLORSTEEL roofing with ENDURA finish over roof structure and to underside of soffit to provide bird proofing.
- ceiling:**
- CT01 Internal office ceiling: USG DONN DX suspended ceiling grid system with selected 1200x600 mineral fibre ceiling tiles SLT edged.
- CT02 Internal ceiling: 13mm GIB AQUALINE ceiling lining fixed to ex75x40mm SG8 timber battens @ 600 crs on 140x45mm joists @ 450 crs covered with 19mm marine ply. Max load 1.5kPa.
- CT03 Underside of stairs: 16mm GIB FYRLINE lining to underside of timber stair structure in accordance with GIB spec - GBFC60. FR 60/60/60 fire rated lining to extend through to fire rated wall structure
- walls:**
- WT01 150mm FR 180/180/180 thick pre-cast concrete panel walls - refer structural and fire engineers documentation.
- WT02 Office fire walls: FR 60/60/60 ex150x50 SG8 wall framing with studs at 600 centres lined with 13mm GIB FYRLINE lining to both sides in accordance with GIB specification - GBT.L60. Walls to extend to underside of roof above.
- WT03 external walls: ex150x50 SG8 wall framing with studs at 600 centres lined with 13mm standard GIB board inside in accordance with GIB specification - GBUW 15. Walls to extend to underside of roof above.
- WT04 Internal walls: ex100x50 SG8 wall framing with studs at 600 centres lined with 10mm standard GIB board lining to interior. 10mm GIB AQUALINE to be used in wet areas. Where vinyl is continued up wall WPS water proofing membrane to be used in strict accordance with manufacturers specification. Face of office walls to warehouse finished with 9.5mm selected plywood to a height of 2.4m above finished floor level.
- WT05 Office cladding: METALCRAFT KAHU cladding with COLORSTEEL ENDURA finish fixed vertically over 20mm cavity battens over COVERTEK 403 building wrap on ex150x50 SG8 wall framing with studs at 600 centres. Insulated cavity with AUTEX insulation min R2.5
- WT06 Warehouse wall cladding: METALCRAFT KAHU cladding with COLORSTEEL ENDURA finish fixed horizontally over 20mm cavity battens over COVERTEK 403 building wrap on precast concrete panel walls.
- WT07 Joinery: VANTAGE external window 125 FLUSHGLAZE suite in seismic frames with powder coated finish and Magnum door.
- WT08 Joinery: VANTAGE 40 external window METRO suite with powder coated finish.
- WT09 Roller door: METALBILT motorised roller shutter door powder coated finish on windssocks all with metal chain and manual back-up.
- WT10 Horizontal sun screens: INSCOL zenith Al sun screen with selected powdercoat finish. Refer manufacturers specifications for all fixings and structural information.
- WT11 Internal strapped walls: ex50x50 SG8 timber strapping at 600 centres with 10mm standard GIB board lining to interior. 10mm GIB AQUALINE to be used in wet areas. AUTEX batt insulation to provide min. R2.5
- WT12 Internal walls: ex150x50 SG8 wall framing with studs at 600 centres lined with 10mm standard GIB board lining to interior. 10mm GIB AQUALINE to be used in wet areas. Where vinyl is continued up wall WPS water proofing membrane to be used in strict accordance with manufacturers specification. Face of office walls to warehouse finished with 9.5mm selected plywood to a height of 2.4m above finished floor level.
- floors:**
- FT01 Warehouse floor: 150mm thick reinforced concrete slab foundation on DPM and sand blinding on minimum 150mm thick compacted hard fill - refer structural engineers documentation for all structural information.
- FT02 Office ground floor: 150mm thick reinforced concrete slab foundation on DPM and sand blinding on minimum 150mm thick compacted hard fill - refer structural engineer.
- FT03 Office first floor: FRR 60/60/60 150mm thick Comfor - refer structural engineer.
- FT04 Selected commercial grade vinyl flooring
- structural:**
- ST01 Structural framing - refer structural engineer documentation for all structural detail.
- note:**
- All materials, fittings, fixtures, and finishes to be established in strict accordance with manufactures specification.
- This architectural documentation is to be read in conjunction with all specialist documentation and reports. Refer to engineering documentation for all engineering requirements.
- fire design requirements:**
- All precast concrete panel walls to provide FR 180/180/180 (150 thick). Ground floor office to be fire rated and separate to the first floor fire cell - all fire rated FR 60/60/60. All supporting structure, stairs and underside of floors to be fire rated FR 60/60/60.
- FD = fire door. Refer fire report for all fire design requirements.
- W03 Window joinery - Refer D & W schedule
- Refer finishes plans for floor, wall & ceiling finishes

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PROJECT:
Te Rapa Stage 2

CLIENT: Fosters Construction
SITE: Te Rapa Industrial Park, Hamilton


FOR CONSTRUCTION ISSUE

DRAWING TITLE:
PROPOSED CROSS SECTIONS


PROJECT REF: T0424 TE RAPA S2	
DATE: 25/06/19	SCALE: 1:50 @ A1
SHEET: A19	REV: C01

main notes:


- RT01** Roof: 0.55 BMT Dimond BB900 profiled COLORSTEEL roofing with ENDURA finish over selected THERMAKRAFT COVERTEK 405 roofing underlay over safety mesh on roof structure. Office roof cavity insulated with AUTEX greenstul insulation to achieve min. R3.0
- RT02** External gutter: 0.55 BMT box gutter with COLORSTEEL ENDURA finish fixed with hidden brackets to manufacturers specification.
- RT03** Parapet / apron roof flashings: 0.55 BMT machine folded flashings with COLORSTEEL ENDURA finish.
- RT04** Warehouse roof skylight: AMPELITE SL translucent sheet roofing to match profile of roof fixed over THERMAKRAFT AUSMESH safety mesh (galv. coated) on roof structure - to provide 15% daylighting to warehouse space.
- RT05** Canopy Roof & Soffit: 0.55 BMT Dimond BB900 profiled COLORSTEEL roofing with ENDURA finish over roof structure and to underside of soffit to provide bird proofing.
- ceiling:**
- CT01** Internal office ceiling: USG DONN DX suspended ceiling grid system with selected 1200x600 mineral fibre ceiling tiles SLT edged.
- CT02** Internal ceiling: 13mm GIB AQUALINE ceiling lining fixed to ex75x40mm SGB timber battens @ 600 crs on 140x45mm joists @ 450 crs covered with 19mm marine ply. Max load 1.5kPa.
- CT03** Underside of stairs: 16mm GIB FYRLINE lining to underside of timber stair structure in accordance with GIB spec - GBFC60. FR 60/60/60 fire rated lining to extend through to fire rated wall structure
- walls:**
- WT01** 150mm FR 180/180/180 thick pre-cast concrete panel walls - refer structural and fire engineers documentation.
- WT02** Office fire walls: FR 60/60/60 ex150x50 SGB wall framing with studs at 600 centres lined with 13mm GIB FYRLINE lining to both sides in accordance with GIB specification - GBT.L60. Walls to extend to underside of roof above.
- WT03** external walls: ex150x50 SGB wall framing with studs at 600 centres lined with 13mm standard GIB board inside in accordance with GIB specification - GBUW 15. Walls to extend to underside of roof above.
- WT04** Internal walls: ex100x50 SGB wall framing with studs at 600 centres lined with 10mm standard GIB board lining to interior. 10mm GIB AQUALINE to be used in wet areas. Where vinyl is continued up wall WPS water proofing membrane to be used in strict accordance with manufacturers specification. Face of office walls to warehouse finished with 9.5mm selected plywood to a height of 2.4m above finished floor level.
- WT05** Office cladding: METALCRAFT KAHU cladding with COLORSTEEL ENDURA finish fixed vertically over 20mm cavity battens over COVERTEK 403 building wrap on ex150x50 SGB wall framing with studs at 600 centres. Insulated cavity with AUTEX insulation min R2.5
- WT06** Warehouse wall cladding: METALCRAFT KAHU cladding with COLORSTEEL ENDURA finish fixed horizontally over 20mm cavity battens over COVERTEK 403 building wrap on precast concrete panel walls.
- WT07** Joinery: VANTAGE external window 125 FLUSHGLAZE suite in seismic frames with powder coated finish and Magnum door.
- WT08** Joinery: VANTAGE 40 external window METRO suite with powder coated finish.
- WT09** Roller door: METALBLT motorised roller shutter door powder coated finish on windsocks all with metal chain and manual back-up.
- WT10** Horizontal sun screens: INSQL zenith AI sun screen with selected powdercoat finish. Refer manufacturers specifications for all fixings and structural information.
- WT11** Internal strapped walls: ex50x50 SGB timber strapping at 600 centres lined with 10mm standard GIB board lining to interior. 10mm GIB AQUALINE to be used in wet areas. AUTEX batt insulation to provide min. R2.5
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- floors:**
- FT01** Warehouse floor: 150mm thick reinforced concrete slab foundation on DPM and sand blinding on minimum 150mm thick compacted hard fill - refer structural engineers documentation for all structural information.
- FT02** Office ground floor: 150mm thick reinforced concrete slab foundation on DPM and sand blinding on minimum 150mm thick compacted hard fill - refer structural engineer.
- FT03** Office first floor: FRR 60/60/60 150mm thick Comfloor - refer structural engineer.
- FT04** Selected commercial grade vinyl flooring
- structural:**
- ST01** Structural framing - refer structural engineer documentation for all structural detail.
- note:**
- All materials, fittings, fixtures, and finishes to be established in strict accordance with manufacturers specification.
- This architectural documentation is to be read in conjunction with all specialist documentation and reports. Refer to engineering documentation for all engineering requirements.
- fire design requirements:**
- All precast concrete panel walls to provide FR 180/180/180 (150 thick). Ground floor office to be fire rated and separate to the first floor fire cell - all fire rated FR 60/60/60. All supporting structure, stairs and underside of floors to be fire rated FR 60/60/60.
- FD** = fire door. Refer fire report for all fire design requirements.
- W03** Window joinery - Refer D & W schedule
- Refer finishes plans for floor, wall & ceiling finishes

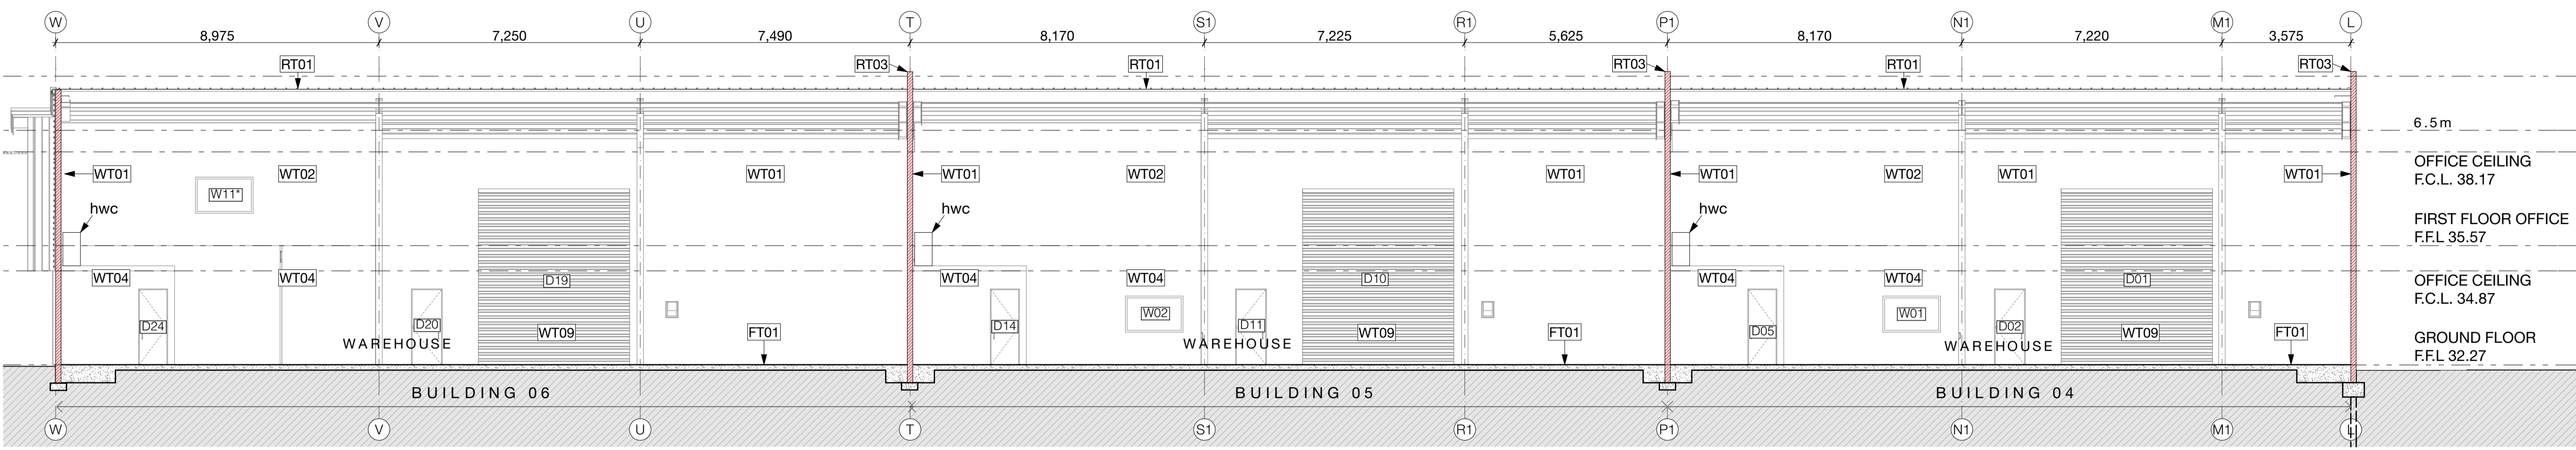


SECTION 07
1:100

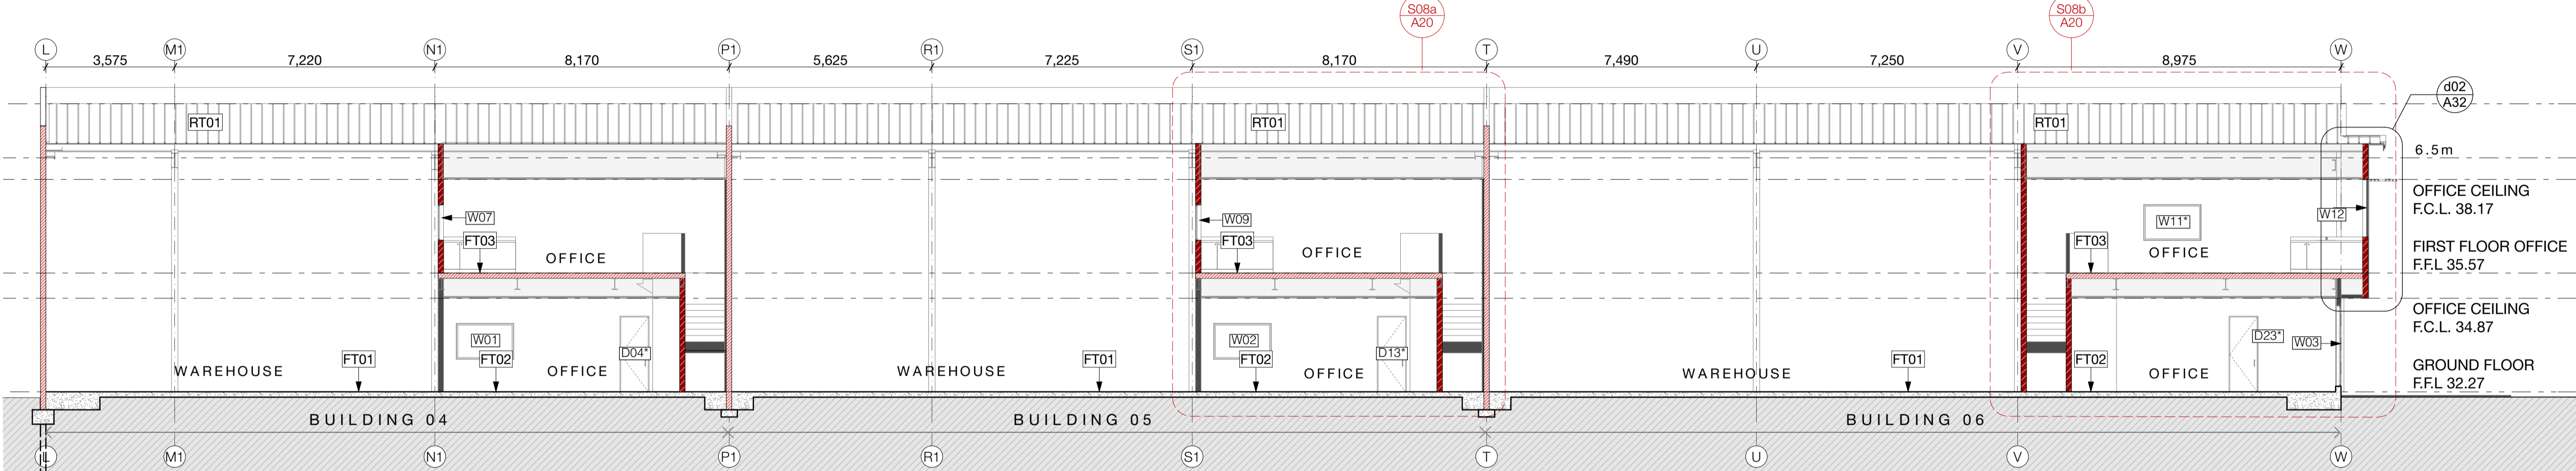

SECTION 08
1:100

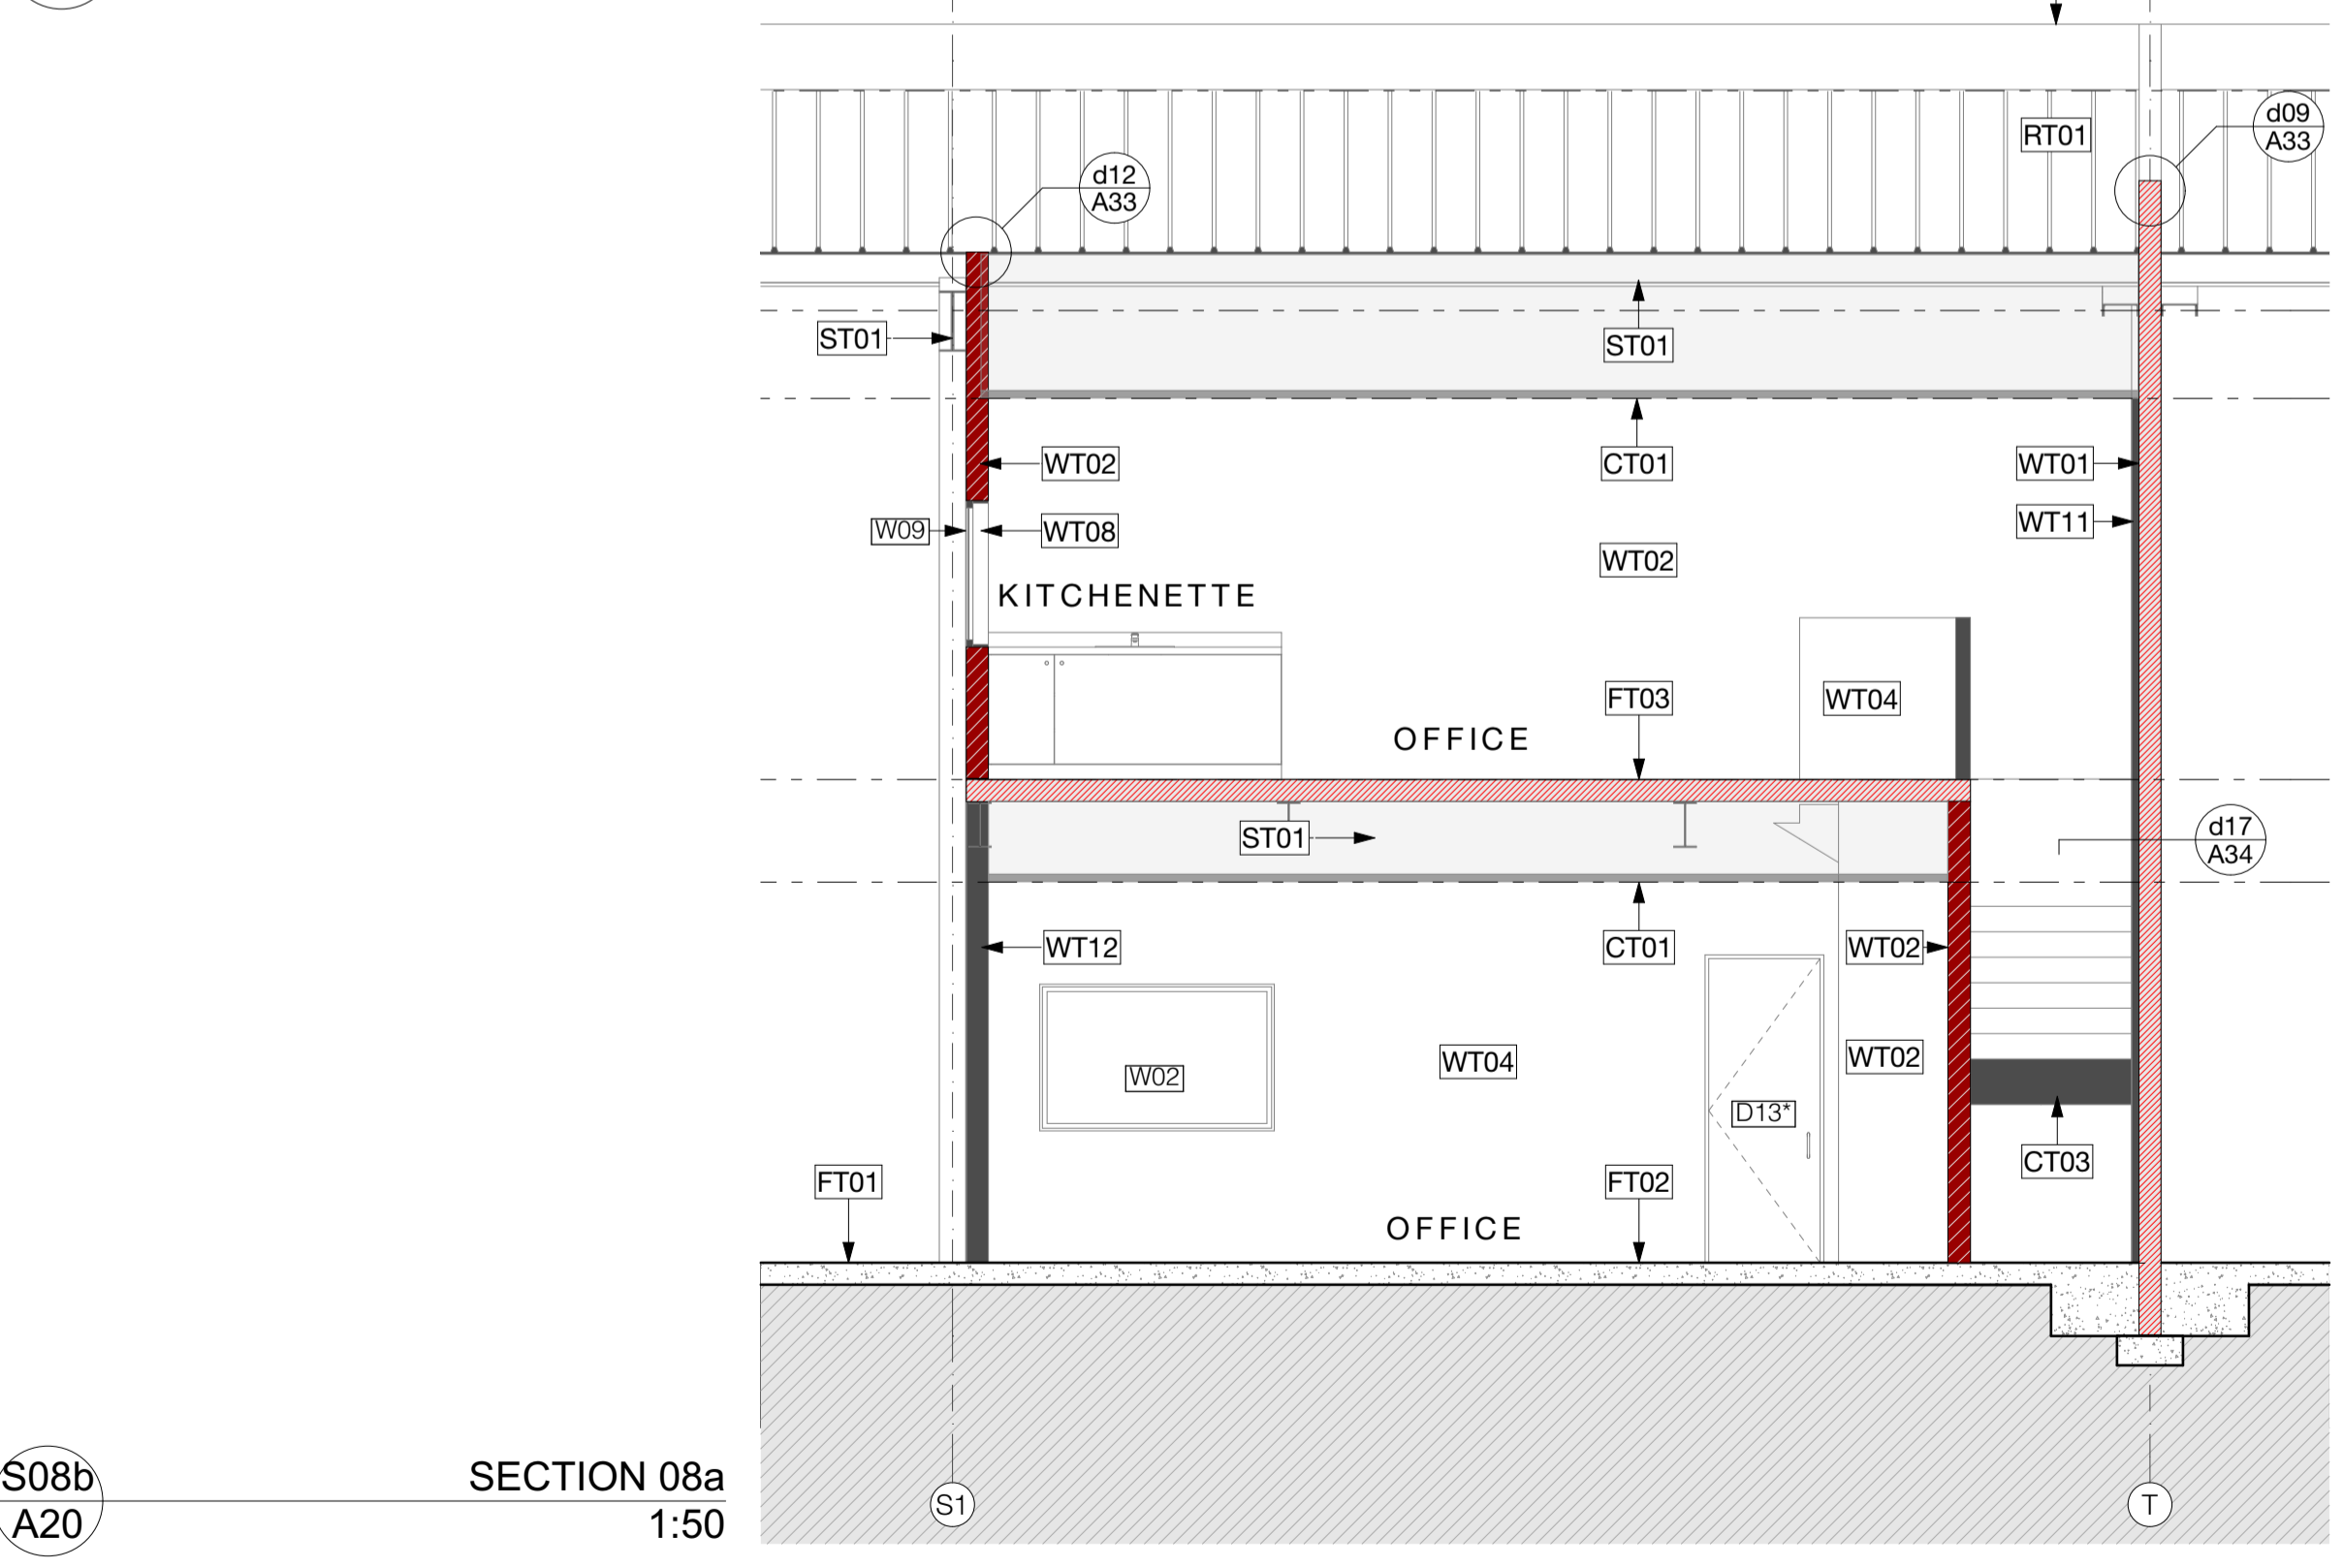

SECTION 08a
1:50

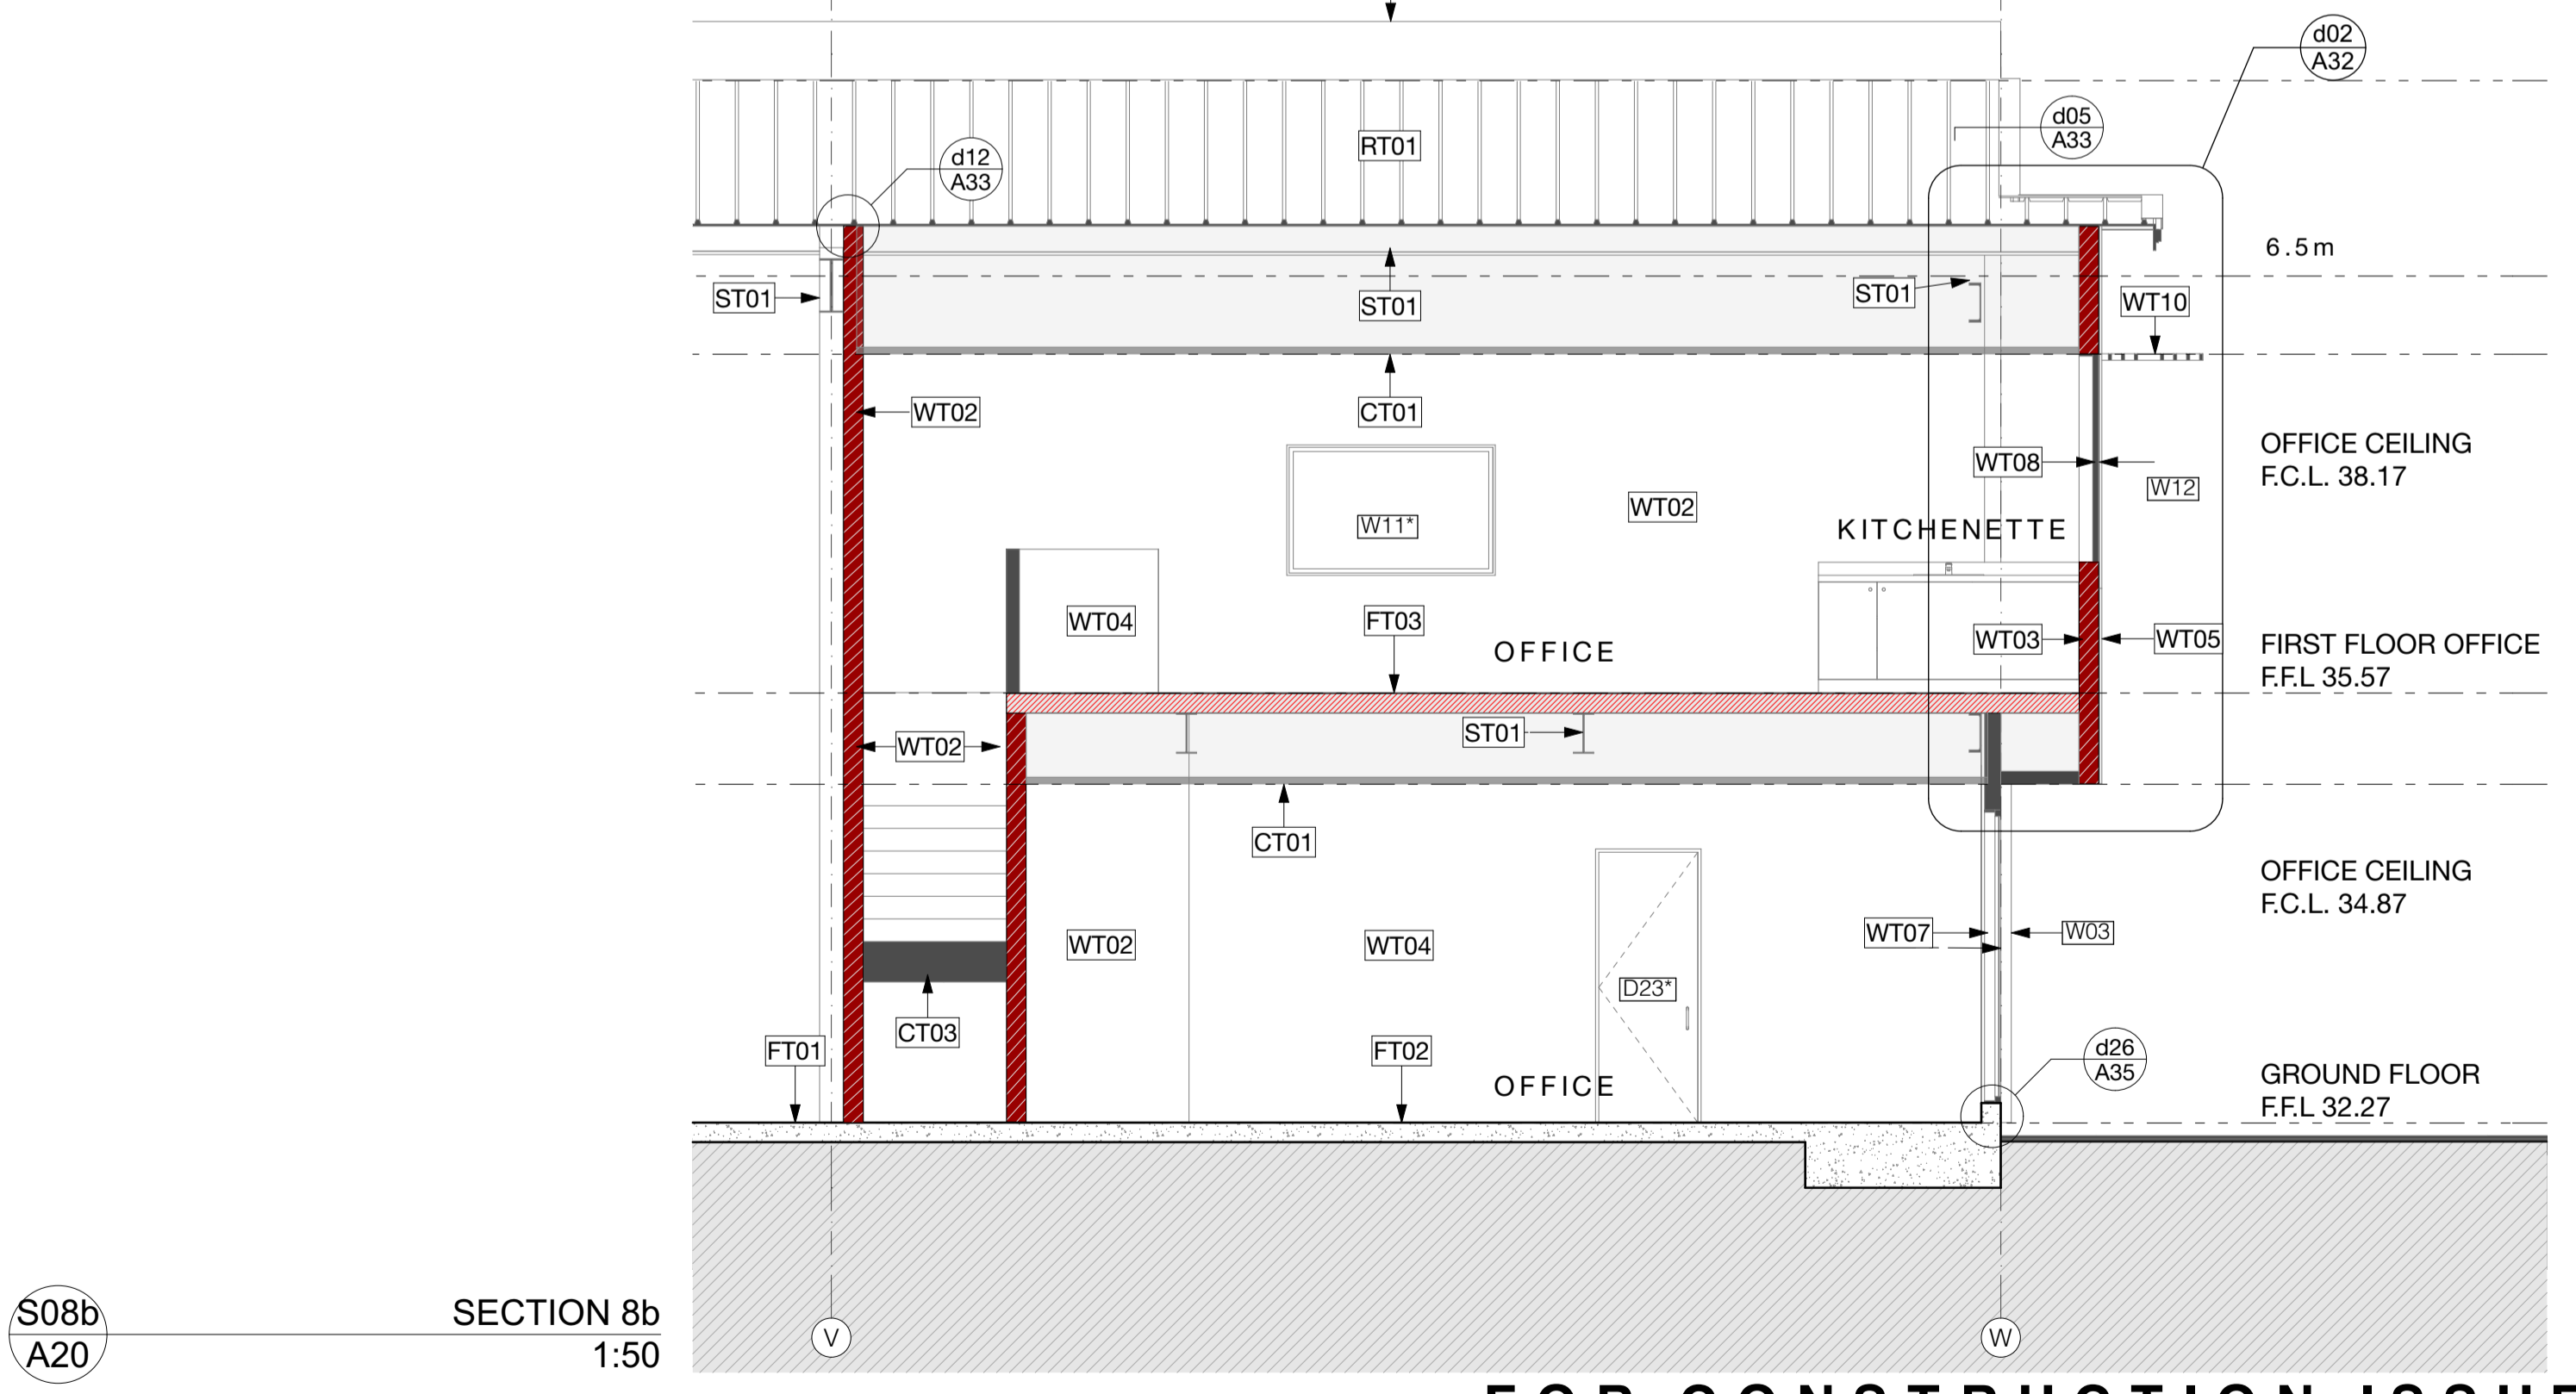

SECTION 08b
1:50

FOR CONSTRUCTION ISSUE

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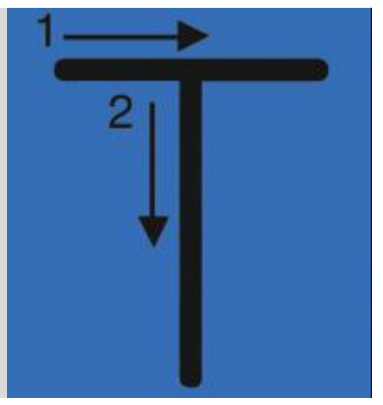
TE RAPA GATEWAY

FOSTER CONSTRUCTION

ISSUE: C01
DATE: 25/06/19


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private bag 93010 new lynn auckland 0600



PROJECT: **Te Rapa Stage 2**

CLIENT: Fosters Construction
SITE: Te Rapa Industrial Park, Hamilton

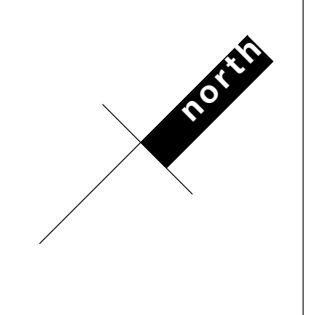

DRAWING TITLE: **PROPOSED LONG SECTIONS**

PROJECT REF: T0424 TE RAPA S2	
DATE: 25/06/19	SCALE: 1:50, 1:100 @ A1
SHEET: A20	REV: C01

main notes
roof:

- RT01 Roof: 0.55 BMT Dimond BB900 profiled COLORSTEEL roofing with ENDURA finish over selected THERMAKRAFT COVERTEK 405 roofing underlay over safety mesh on roof structure. Office roof cavity insulated with AUTEX greenstuf insulation to achieve min. R3.0
- RT02 External gutter: 0.55 BMT box gutter with COLORSTEEL ENDURA finish fixed with hidden brackets to manufacturers specification.
- RT03 Parapet / apron roof flashings: 0.55 BMT machine folded flashings with COLORSTEEL ENDURA finish.
- RT04 Warehouse roof skylight: AMPELITE SL translucent sheet roofing to match profile of roof fixed over THERMAKRAFT AUSMESH safety mesh (galv. coated) on roof structure - to provide 15% daylighting to warehouse space.
- RT05 Canopy Roof & Soffit: 0.55 BMT Dimond BB900 profiled COLORSTEEL roofing with ENDURA finish over roof structure and to underside of soffit to provide bird proofing.

ceiling:

- CT01 Internal office ceiling: USG DONN DX suspended ceiling grid system with selected 1200x600 mineral fibre ceiling tiles SLT edged.
- CT02 Internal ceiling: 13mm GIB AQUALINE ceiling lining fixed to ex75x40mm SG8 timber battens @ 600 crs on 140x45mm joists @ 450 crs covered with 19mm marine ply. Max load 1.5kPa.
- CT03 Underside of stairs: 16mm GIB FYRLINE lining to underside of timber stair structure in accordance with GIB spec - GBFC60. FR 60/60/60 fire rated lining to extend through to fire rated wall structure

walls:

- WT01 150mm FR 180/180/180 thick pre-cast concrete panel walls - refer structural and fire engineers documentation.
- WT02 Office fire walls: FR 60/60/60 ex150x50 SG8 wall framing with studs at 600 centres lined with 13mm GIB FYRLINE lining to both sides in accordance with GIB specification - GBT L60. Walls to extend to underside of roof above.
- WT03 external walls: ex150x50 SG8 wall framing with studs at 600 centres lined with 13mm standard GIB board inside in accordance with GIB specification - GBLUW 15. Walls to extend to underside of roof above.
- WT04 Internal walls: ex100x50 SG8 wall framing with studs at 600 centres lined with 10mm standard GIB board lining to interior. 10mm GIB AQUALINE to be used in wet areas. Where vinyl is continued up wall WPS water proofing membrane to be used in strict accordance with manufacturers specification. Face of office walls to warehouse finished with 9.5mm selected plywood to a height of 2.4m above finished floor level.
- WT05 Office cladding: METALCRAFT KAHU cladding with COLORSTEEL ENDURA finish fixed vertically over 20mm cavity battens over COVERTEK 403 building wrap on ex150x50 SG8 wall framing with studs at 600 centres. Insulated cavity with AUTEX insulation min R2.5
- WT06 Warehouse wall cladding: METALCRAFT KAHU cladding with COLORSTEEL ENDURA finish fixed horizontally over 20mm cavity battens over COVERTEK 403 building wrap on precast concrete panel walls.
- WT07 Joinery: VANTAGE external window 125 FLUSHGLAZE suite in seismic frames with powder coated finish and Magnum door.
- WT08 Joinery: VANTAGE 40 external window METRO suite with powder coated finish.
- WT09 Roller door: METALBLIT motorised roller shutter door powder coated finish on windsocks all with metal chain and manual back-up.
- WT10 Horizontal sun screens: INSQL zenith AI sun screen with selected powdercoat finish. Refer manufacturers specifications for all fixings and structural information.
- WT11 Internal strapped walls: ex50x50 SG8 timber strapping at 600 centres lined with 10mm standard GIB board lining to interior. 10mm GIB AQUALINE to be used in wet areas. AUTEX batt insulation to provide min. R2.5
- WT12 Internal walls: ex150x50 SG8 wall framing with studs at 600 centres lined with 10mm standard GIB board lining to interior. 10mm GIB AQUALINE to be used in wet areas. Where vinyl is continued up wall WPS water proofing membrane to be used in strict accordance with manufacturers specification. Face of office walls to warehouse finished with 9.5mm selected plywood to a height of 2.4m above finished floor level.

floors:

- FT01 Warehouse floor: 150mm thick reinforced concrete slab foundation on DPM and sand blinding on minimum 150mm thick compacted hard fill - refer structural engineers documentation for all structural information.
- FT02 Office ground floor: 150mm thick reinforced concrete slab foundation on DPM and sand blinding on minimum 150mm thick compacted hard fill - refer structural engineer.
- FT03 Office first floor: FRR 60/60/60 150mm thick Comfloor - refer structural engineer.
- FT04 Selected commercial grade vinyl flooring

structural:

- ST01 Structural framing - refer structural engineer documentation for all structural detail.

note:

All materials, fittings, fixtures, and finishes to be established in strict accordance with manufactures specification.

This architectural documentation is to be read in conjunction with all specialist documentation and reports. Refer to engineering documentation for all engineering requirements.


fire design requirements:

All precast concrete panel walls to provide FR 180/180/180 (150 thick). Ground floor office to be fire rated and separate to the first floor fire cell - all fire rated FR 60/60/60. All supporting structure, stairs and underside of floors to be fire rated FR 60/60/60.


FD FD = fire door. Refer fire report for all fire design requirements.

W03 Window joinery - Refer D & W schedule


Refer finishes plans for floor, wall & ceiling finishes

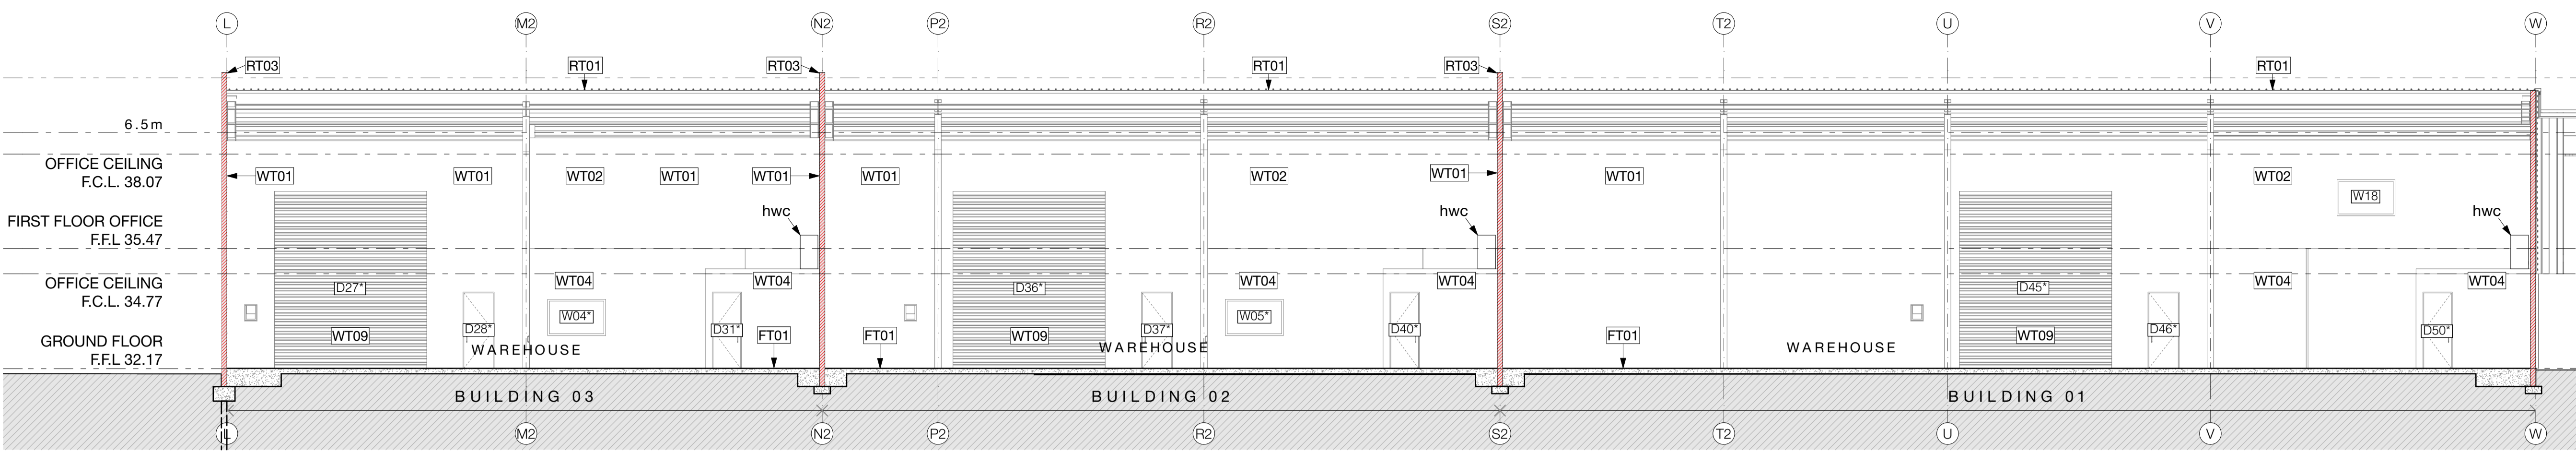


S09 A21 SECTION 09 Scale:1:100

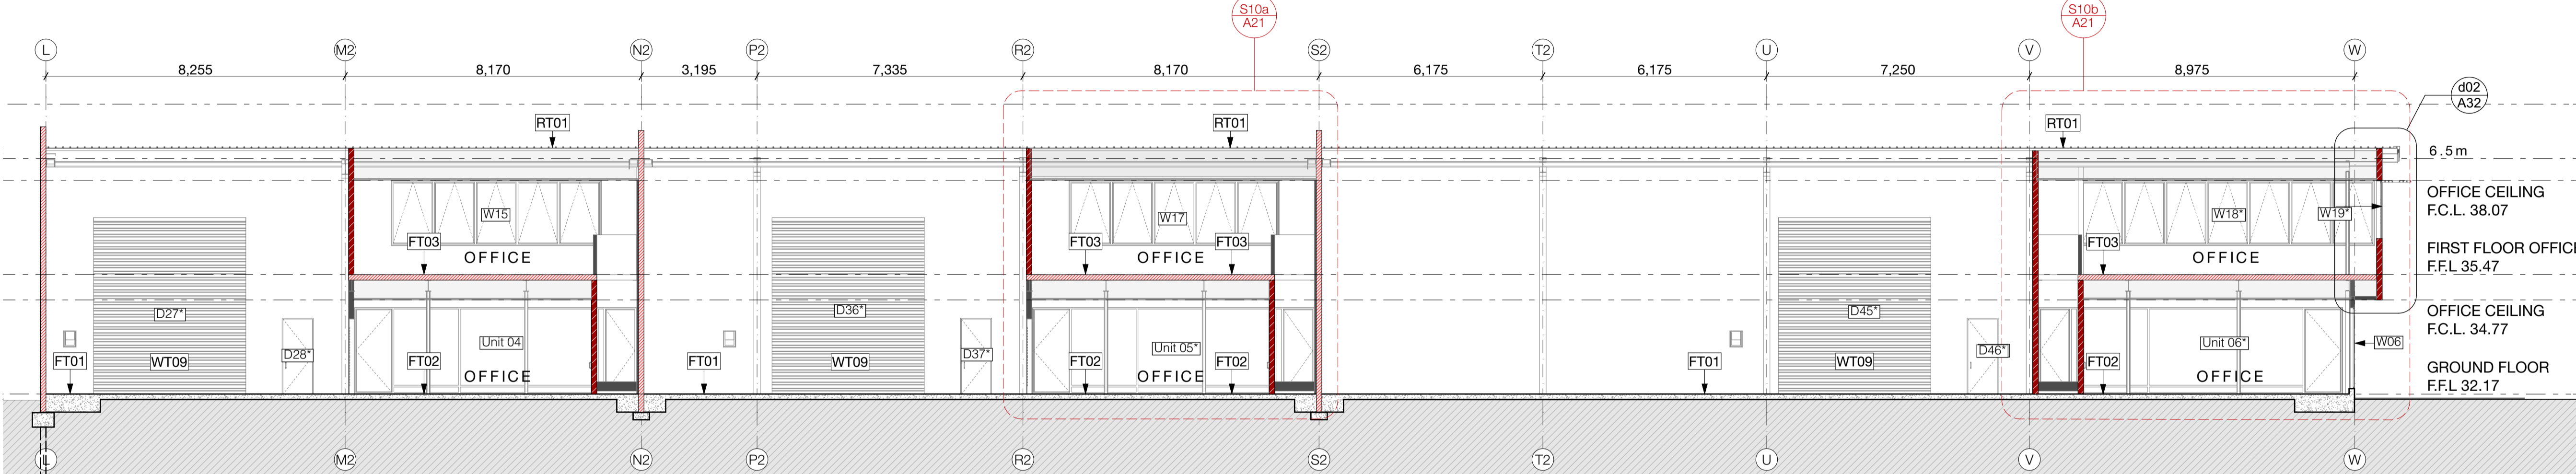

S10 A21 SECTION 10 Scale:1:100

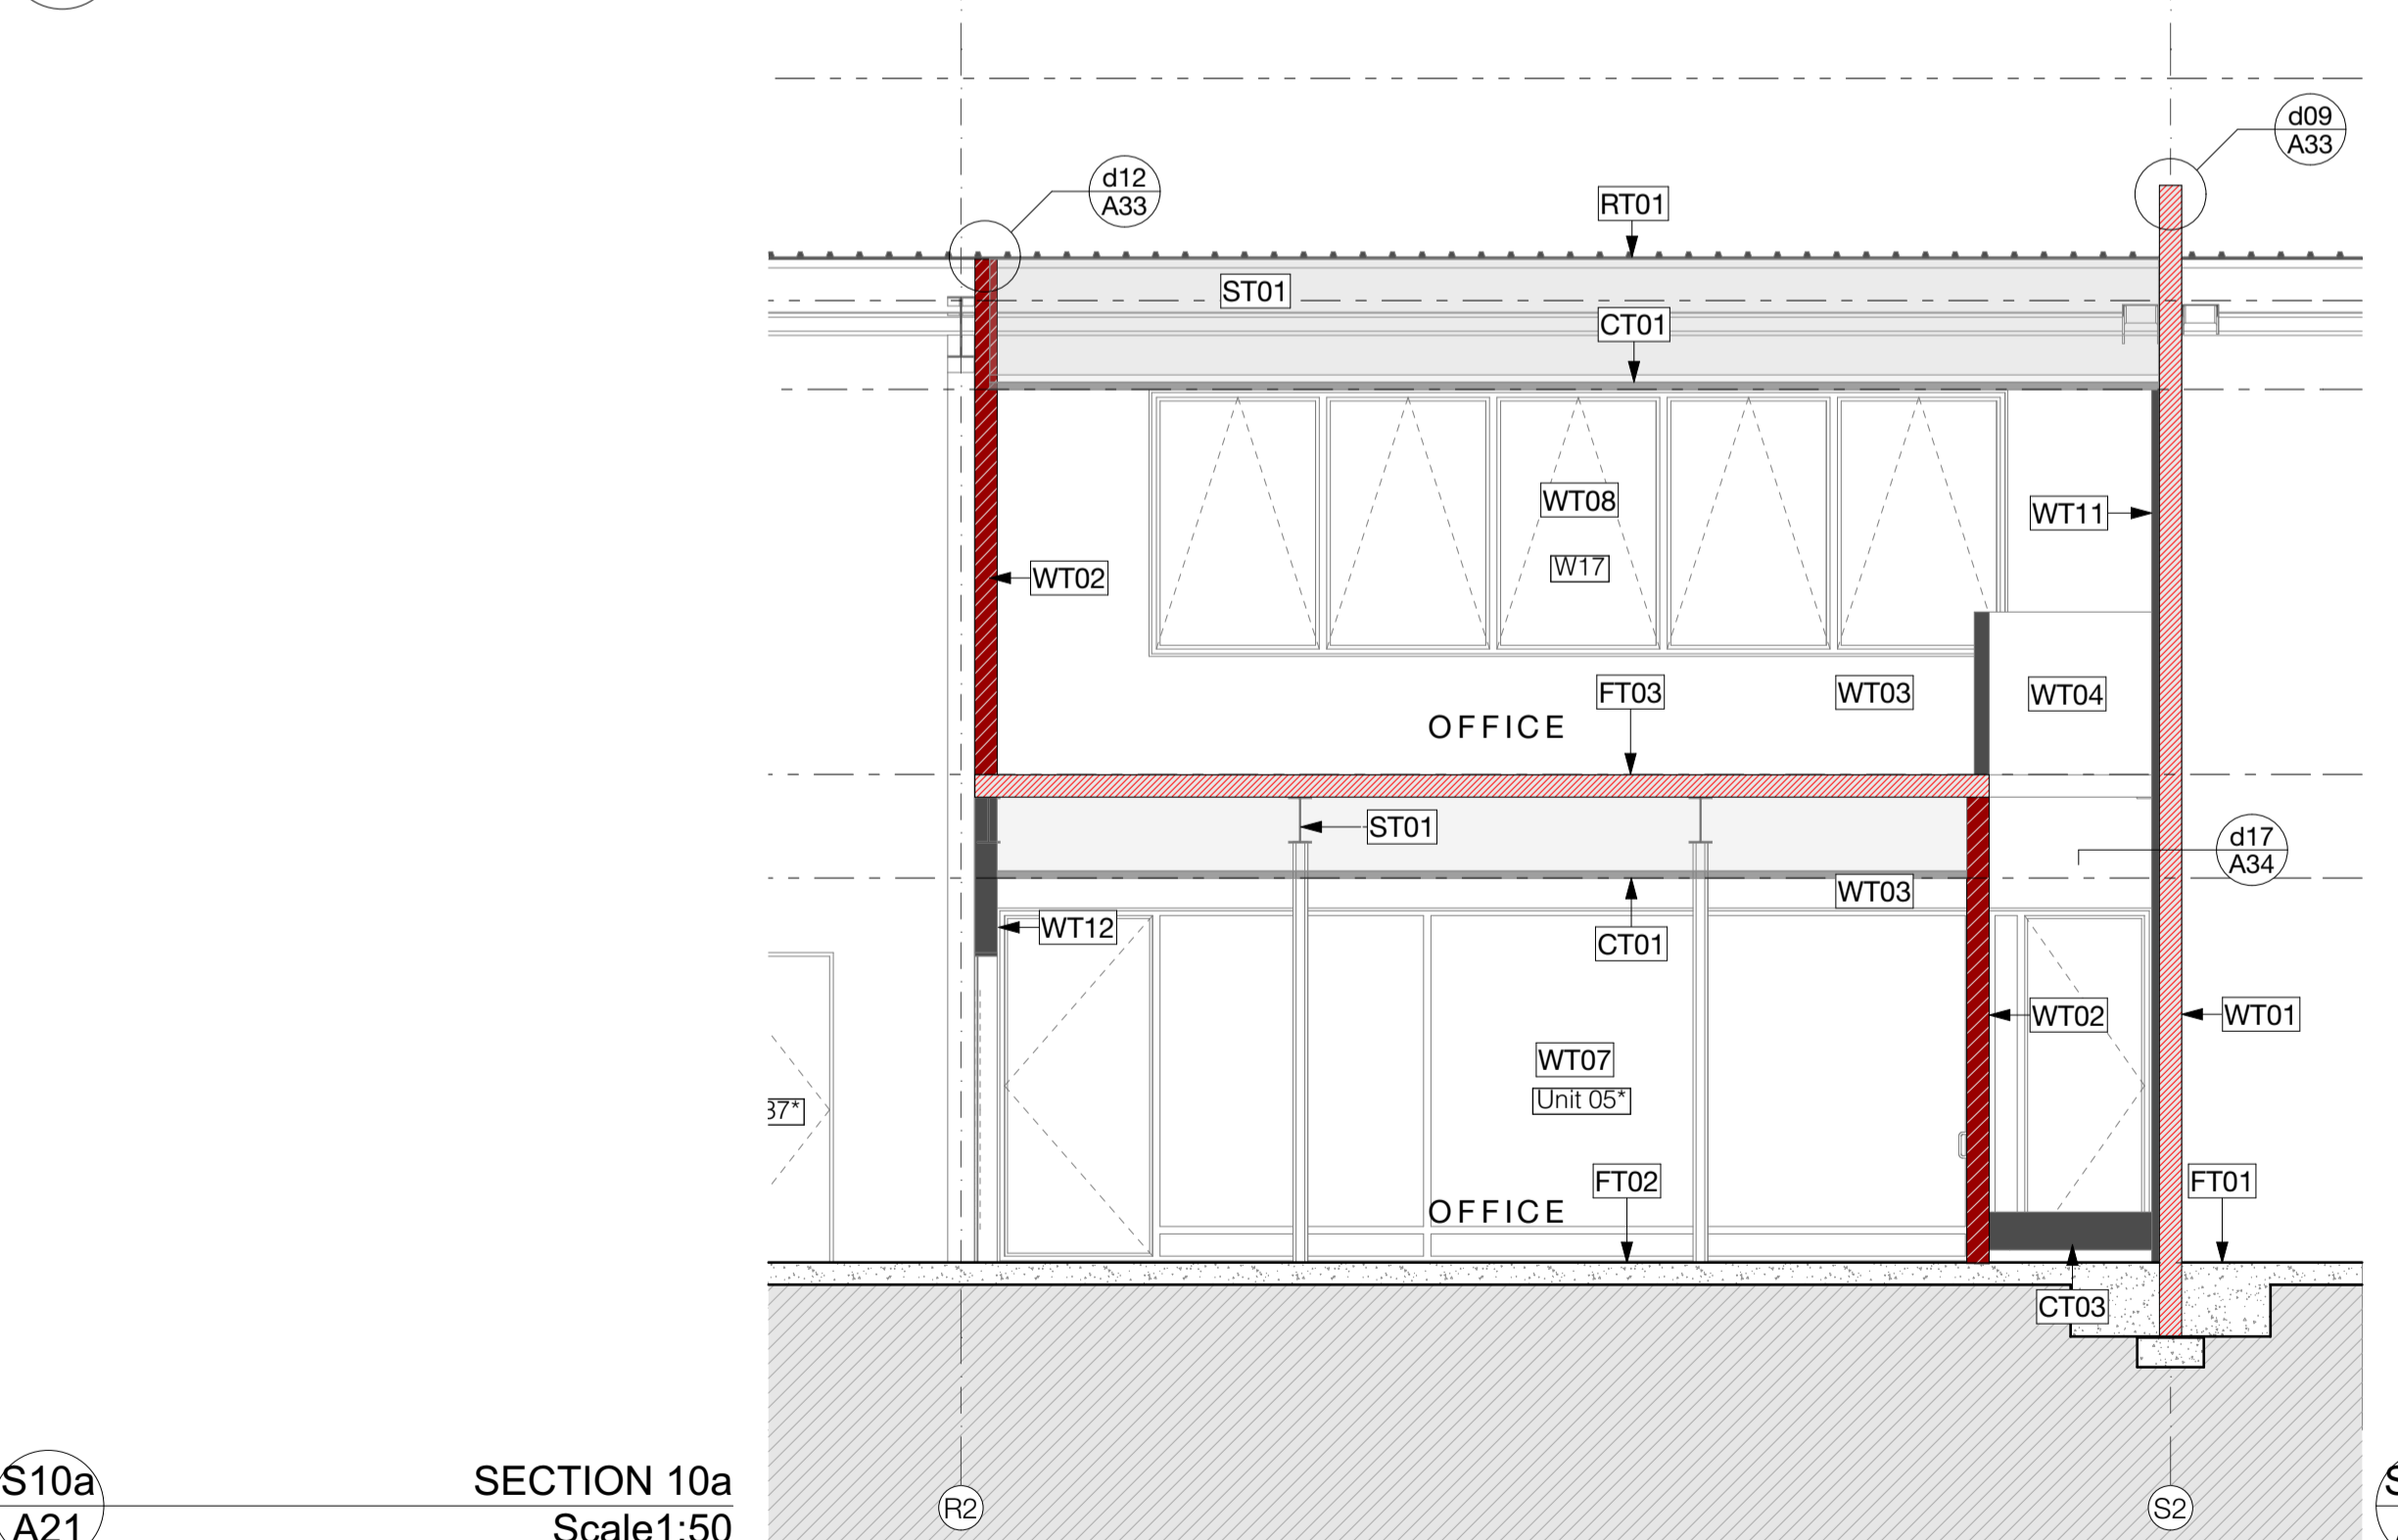

S10a A21 SECTION 10a Scale:1:50

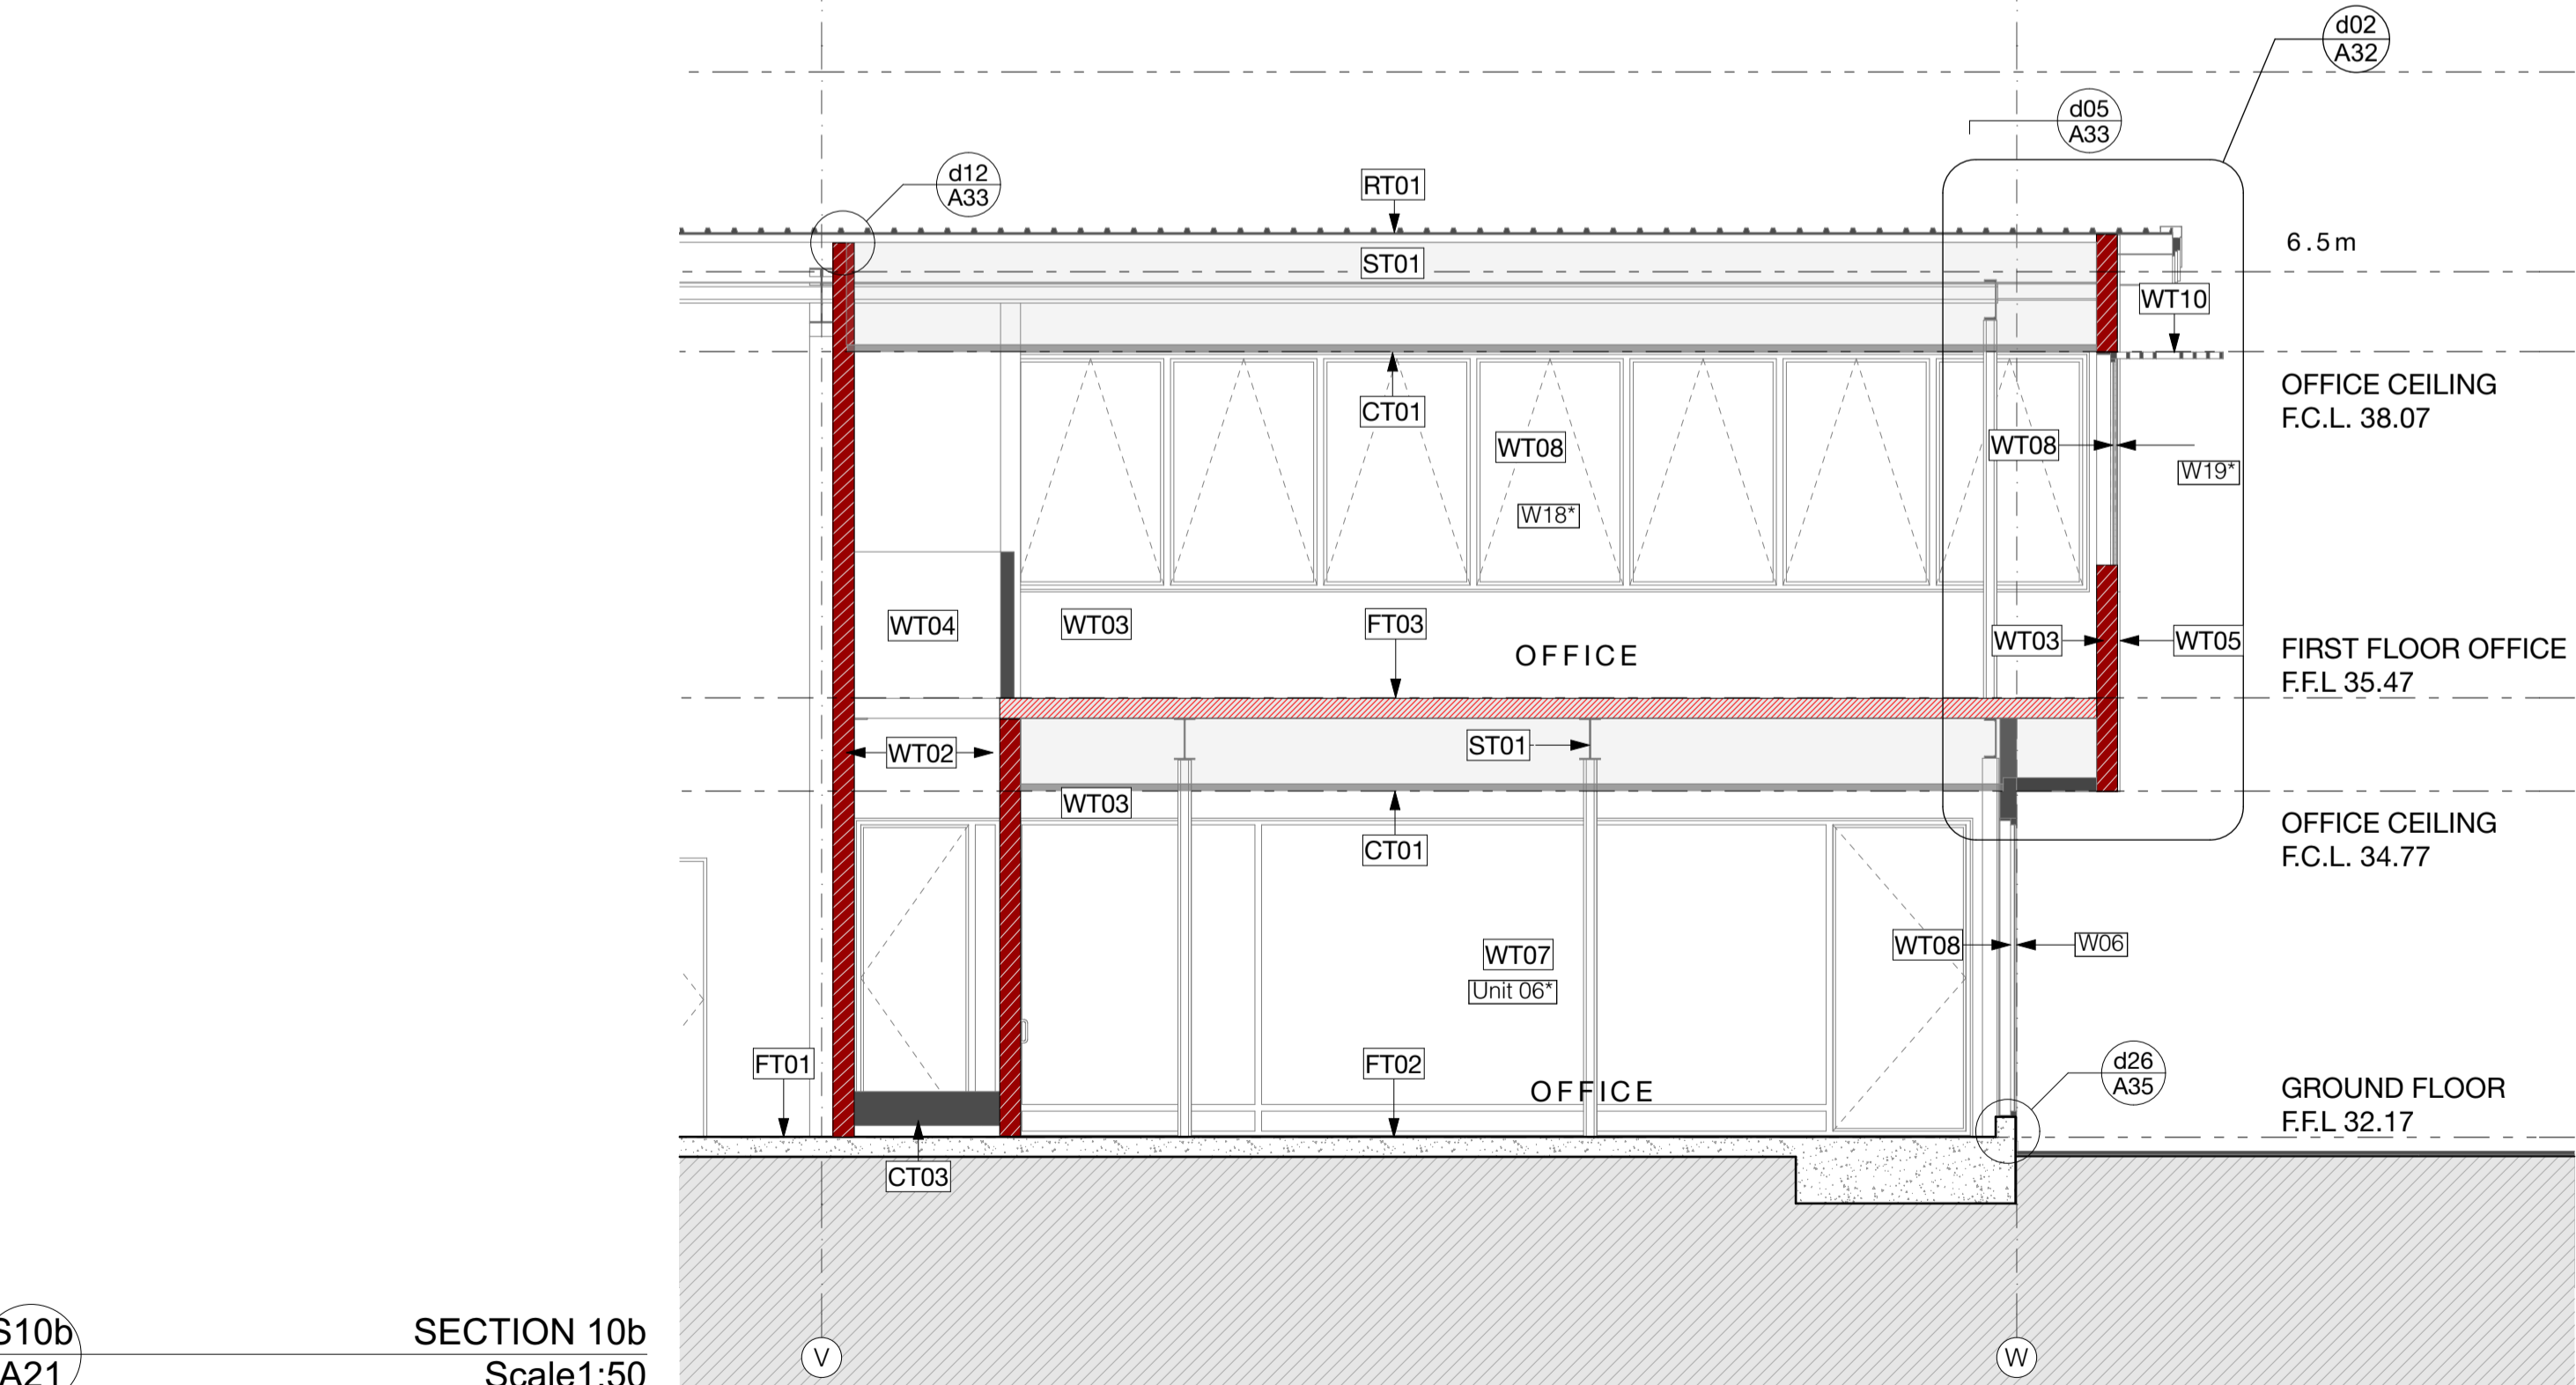

S10b A21 SECTION 10b Scale:1:50

FOR CONSTRUCTION ISSUE


NOTE:
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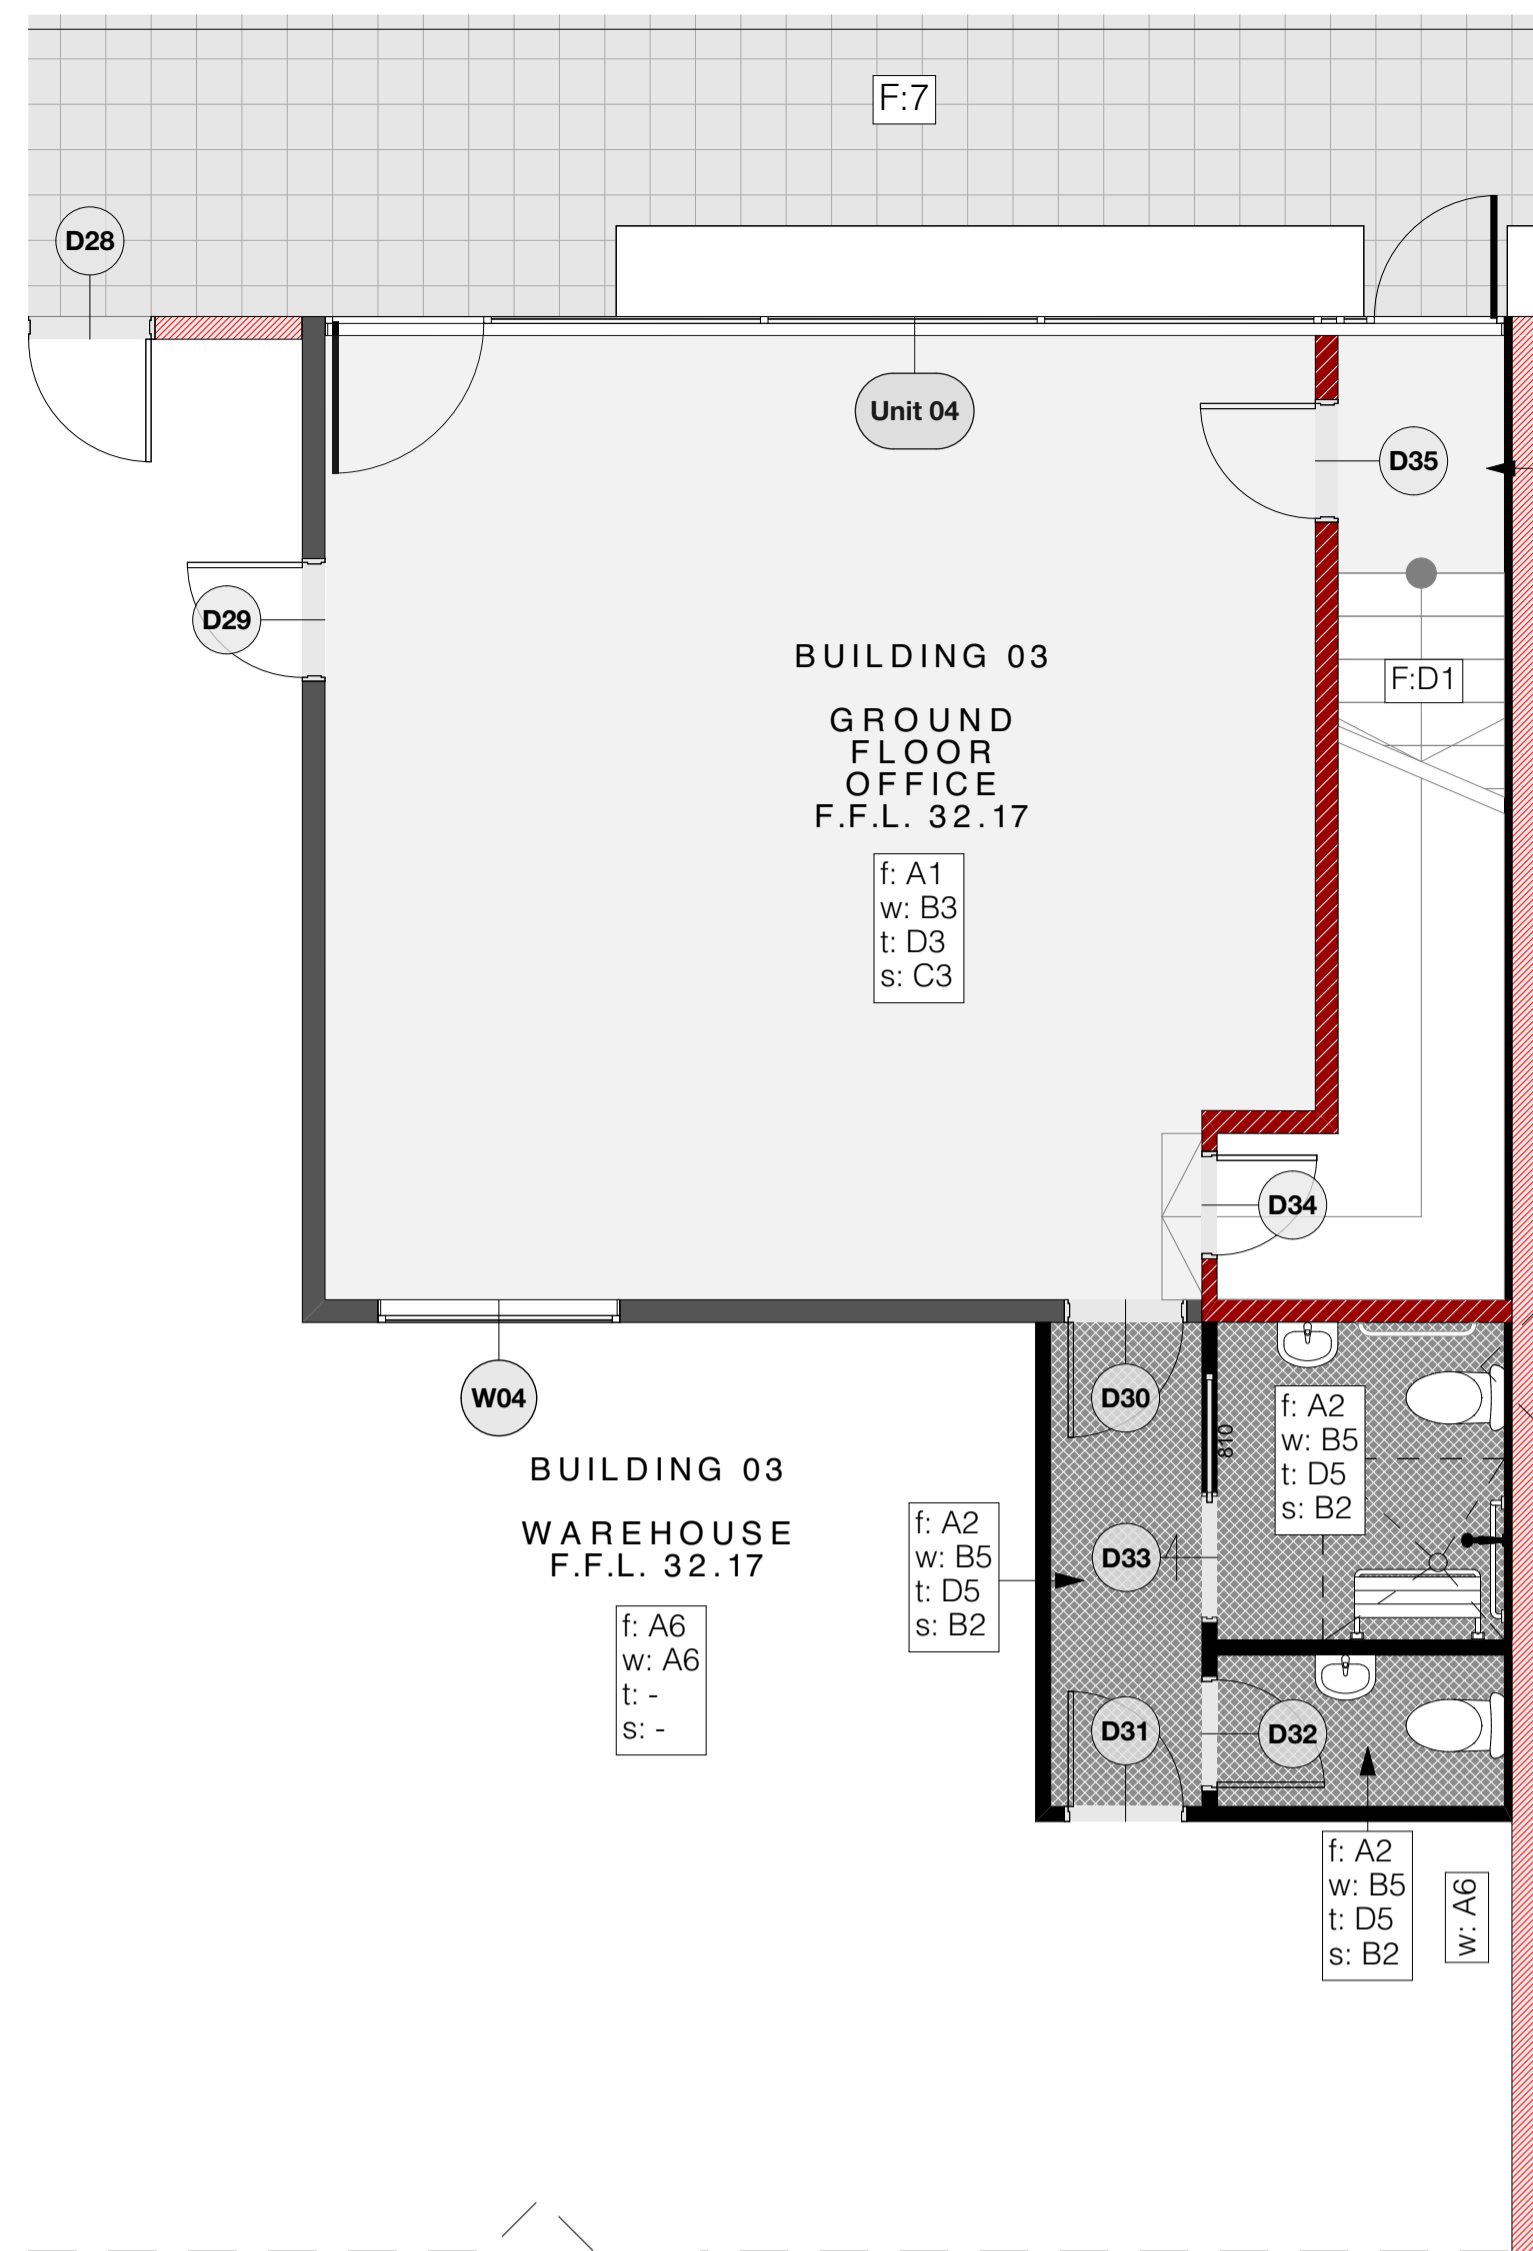


PROJECT: Te Rapa Stage 2


CLIENT: Fosters Construction
SITE: Te Rapa Industrial Park, Hamilton

DRAWING TITLE: PROPOSED LONG SECTIONS


PROJECT REF: T0424 TE RAPA S2	
DATE: 25/06/19	SCALE: 1:50, 1:100 @ A1
SHEET: A21	REV: C01

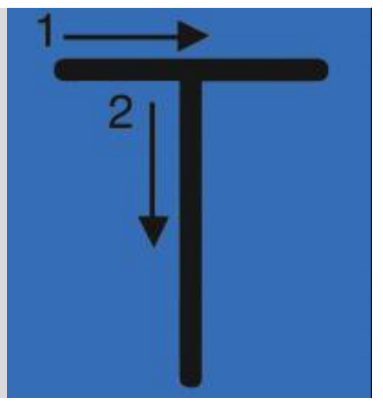

PROPOSED GROUND FINISHES PLAN - BUILDING 03
SCALE 1:50 @ A1

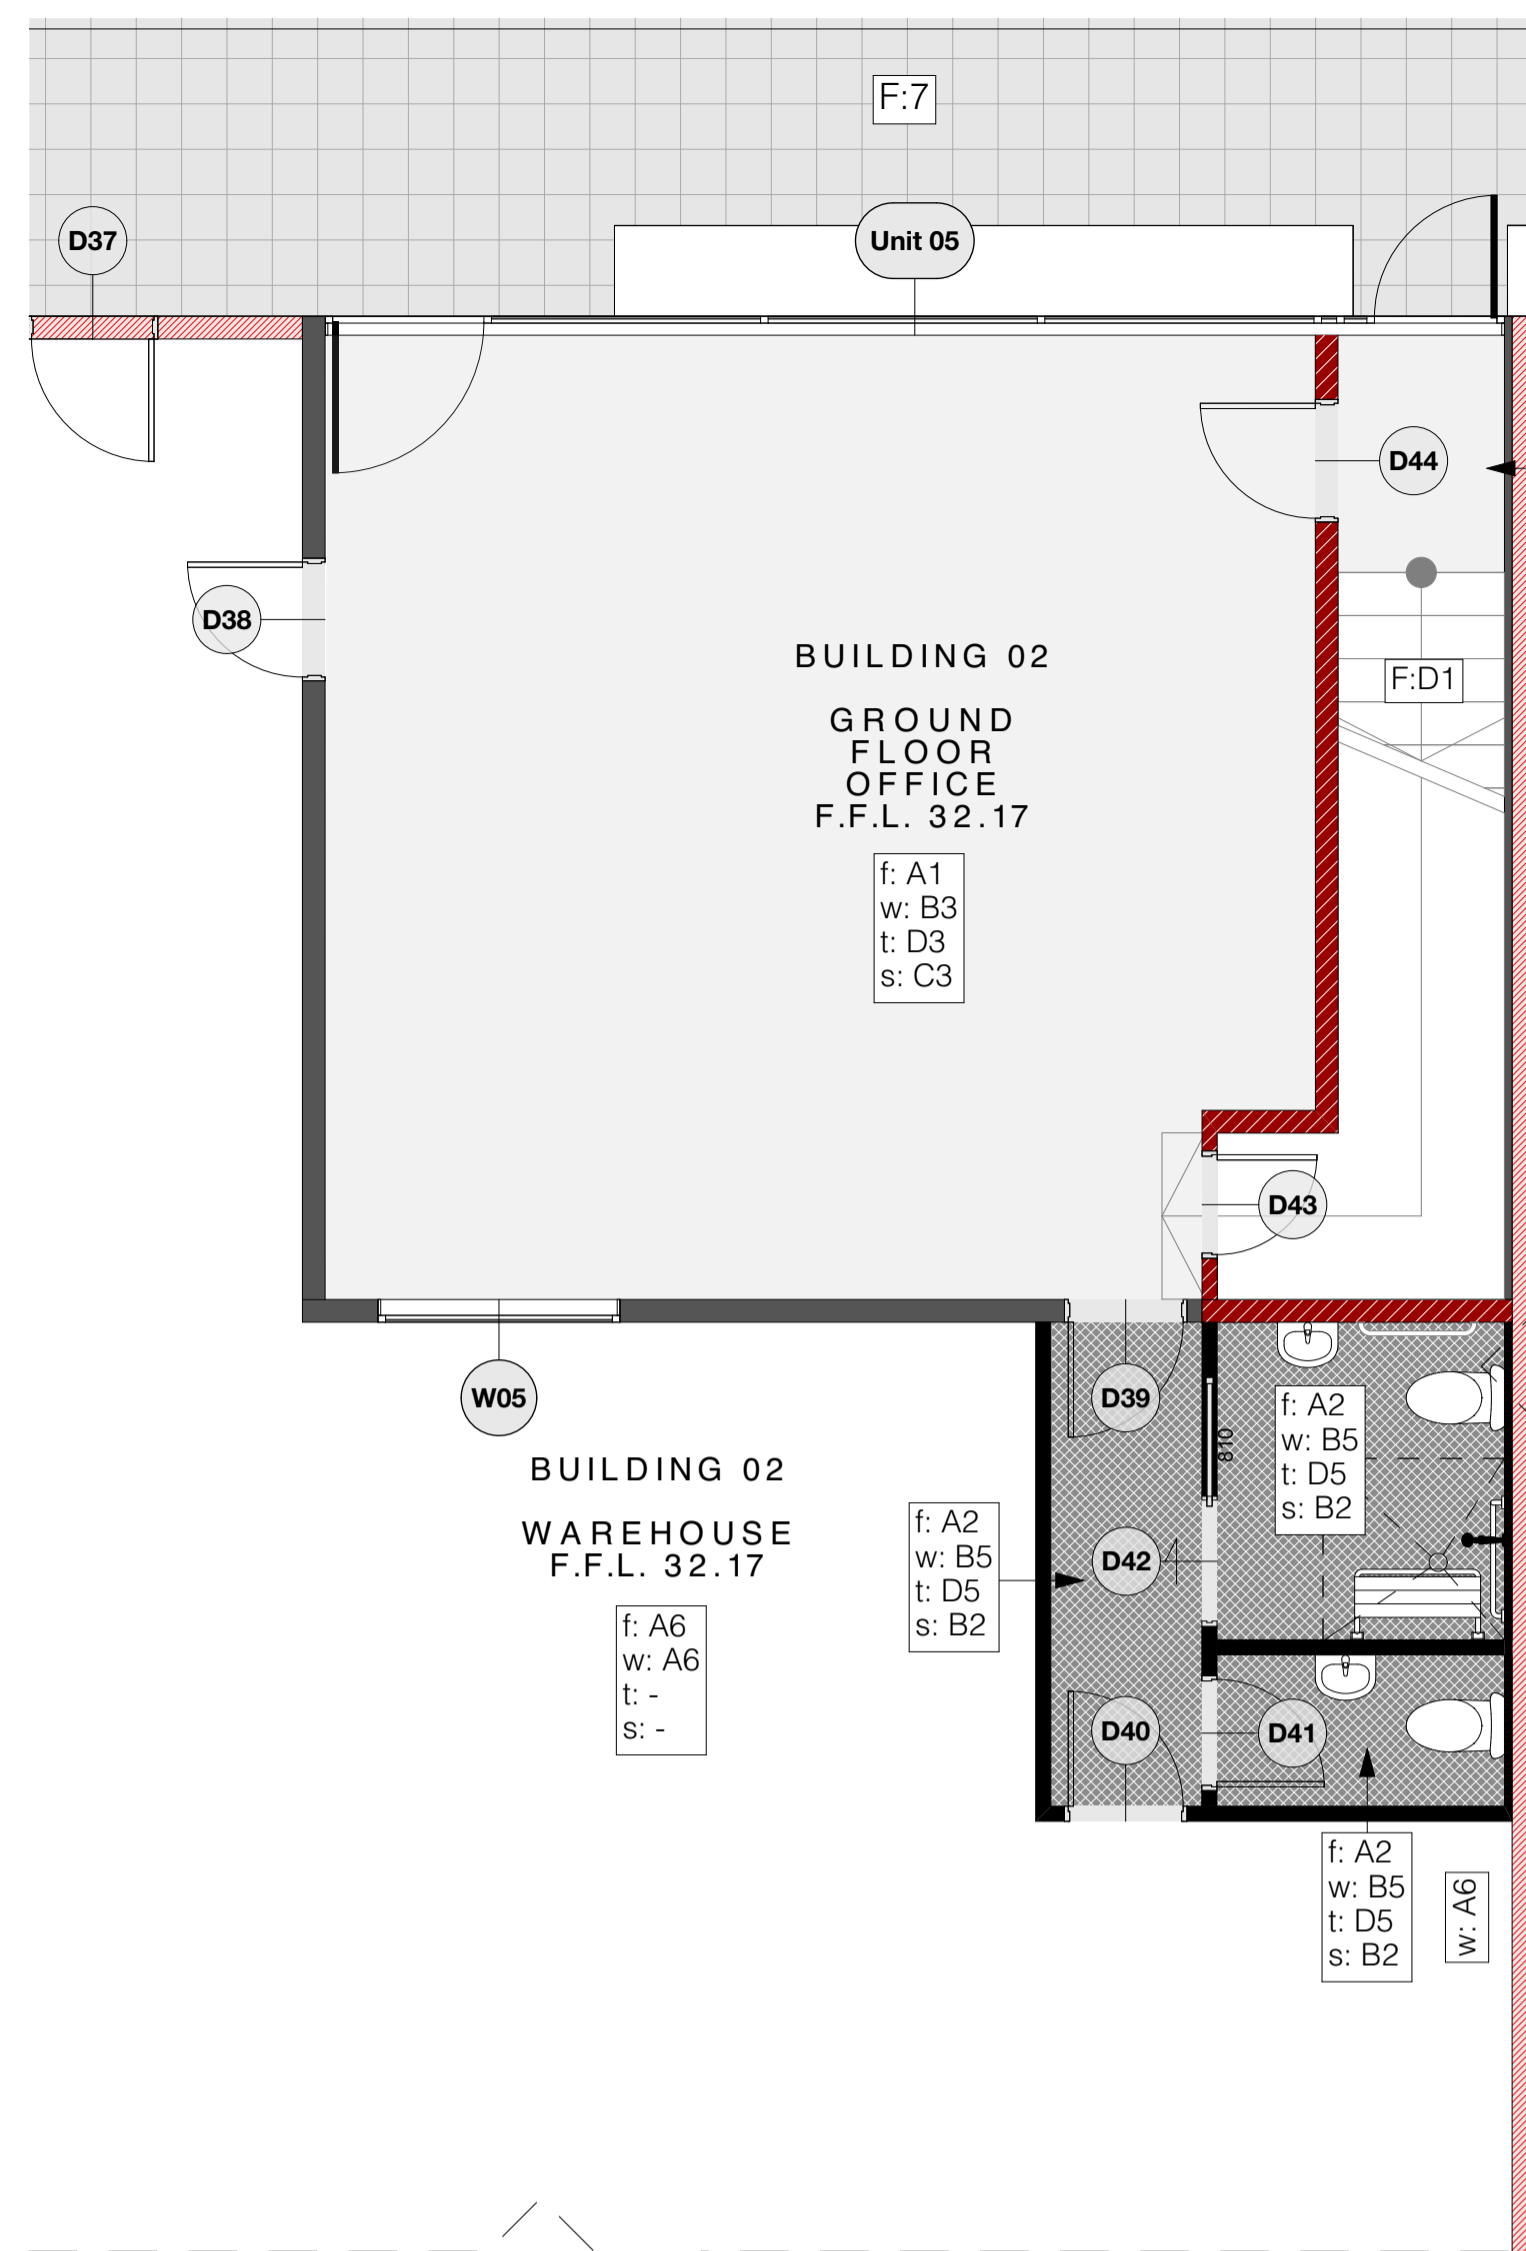

PROPOSED GROUND FINISHES PLAN - BUILDING 02
SCALE 1:50 @ A1

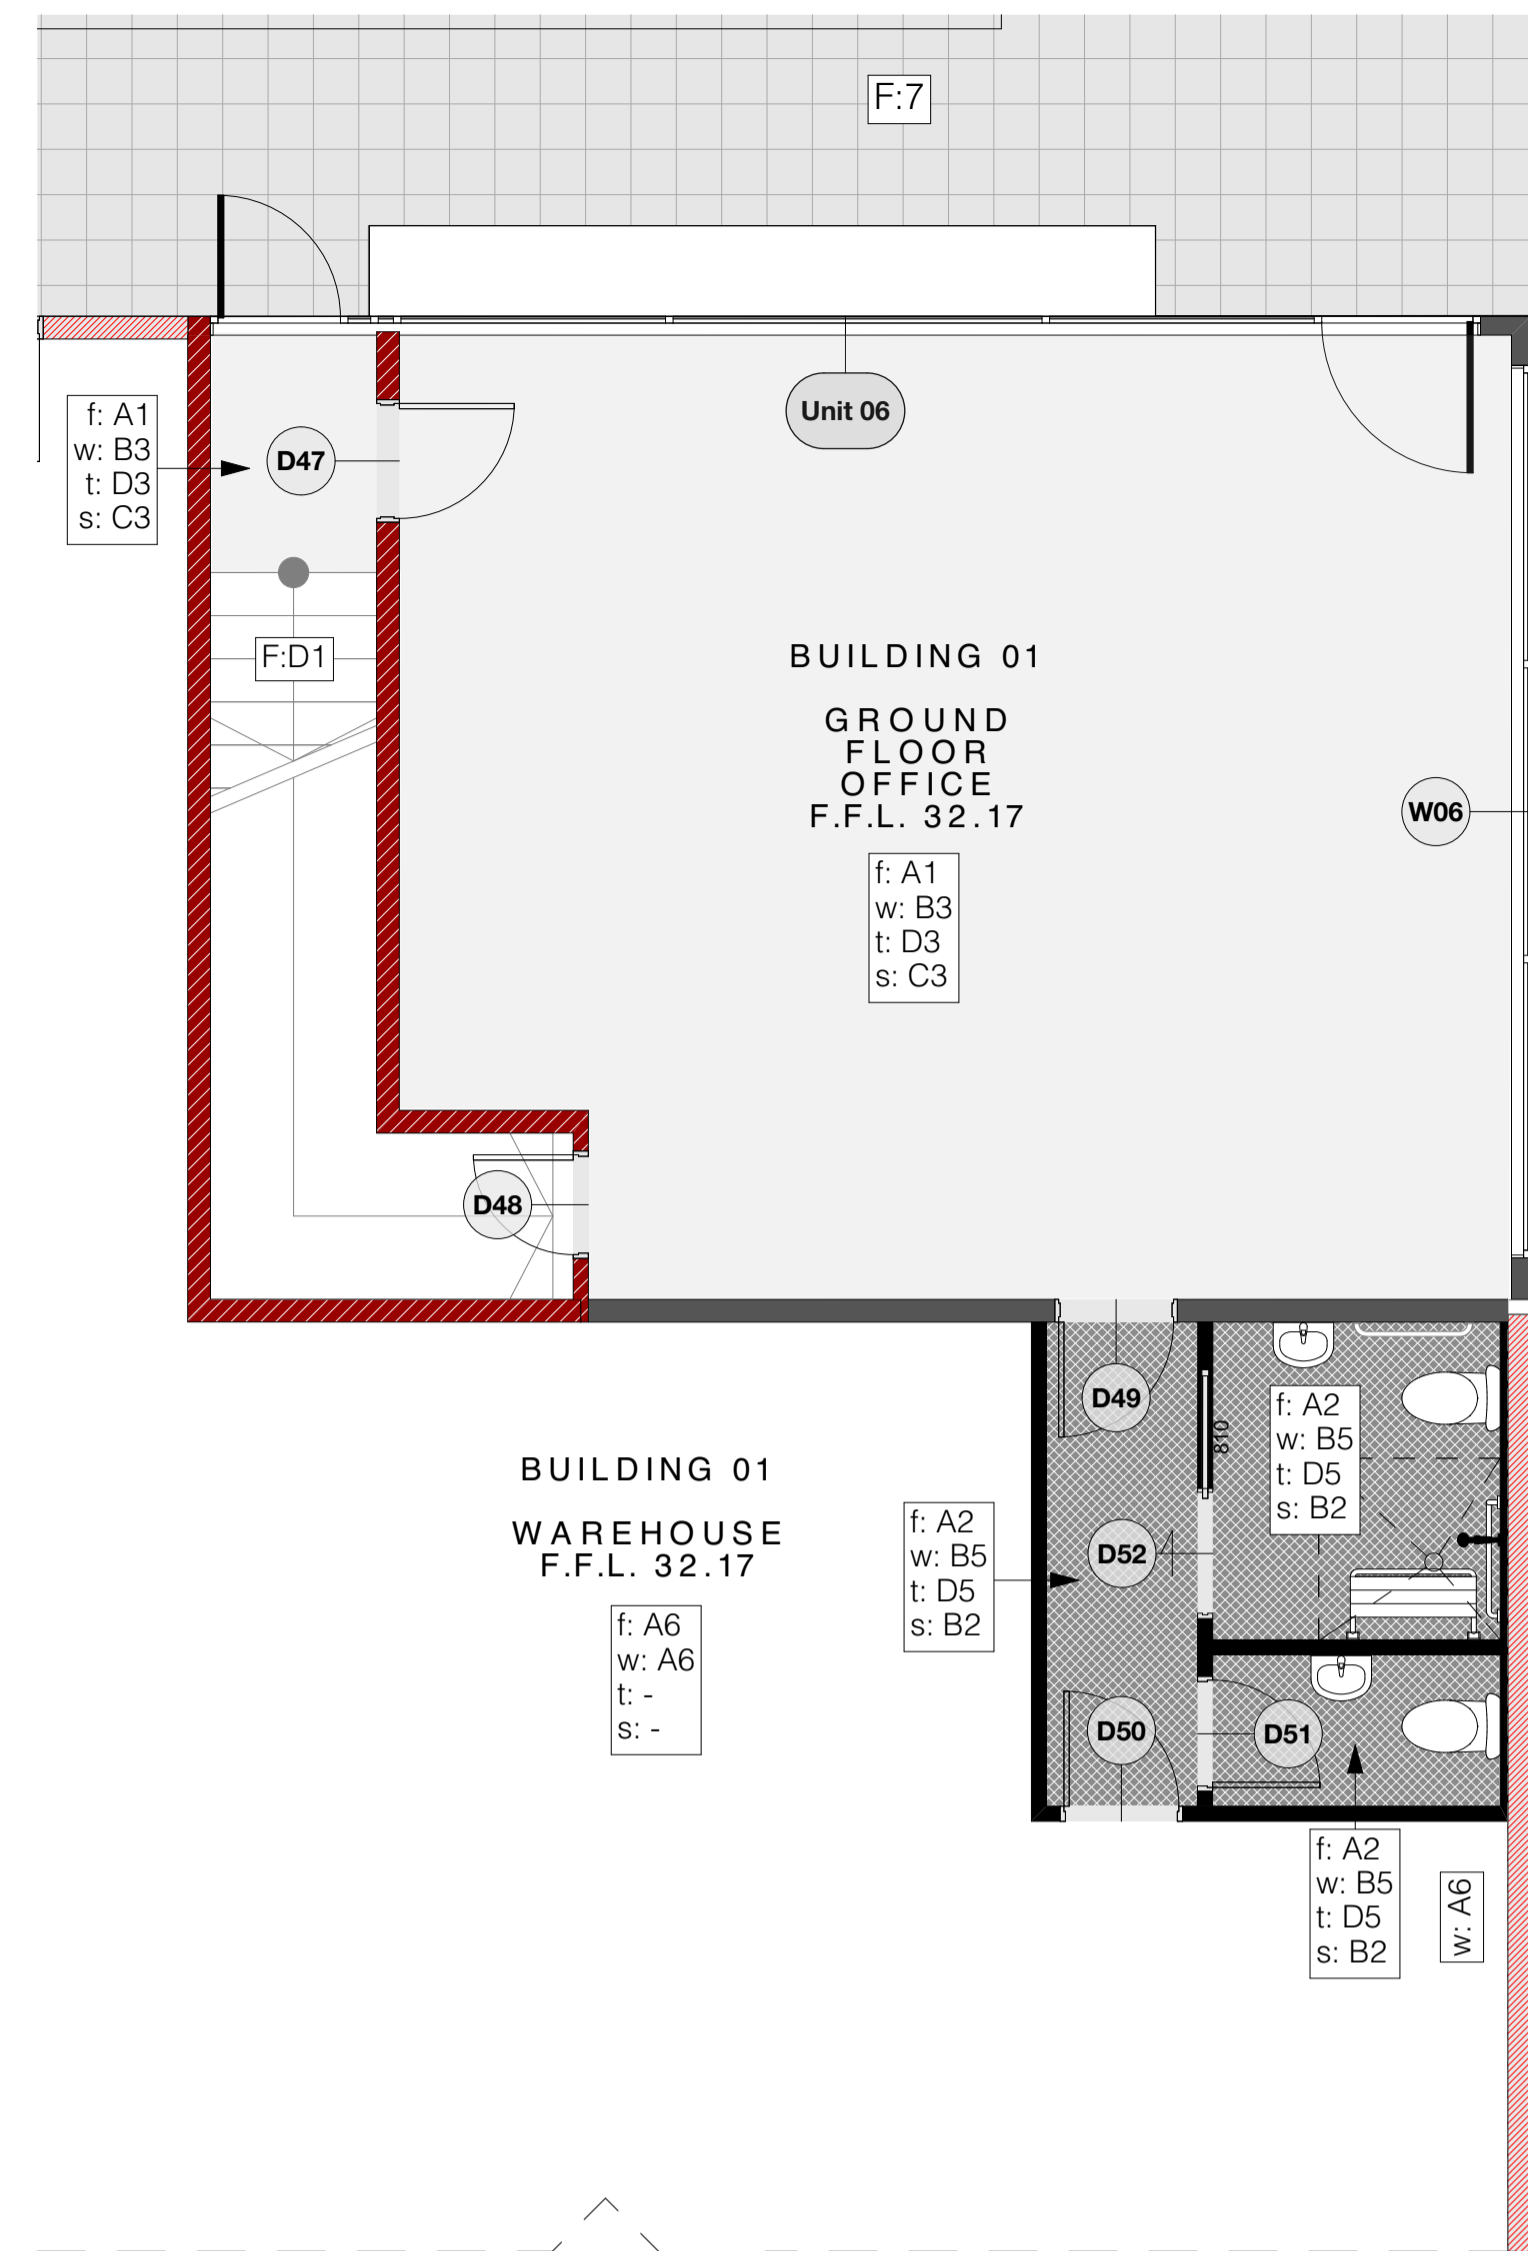

PROPOSED GROUND FINISHES PLAN - BUILDING 01
SCALE 1:50 @ A1

FINISHES KEY


Elements:
 f - floor
 w - walls
 s - skirting
 t - trims / doors / door frames

Substrate:
 A - concrete
 B - GIB Standard or Aqualine level 4 stopped
 C - 60x12 single bevel timber
 D - timber


Finish:

- selected commercial grade carpet tile
- commercial grade vinyl
- interior plaster board walls: 1 coat waterborne sealer undercoat, 2 coats waterborne low sheen.
- interior plaster board ceilings: 1 coat waterborne sealer undercoat, 2 coats waterborne low sheen.
- bathroom plaster board walls / ceilings: 1 coat waterborne sealer undercoat, 2 coats waterborne low sheen - refer specification for all specified paint.
no further finish
- in-situ pavement on sand base installed to manufacturers specification.


NOTE:
 all bathroom / wet room skirting finished with vinyl covering and timber trim with paint finish. refer bathroom details.

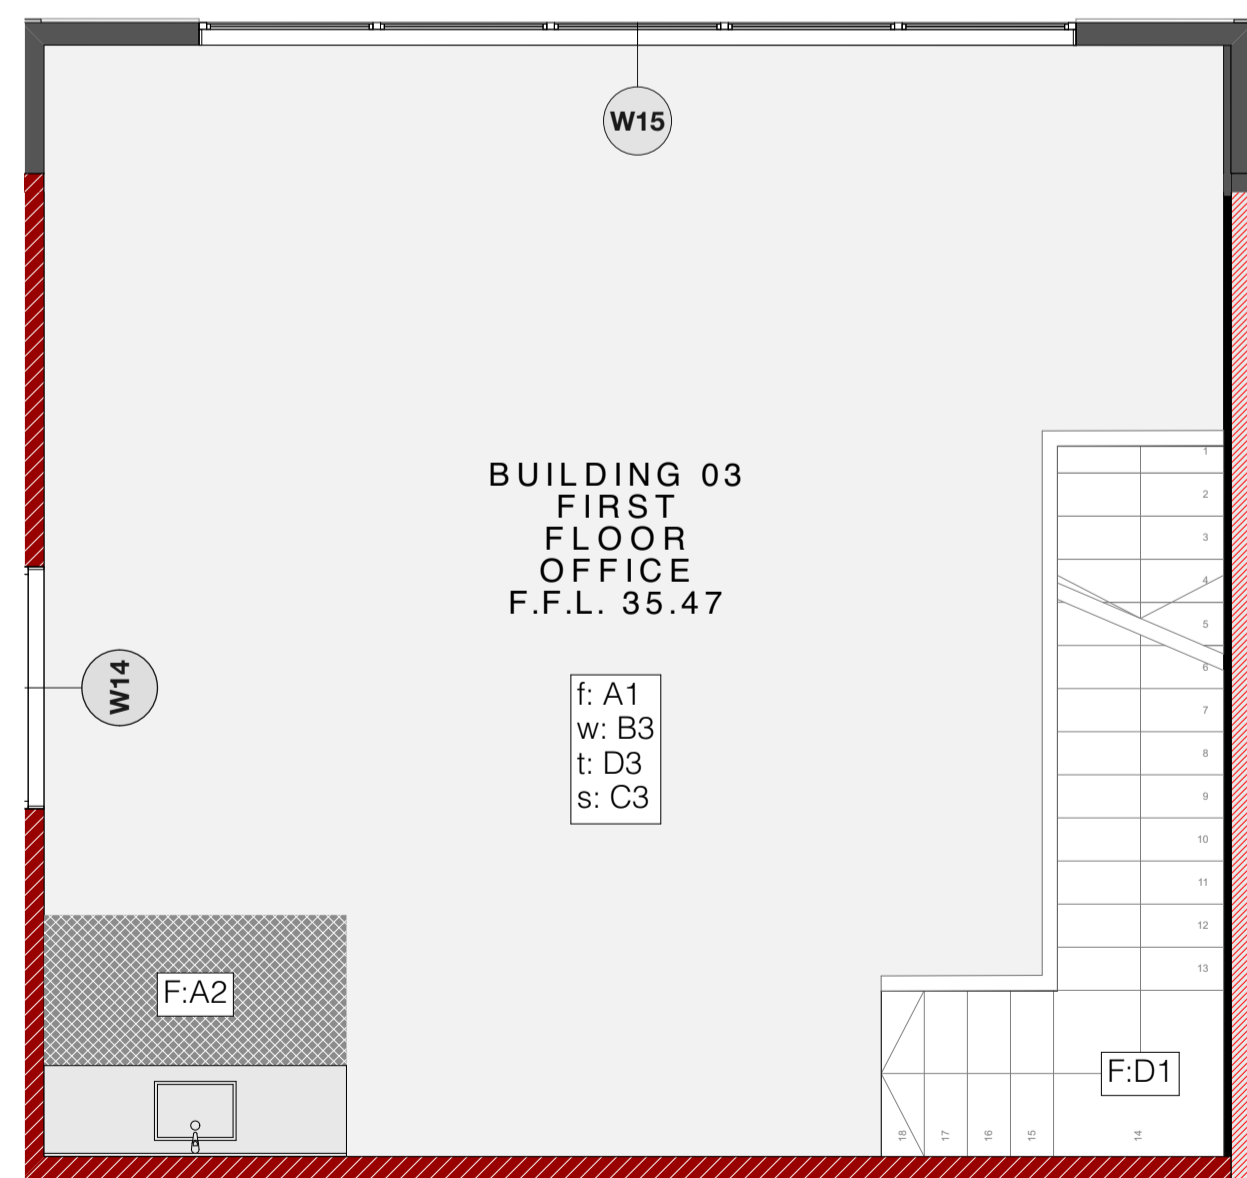

PROPOSED FIRST FINISHES PLAN - BUILDING 03
SCALE 1:50 @ A1

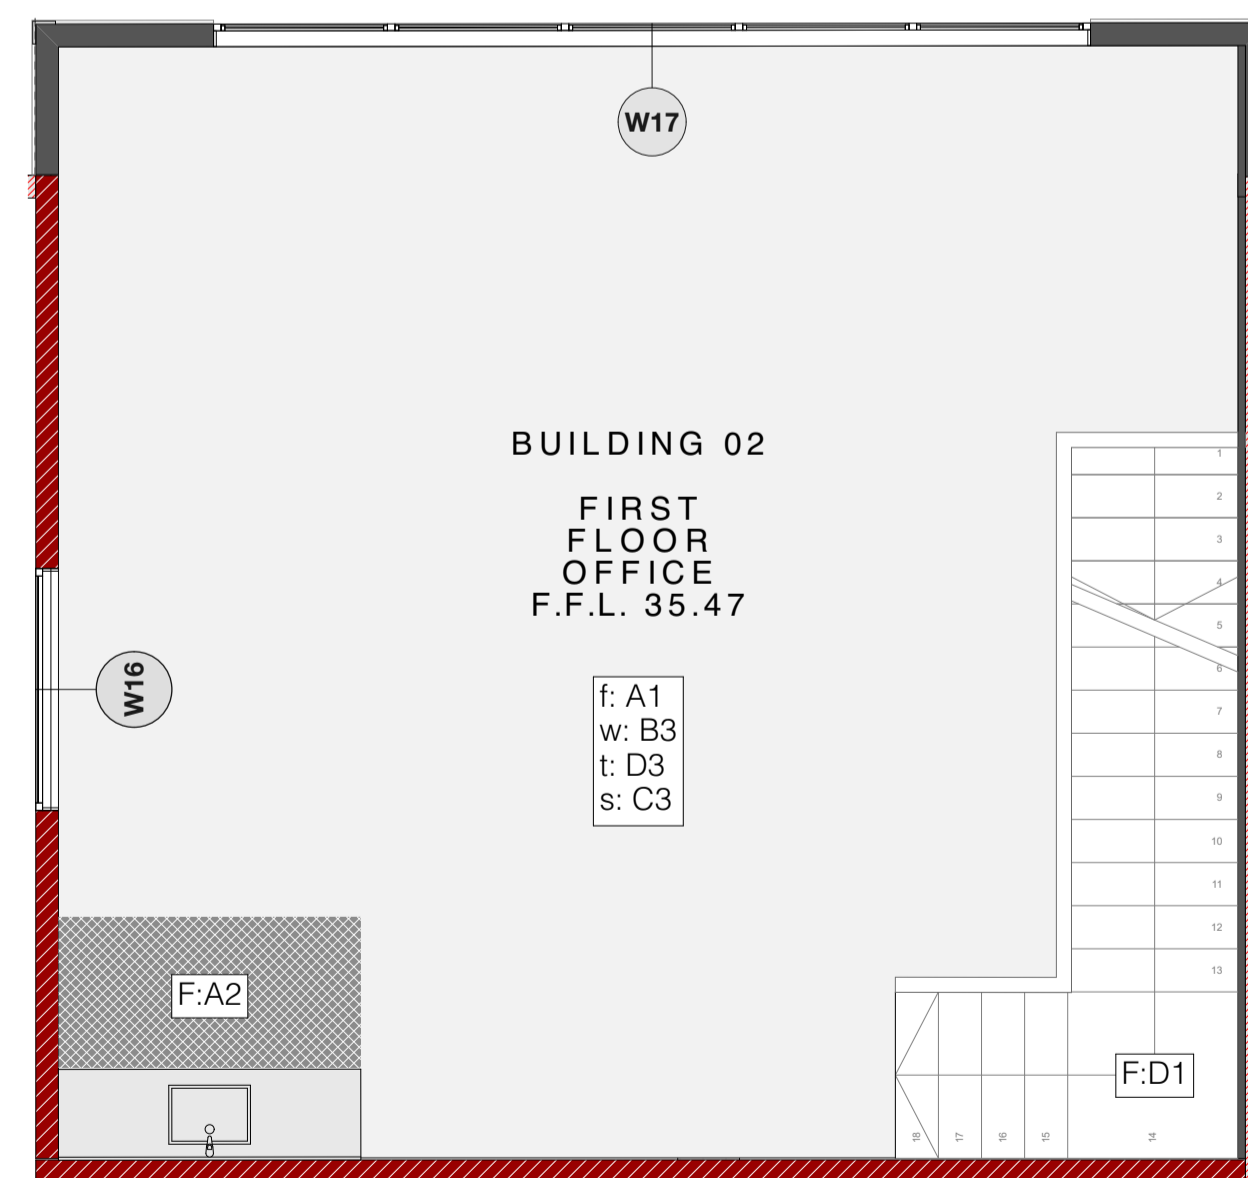

PROPOSED FIRST FINISHES PLAN - BUILDING 02
SCALE 1:50 @ A1

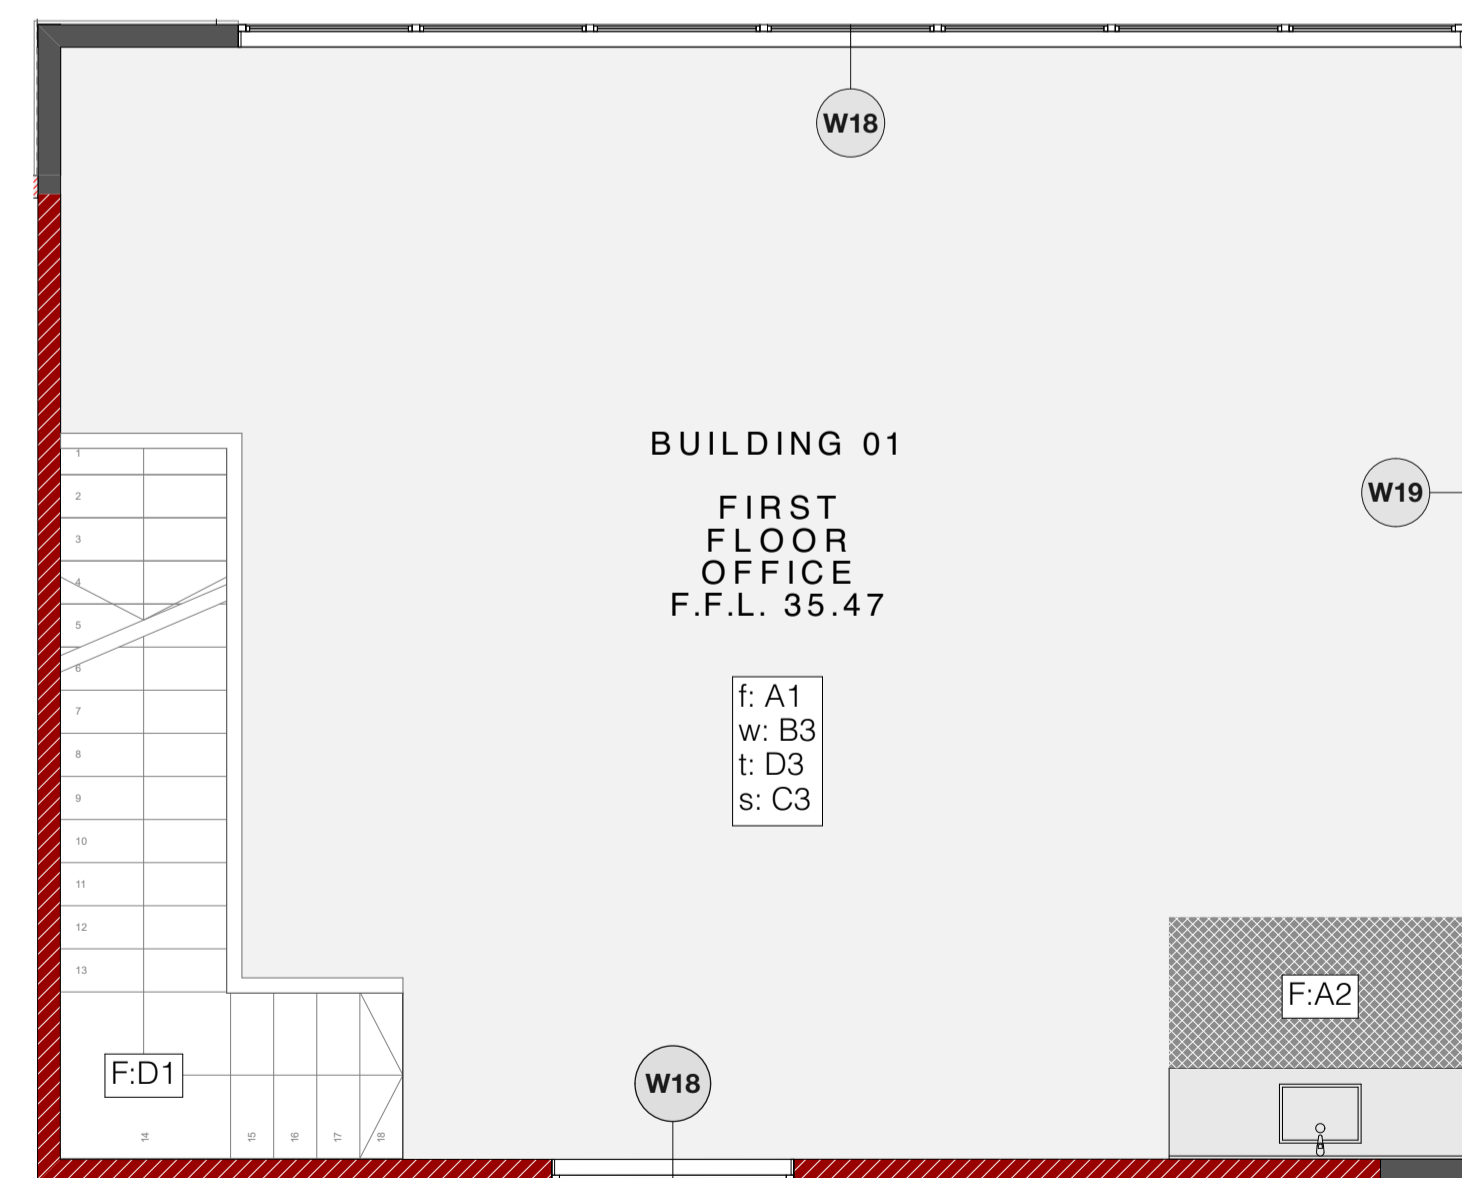

PROPOSED FIRST FINISHES PLAN - BUILDING 01
SCALE 1:50 @ A1

FOR CONSTRUCTION ISSUE

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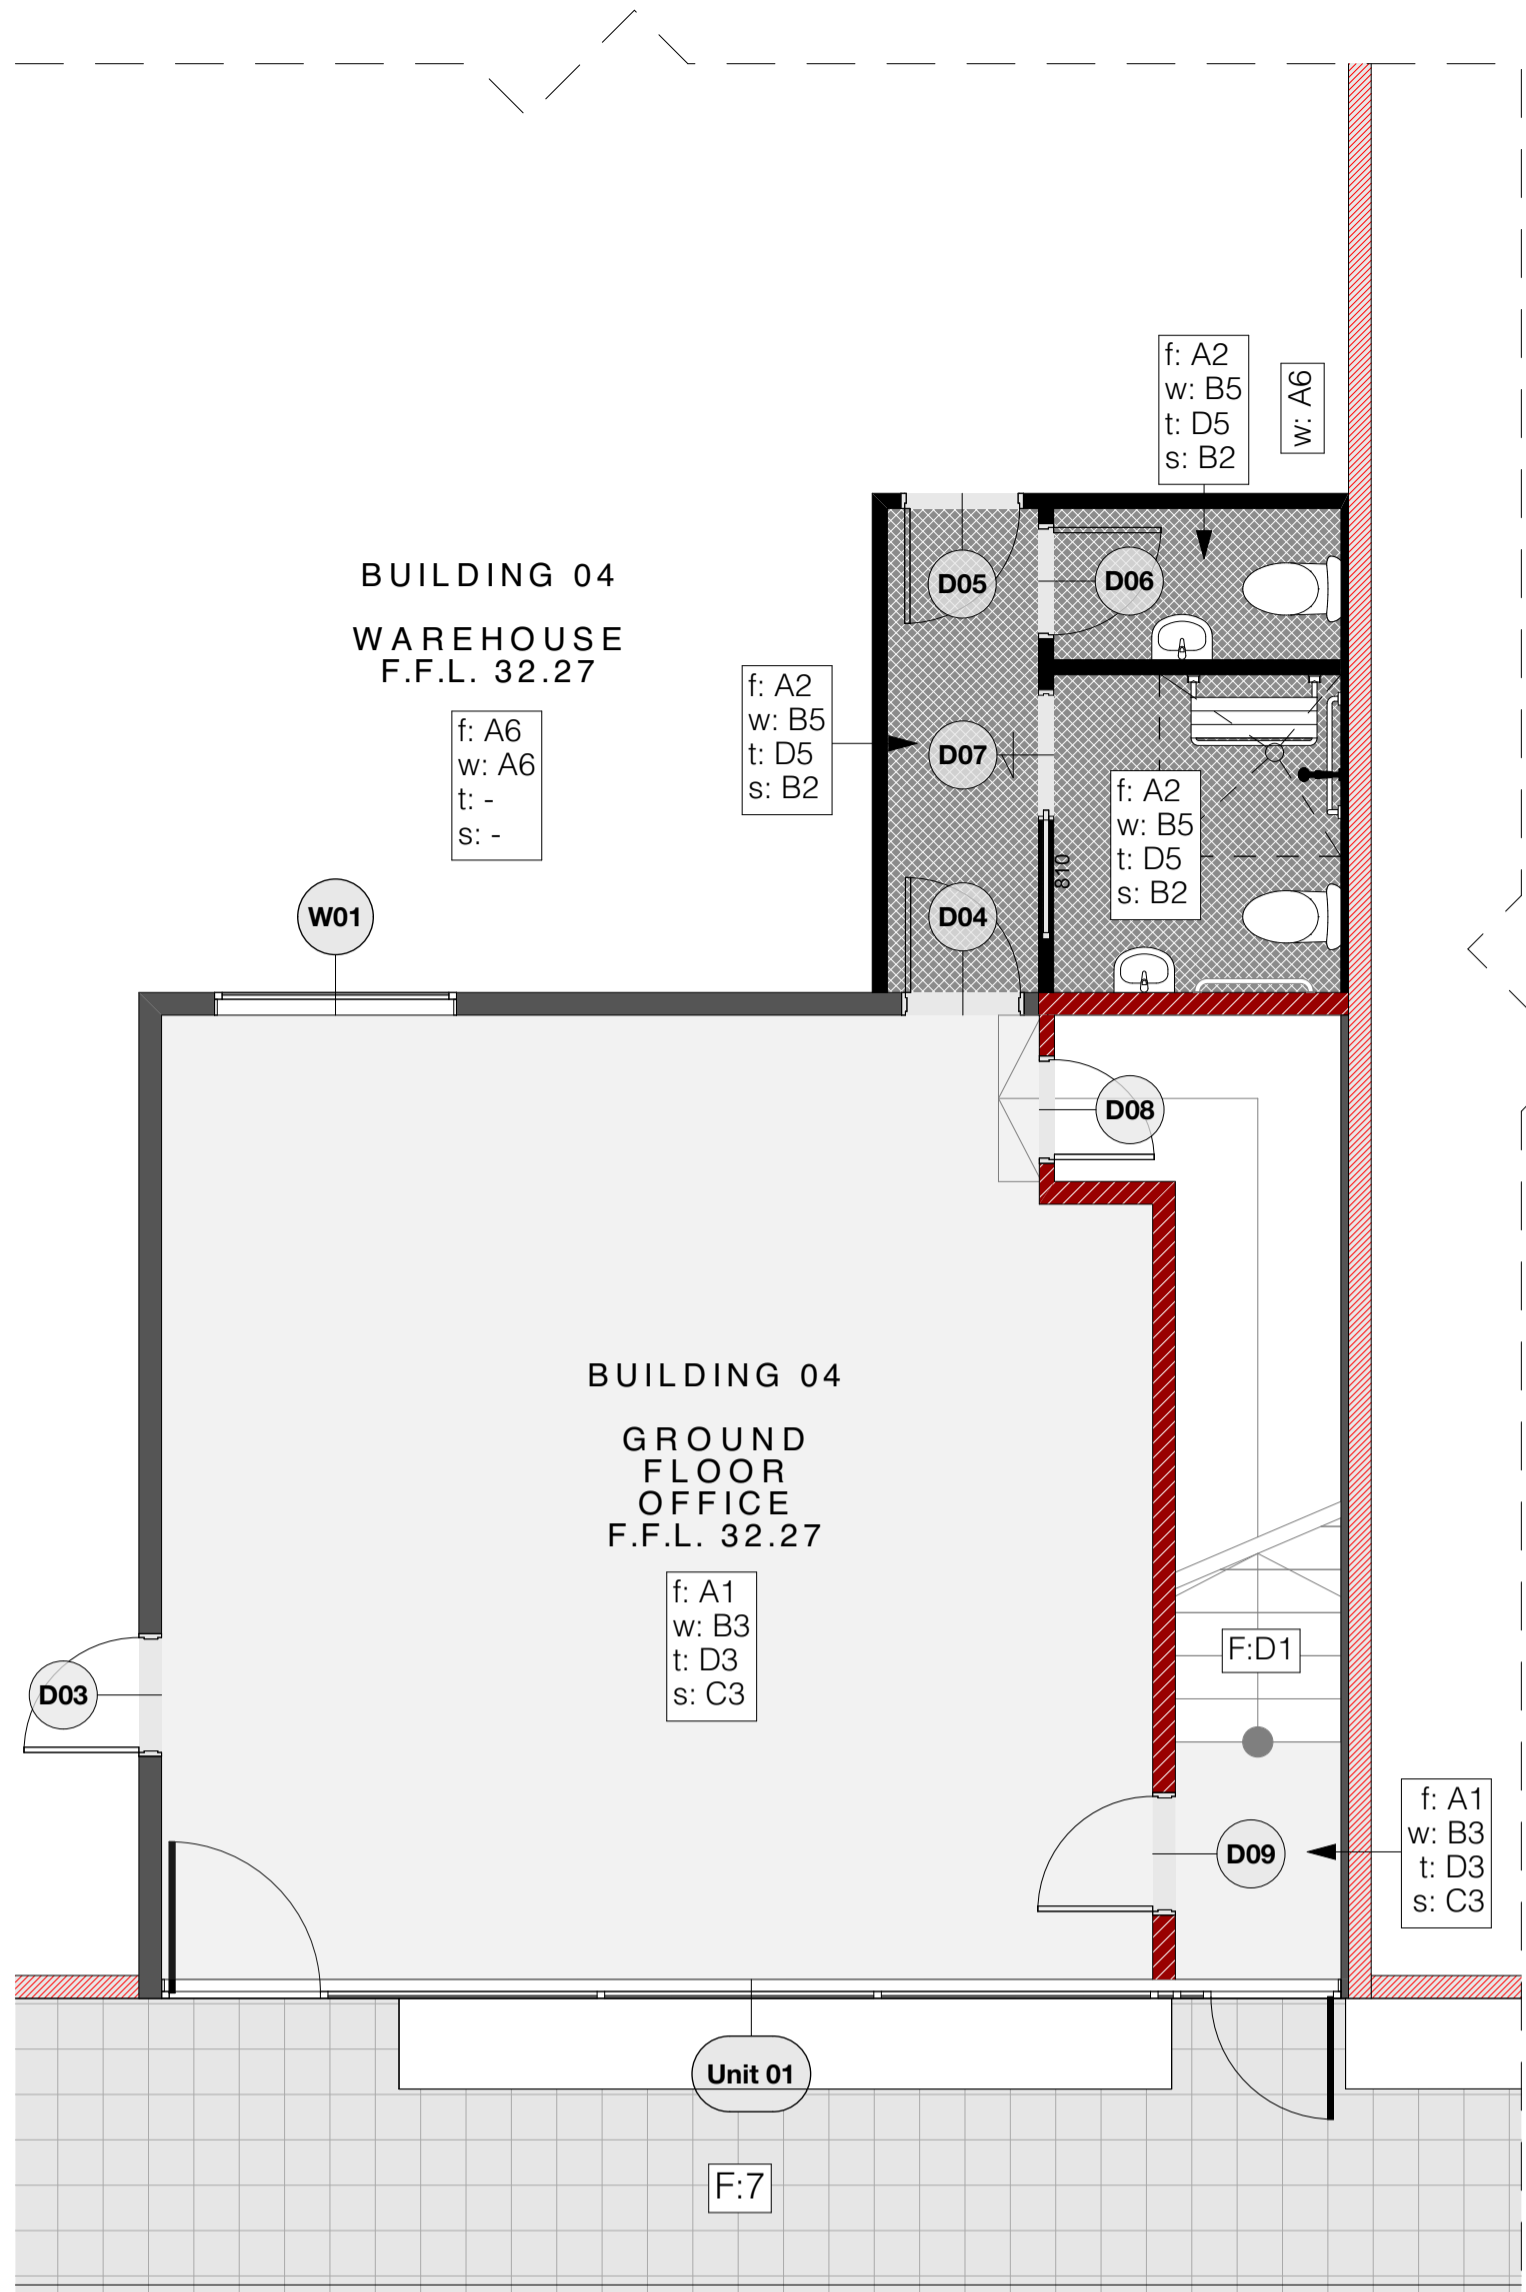
CLIENT: Fosters Construction
SITE: Te Rapa Industrial Park, Hamilton

DRAWING TITLE:
 PROPOSED FLOOR FINISHES - BUILDINGS 01-03


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DATE: 25/06/19	SCALE: 1:50 @ A1
SHEET: A22	REV: C01

FINISHES KEY


- Elements:**
 f - floor
 w - walls
 s - skirting
 t - trims / doors / door frames
- Substrate:**
 A - concrete
 B - GIB Standard or Aqualine level 4 stopped
 C - 60x12 single bevel timber
 D - timber
- Finish:**
- selected commercial grade carpet tile
 - commercial grade vinyl
 - interior plaster board walls: 1 coat waterborne sealer undercoat, 2 coats waterborne low sheen.
 - interior plaster board ceilings: 1 coat waterborne sealer undercoat, 2 coats waterborne low sheen.
 - bathroom plaster board walls / ceilings: 1 coat waterborne sealer undercoat, 2 coats waterborne low sheen - refer specification for all specified paint. no further finish
 - in-situ pavement on sand base installed to manufacturers specification.
- NOTE:**
 all bathroom / wet room skirting finished with vinyl covering and timber trim with paint finish. refer bathroom details.




PROPOSED GROUND FINISHES PLAN - BUILDING 04
 SCALE 1:50 @ A1

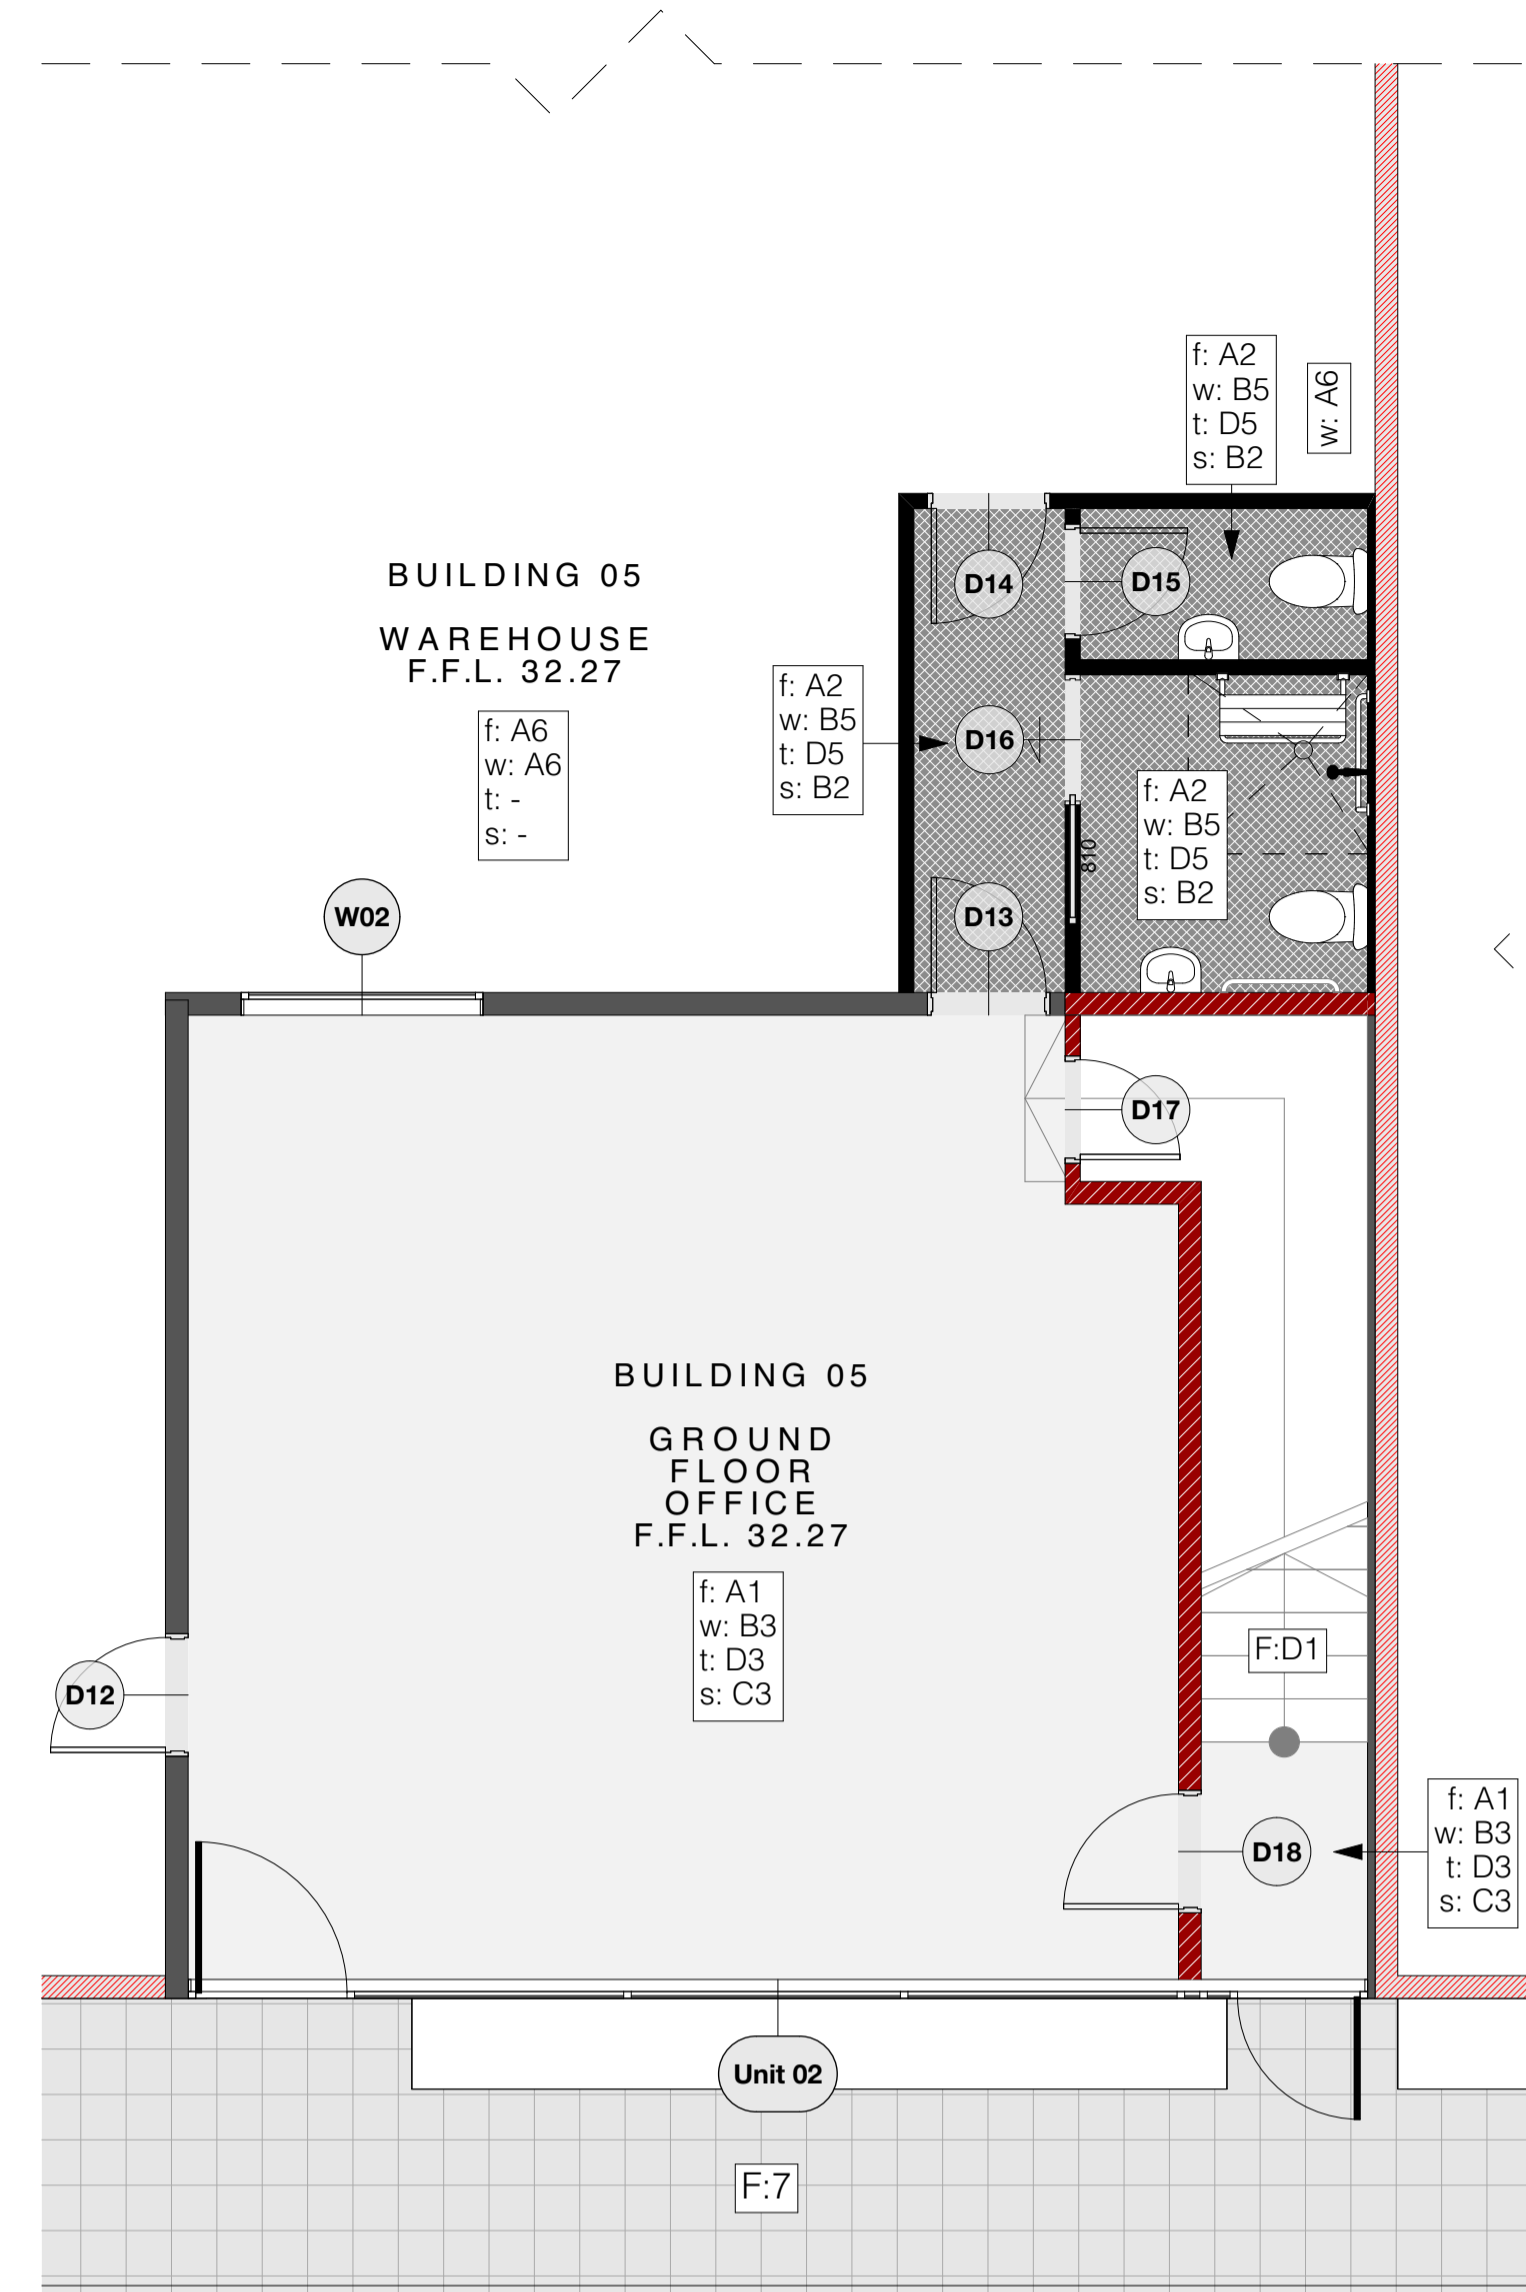


PROPOSED GROUND FINISHES PLAN - BUILDING 05
 SCALE 1:50 @ A1

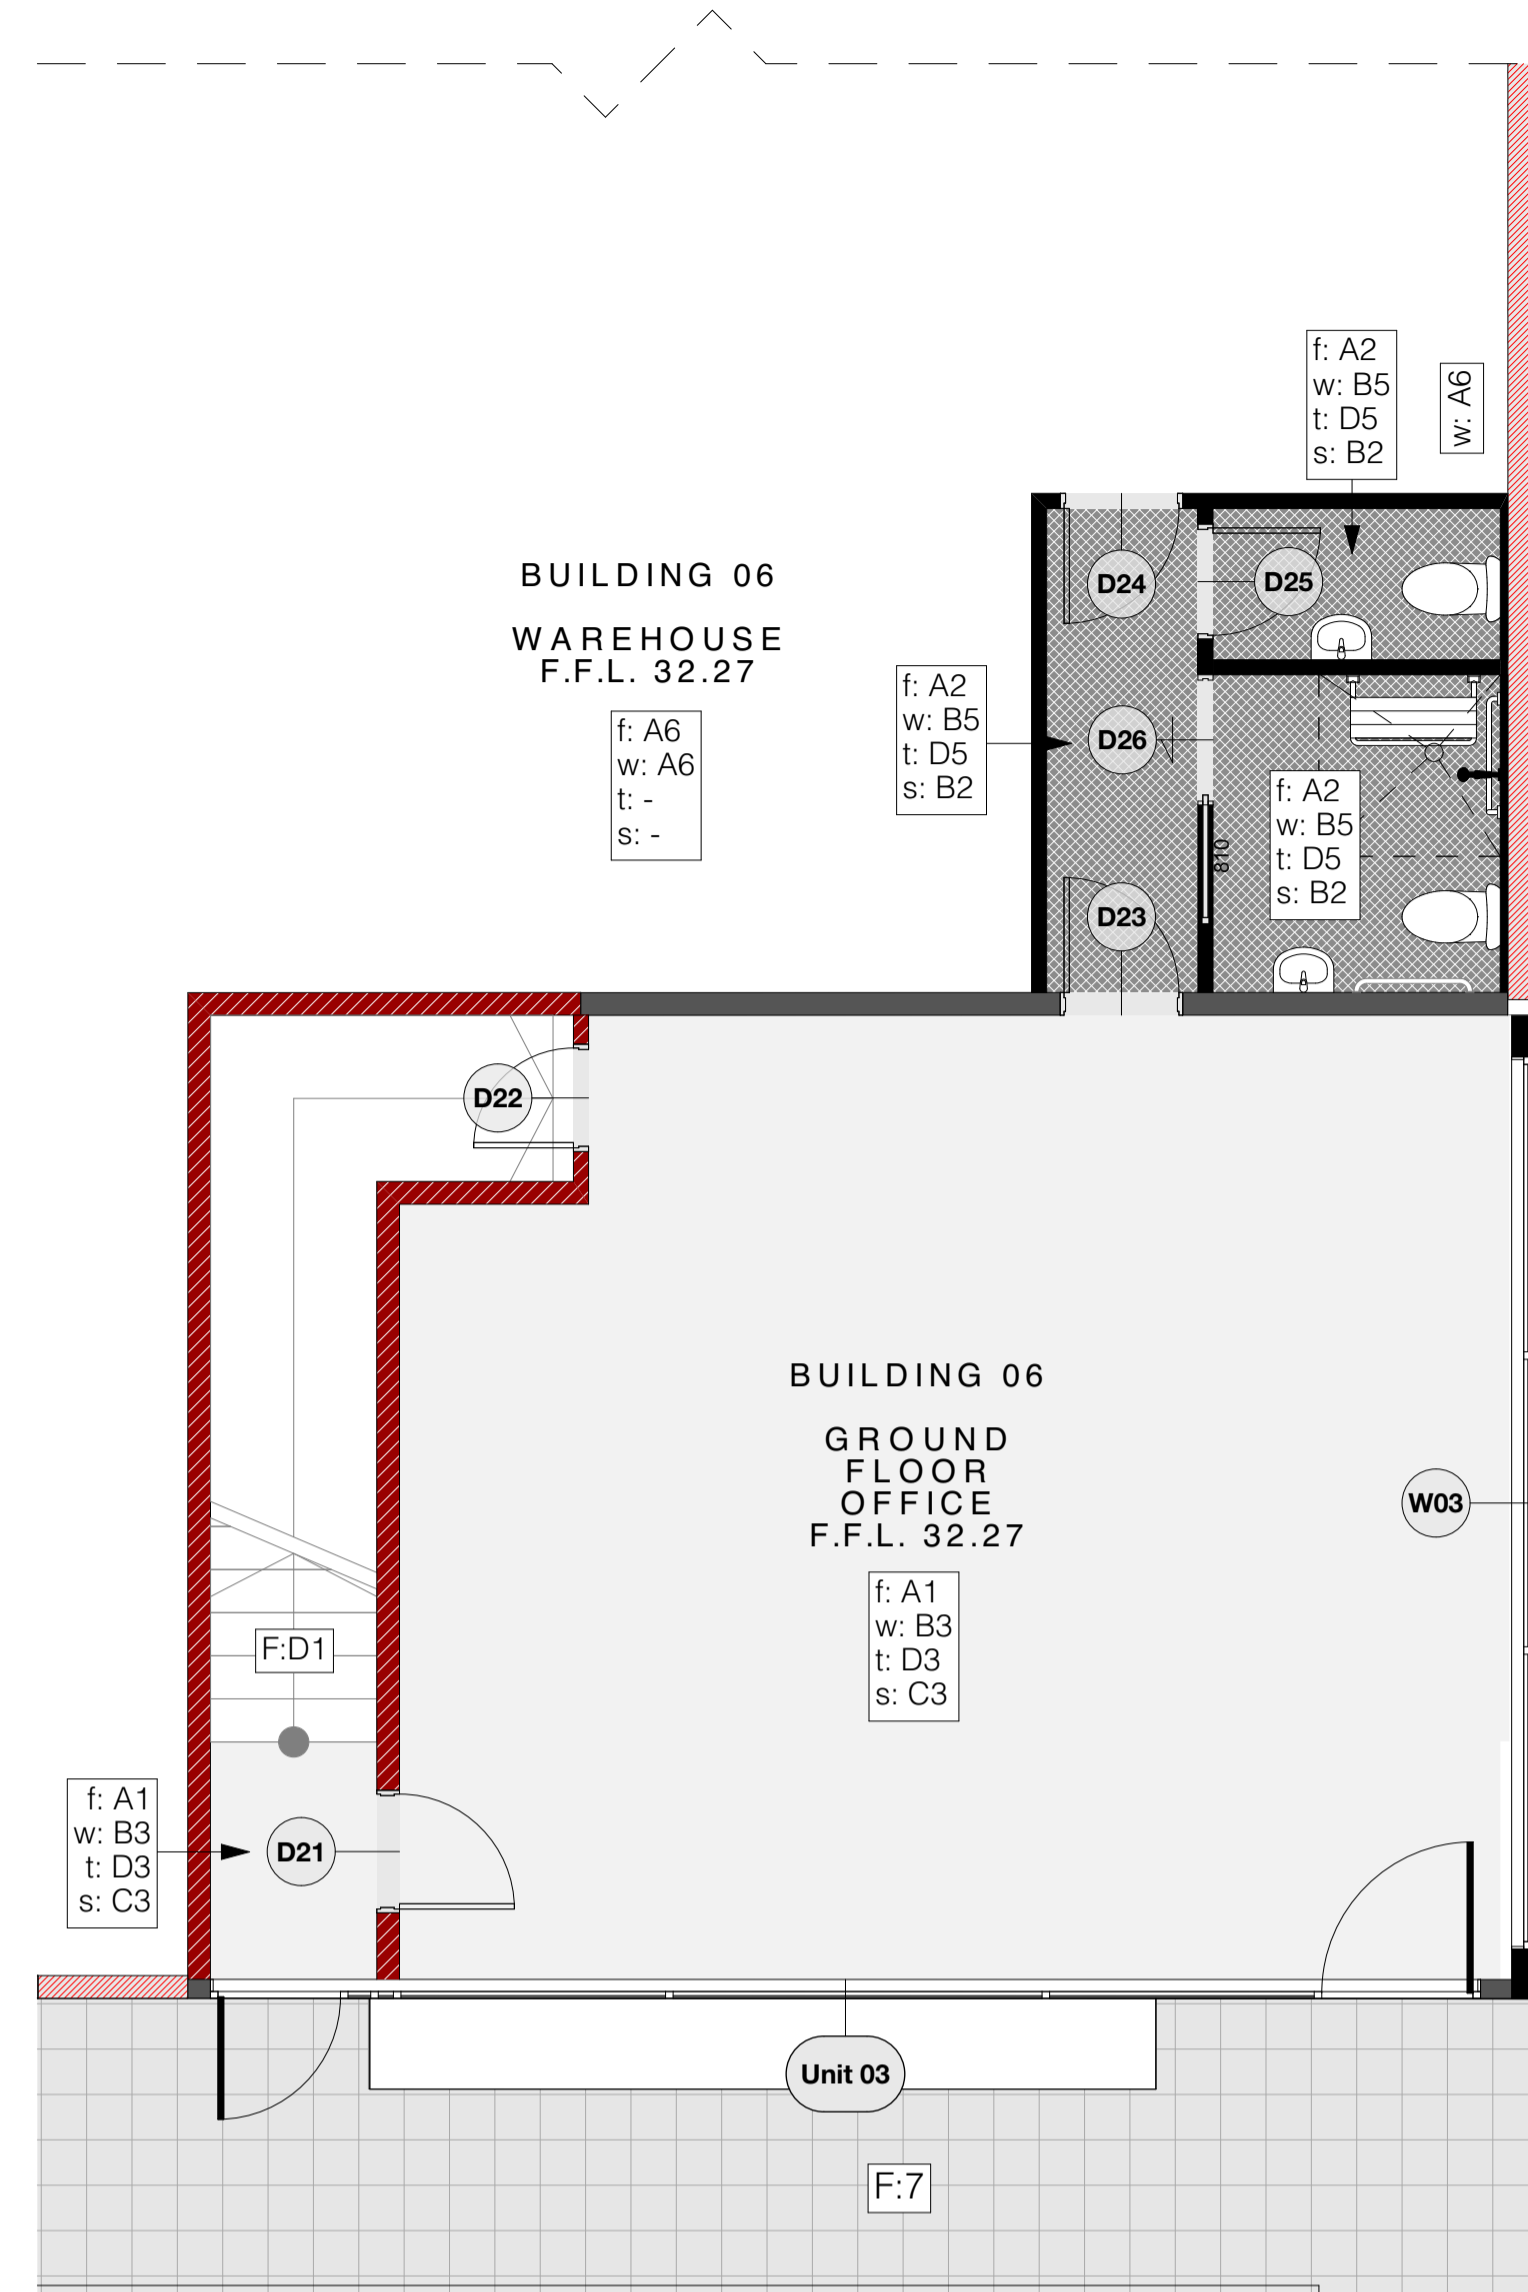


PROPOSED GROUND FINISHES PLAN - BUILDING 06
 SCALE 1:50 @ A1

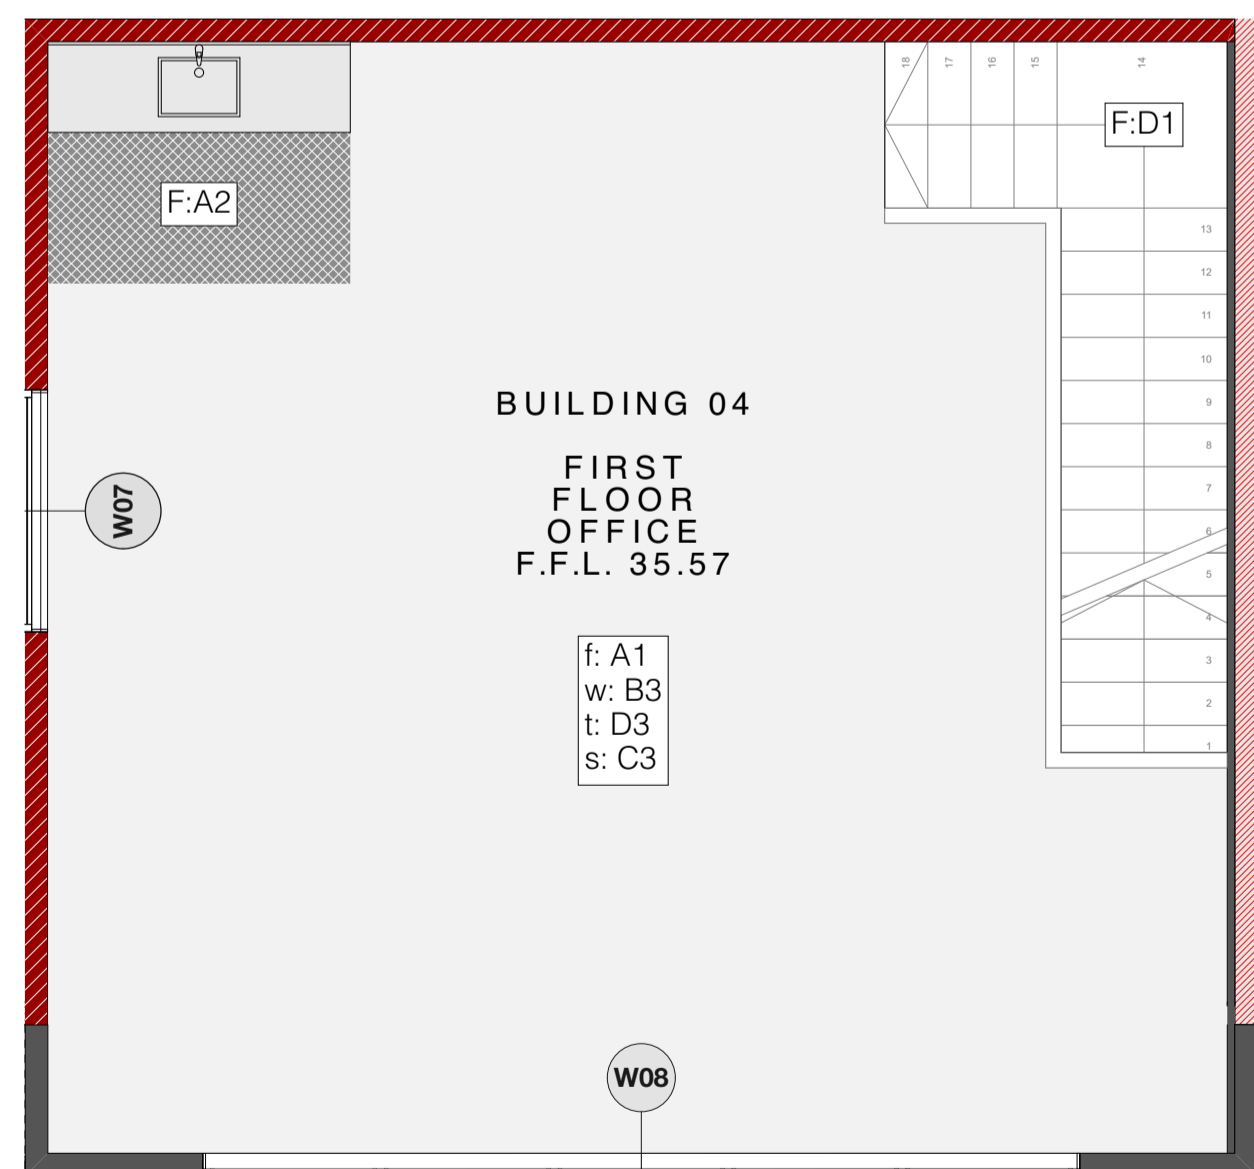

PROPOSED FIRST FINISHES PLAN - BUILDING 04
 SCALE 1:50 @ A1

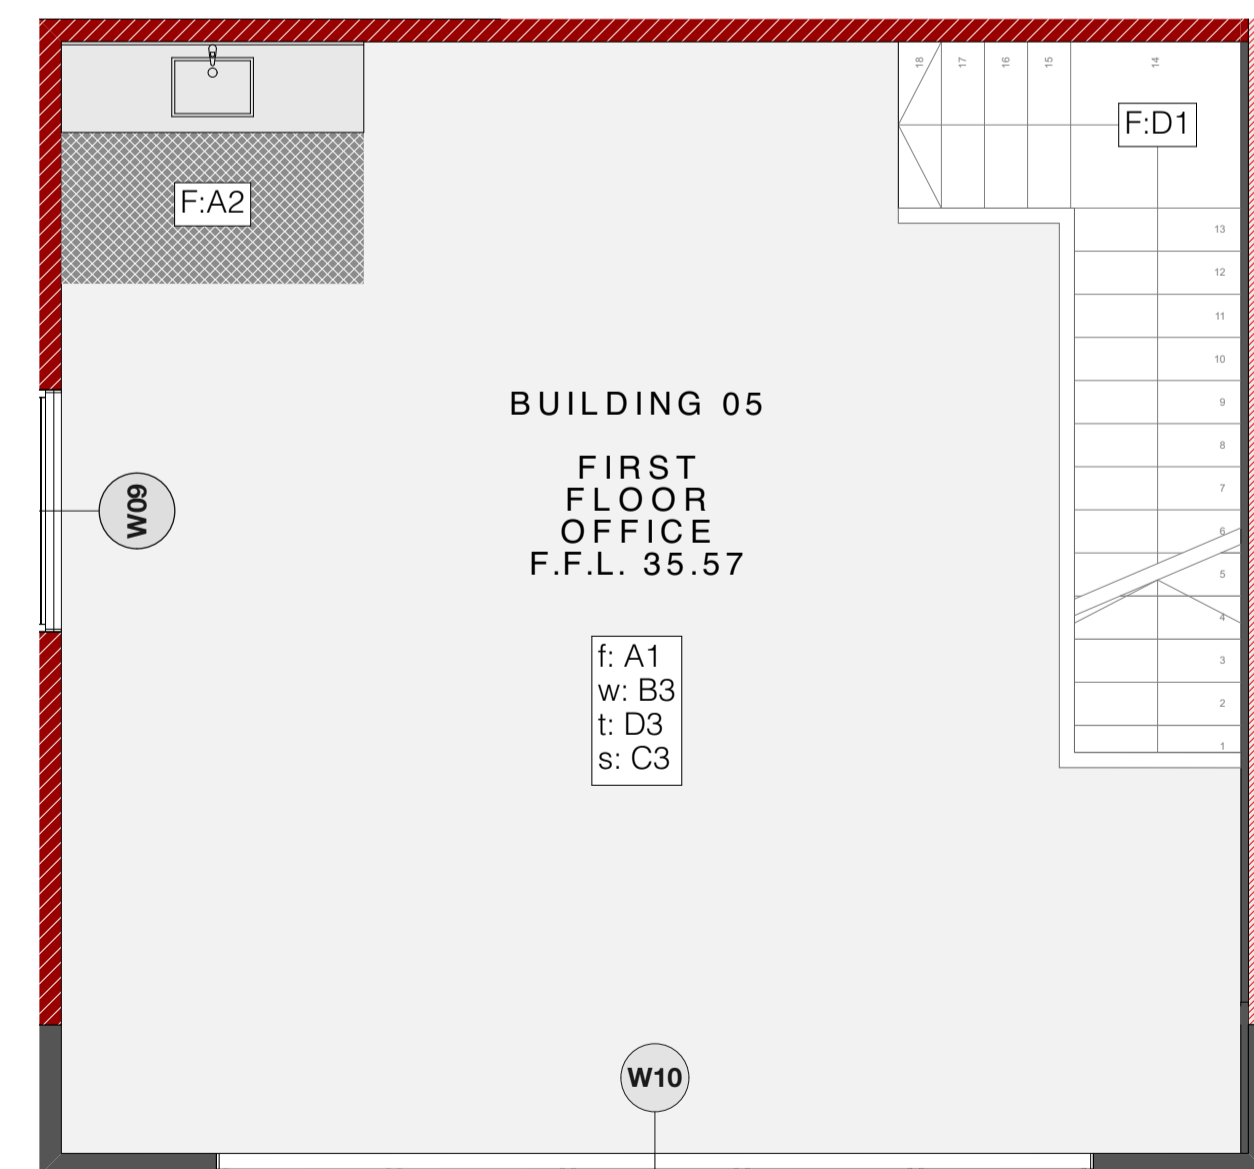

PROPOSED FIRST FINISHES PLAN - BUILDING 05
 SCALE 1:50 @ A1

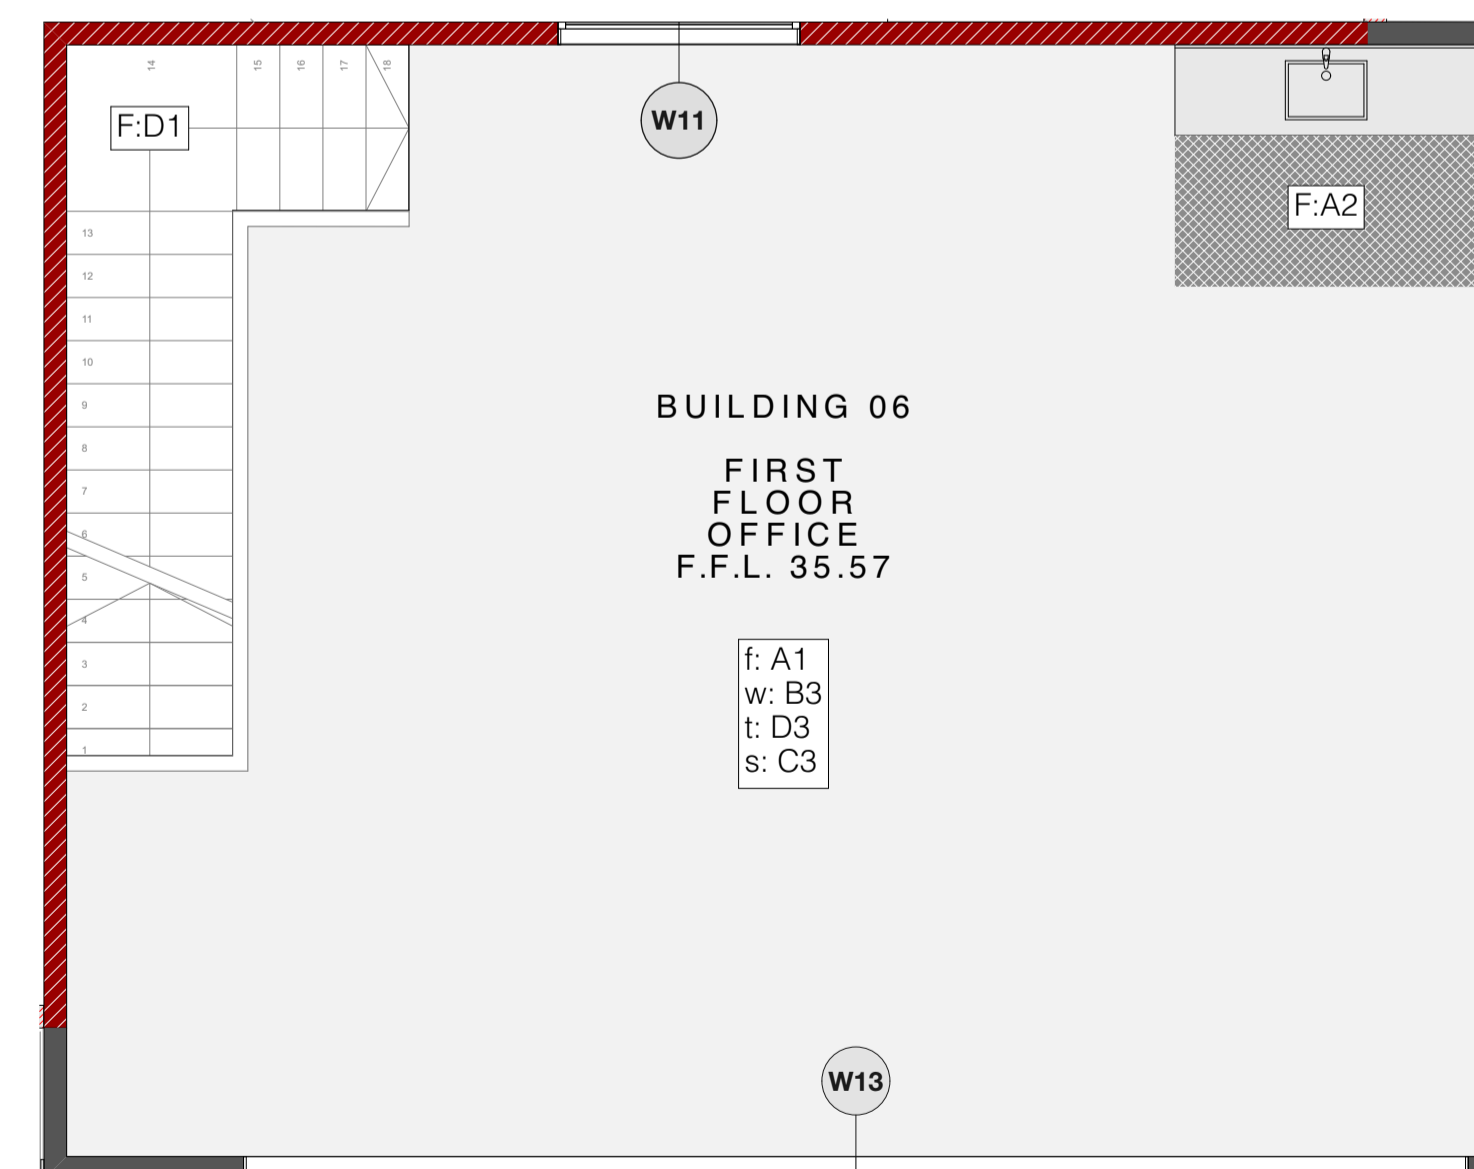

PROPOSED FIRST FINISHES PLAN - BUILDING 06
 SCALE 1:50 @ A1

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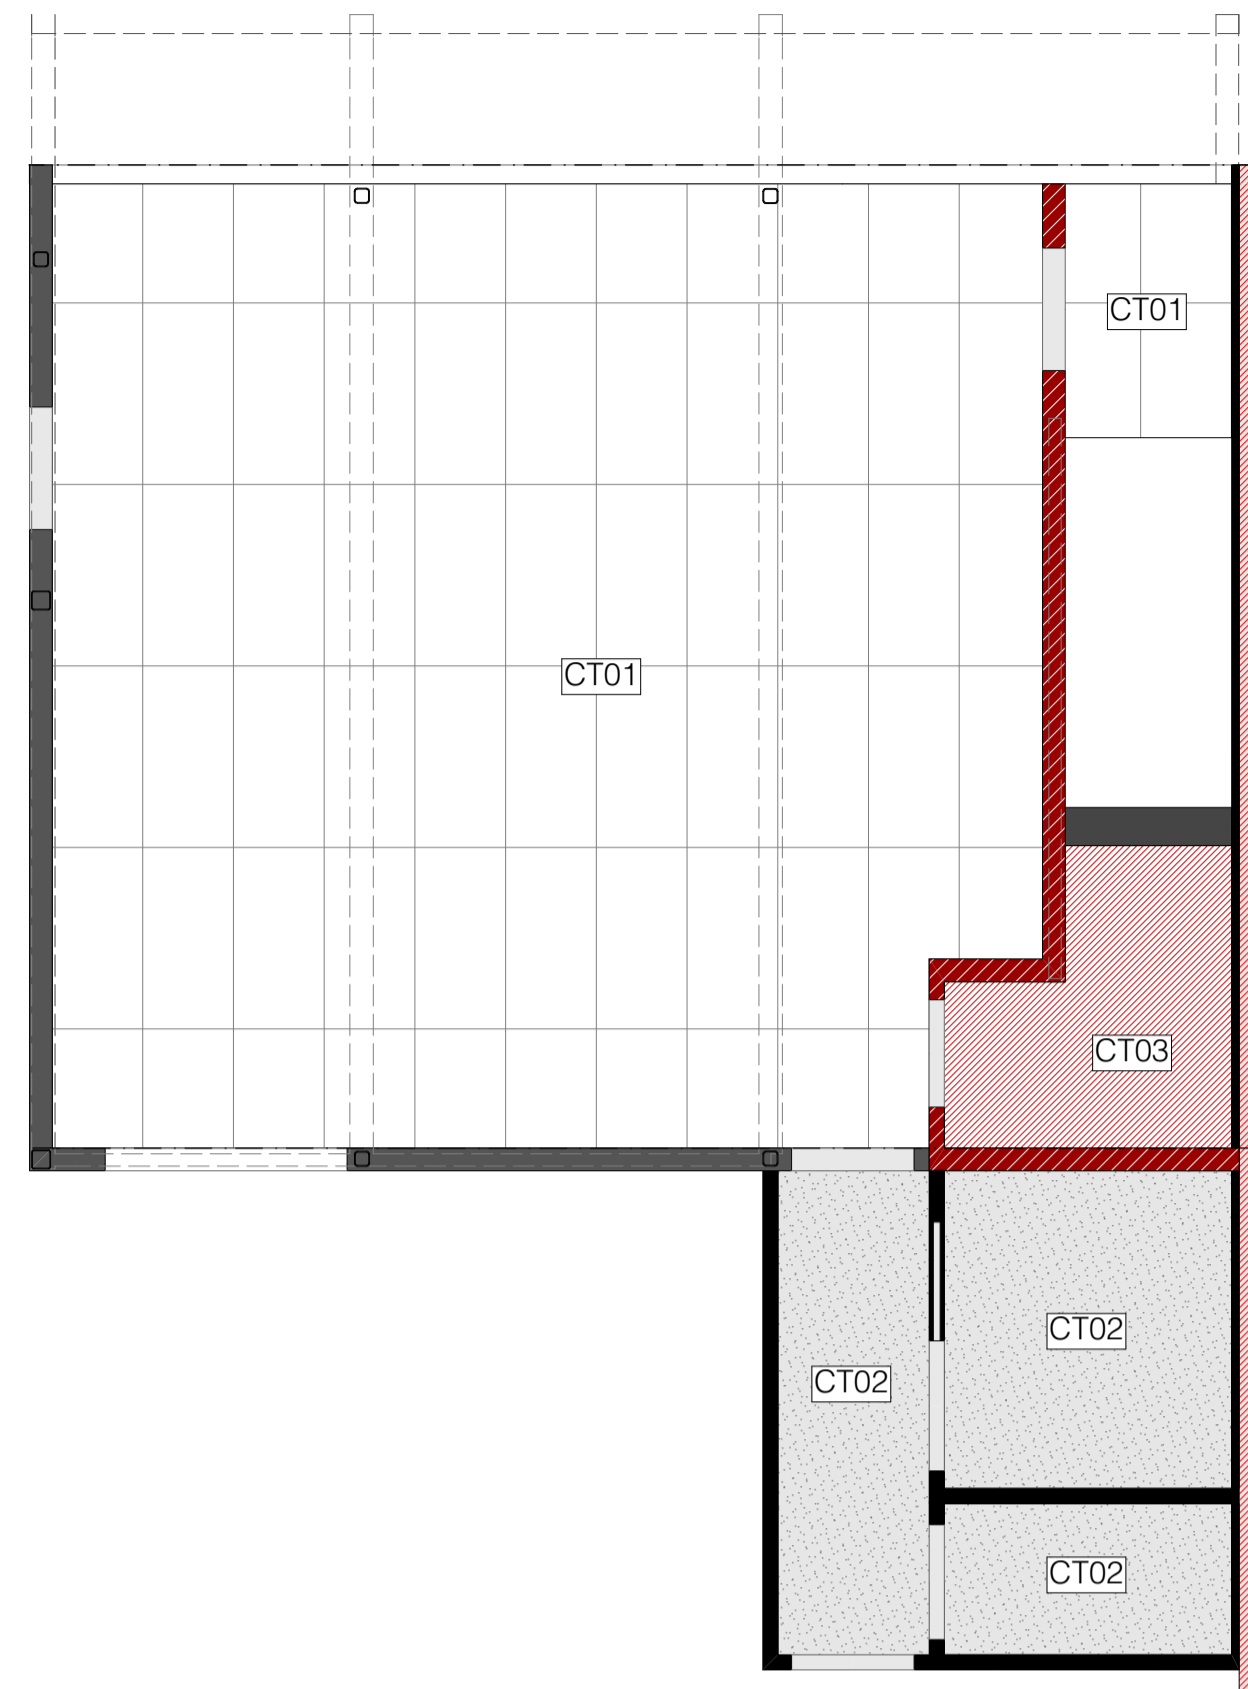
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PROJECT: Te Rapa Stage 2


CLIENT: Fosters Construction
 SITE: Te Rapa Industrial Park, Hamilton

DRAWING TITLE: PROPOSED FLOOR FINISHES - BUILDINGS 04-06


PROJECT REF: T0424 TE RAPA S2	
DATE: 25/06/19	SCALE: 1:50 @ A1
SHEET: A23	REV: C01



PROPOSED GROUND CEILING FINISHES - BUILDING 04
SCALE 1:50 @ A1

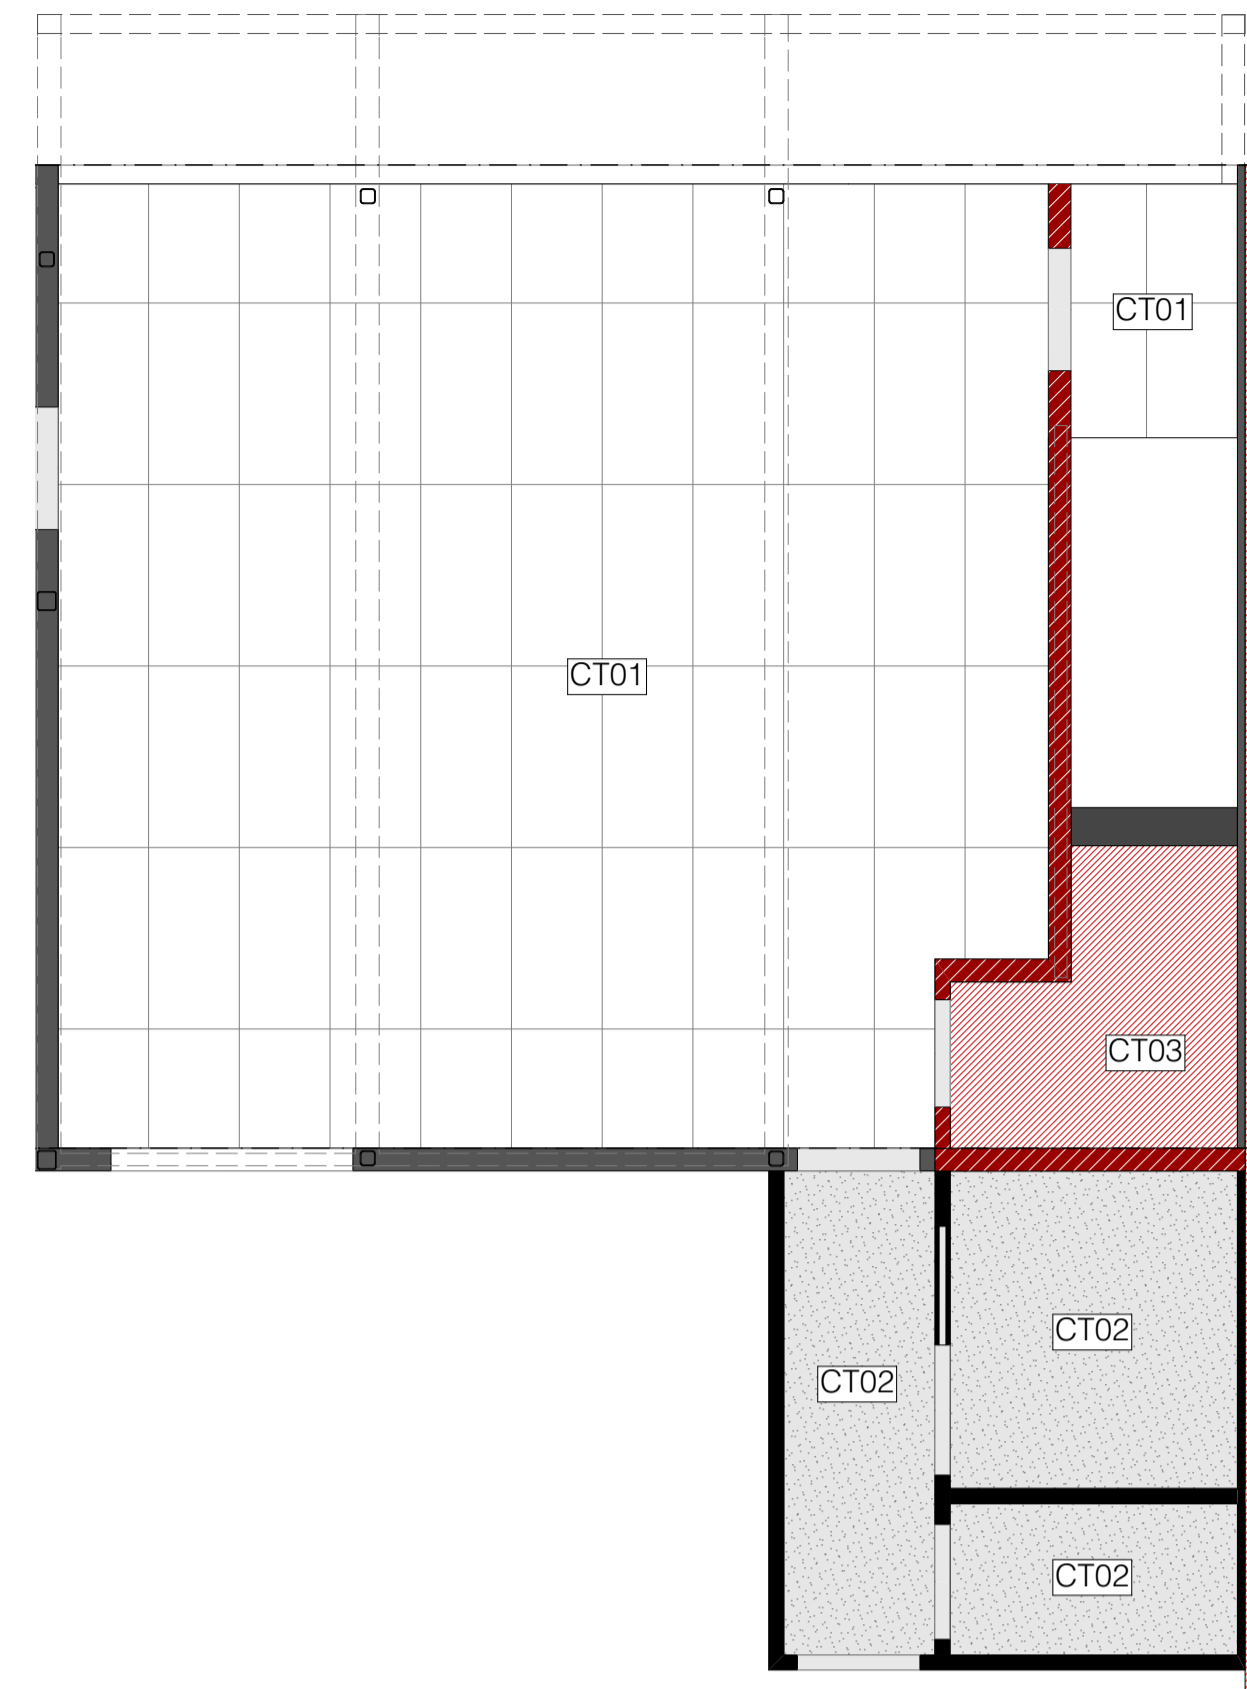


PROPOSED GROUND CEILING FINISHES - BUILDING 05
SCALE 1:50 @ A1

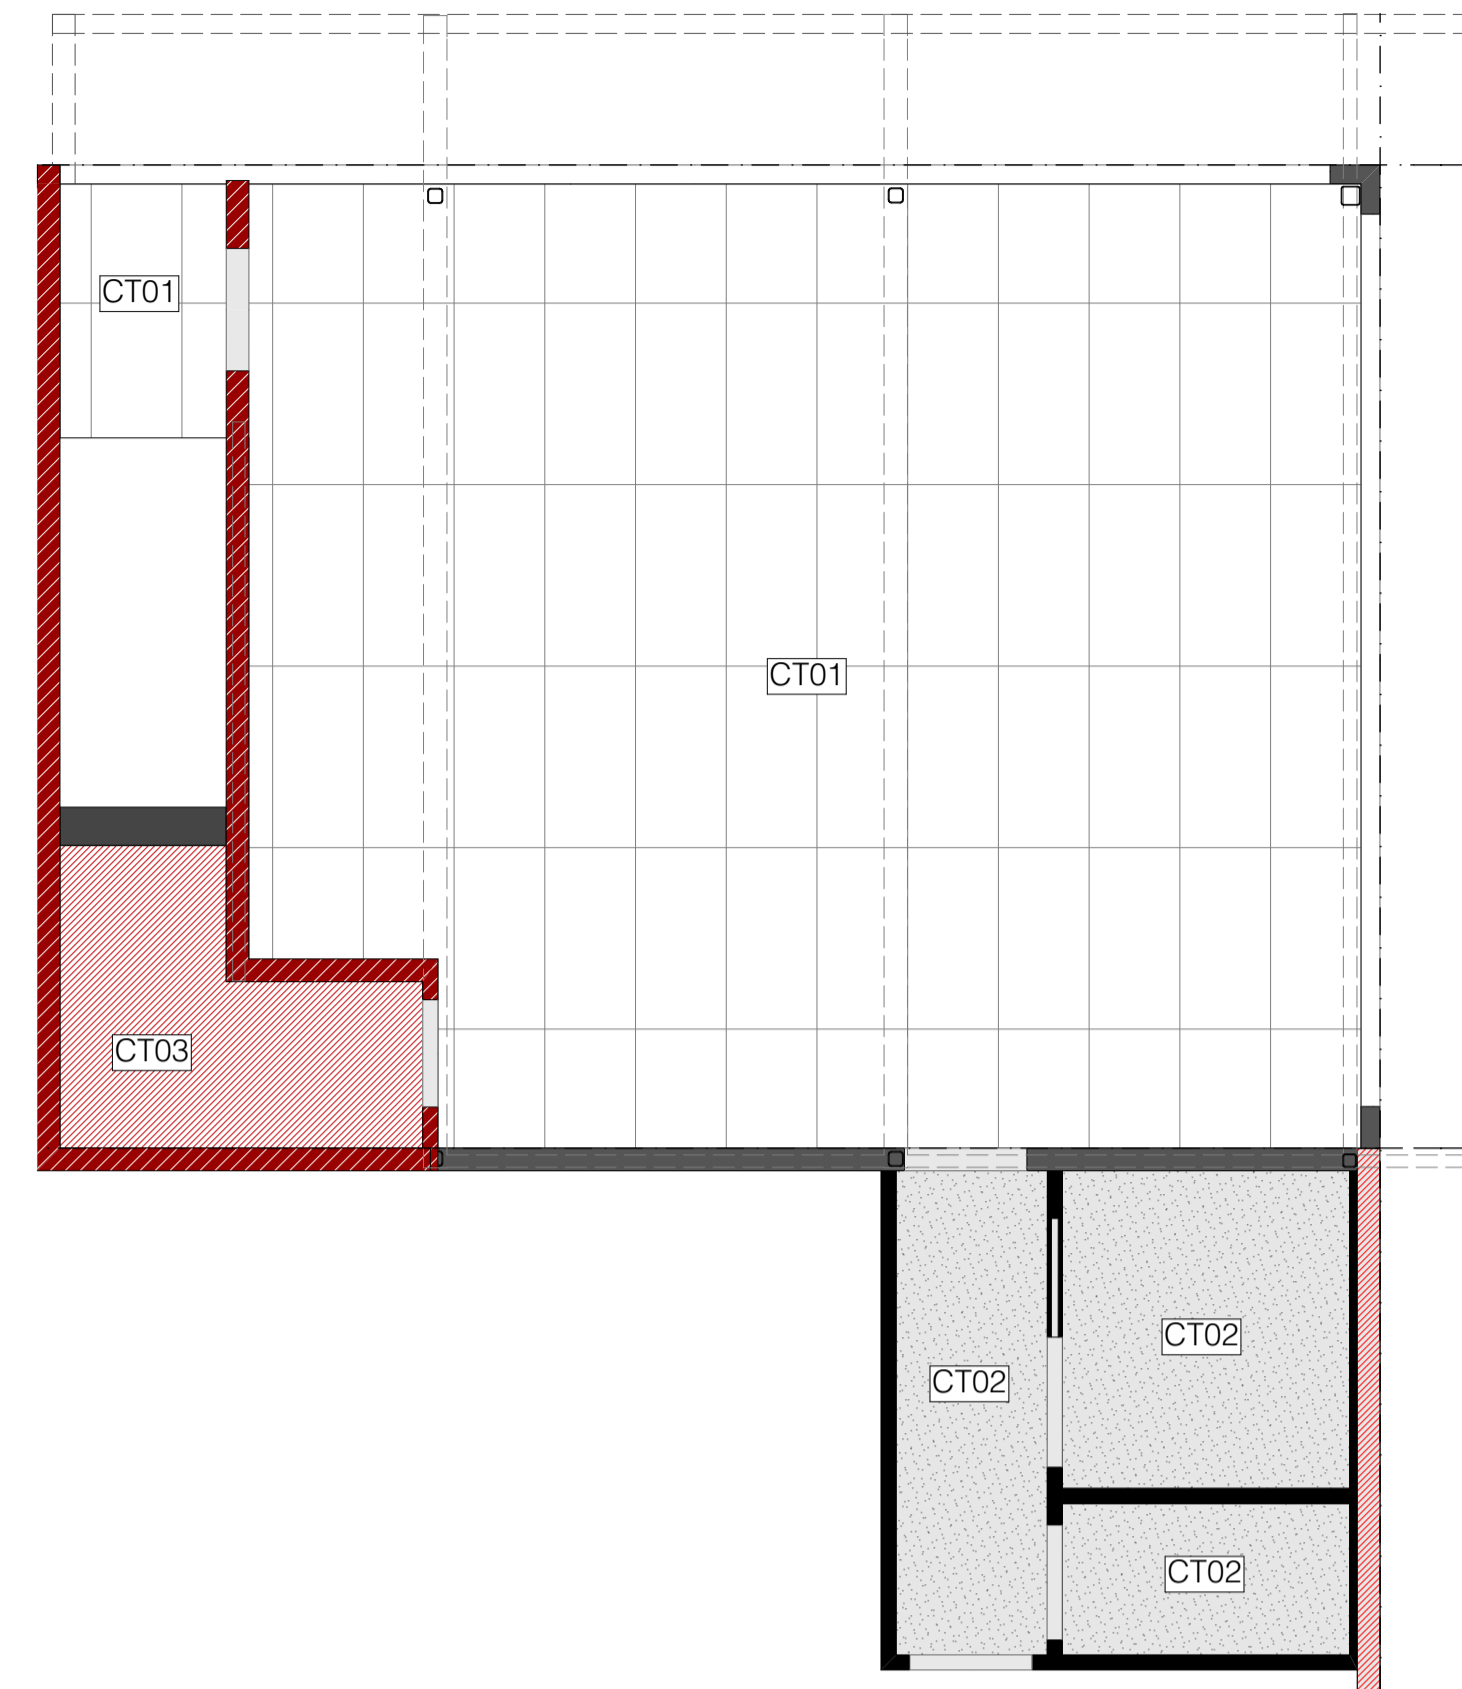


PROPOSED GROUND CEILING FINISHES - BUILDING 06
SCALE 1:50 @ A1

CEILING PLAN KEY


- RT01** Warehouse Roof: 0.55 BMT Dimond BB900 profiled COLOURSTEEL roofing with MAXX finish over selected Thermakraft roofing underlay over safety mesh on roof structure
- RT04** Warehouse roof skylight: AMPELITE SL translucent sheet roofing to match profile of roof fixed over Thermakraft safety mesh on roof structure.
- CT01** Internal ceiling: RONDO DONN DX suspended grid system with 1200x600 USG IMPRESSIONS CLIMAPLUS mineral fibre ceiling tiles
- CT02** Internal ceiling: 13 GIB AQUALINE ceiling lining fixed to ex75x40mm Radiata H1.2 SG8 timber battens at 600 centres over ex100x50 Radiata H1.2 SG8 timber ceiling joists at 600mm centres.
- CT03** Underside of stairs: 16mm GIB Fyrline lining to underside of timber stair structure in accordance with GIB specification - GBFC60. Fired rated lining to extend through to fire rated wall structure.

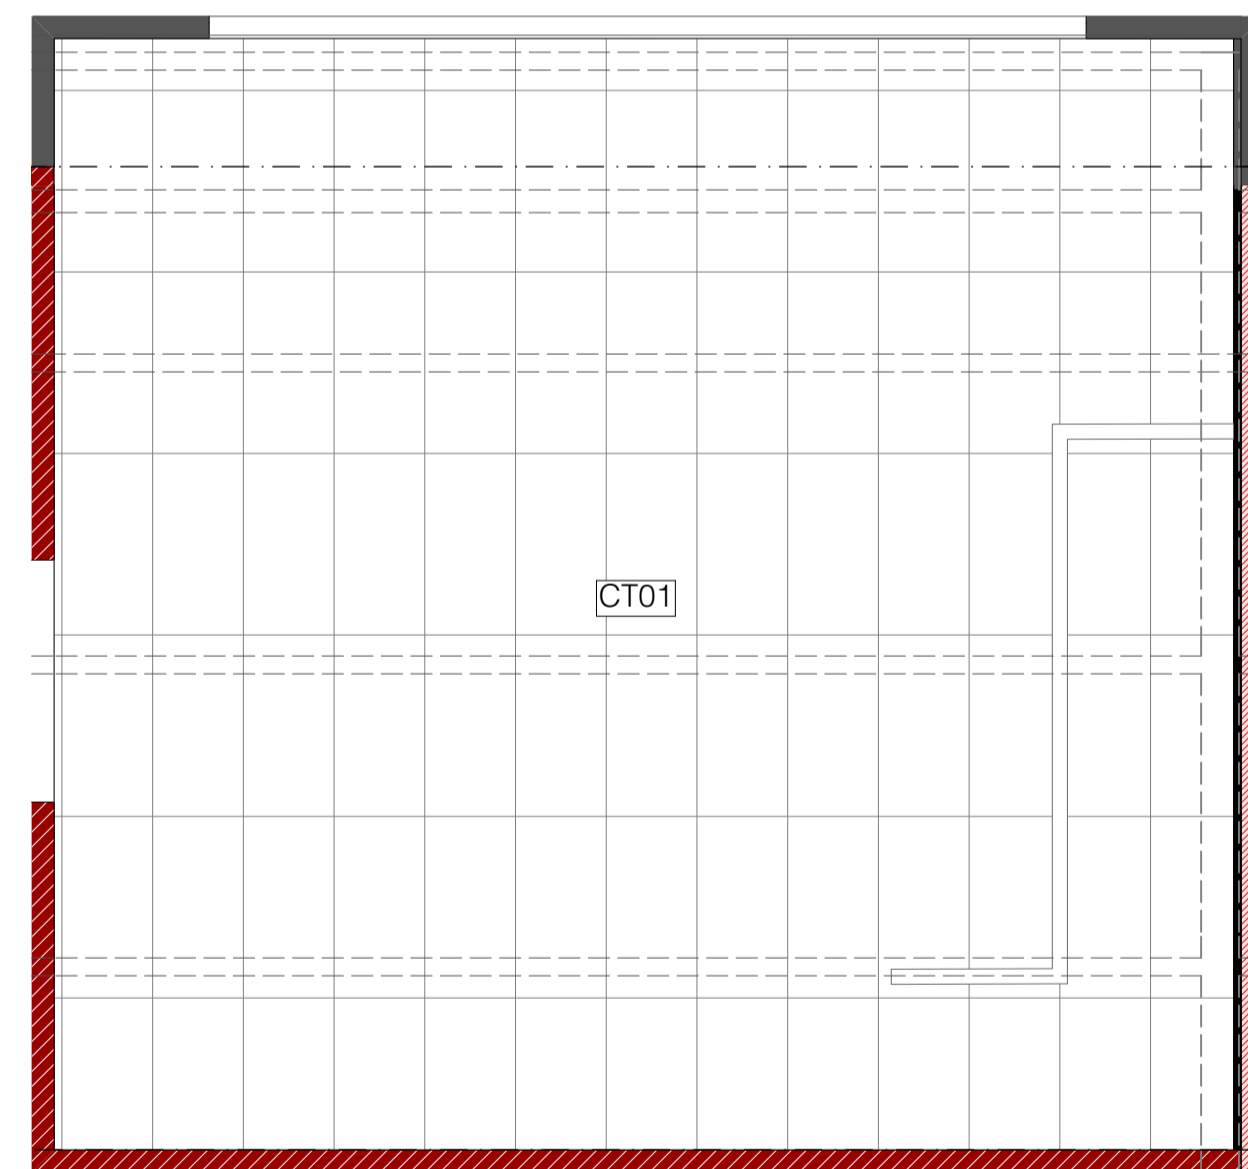

PROPOSED FIRST CEILING FINISHES - BUILDING 04
SCALE 1:50 @ A1

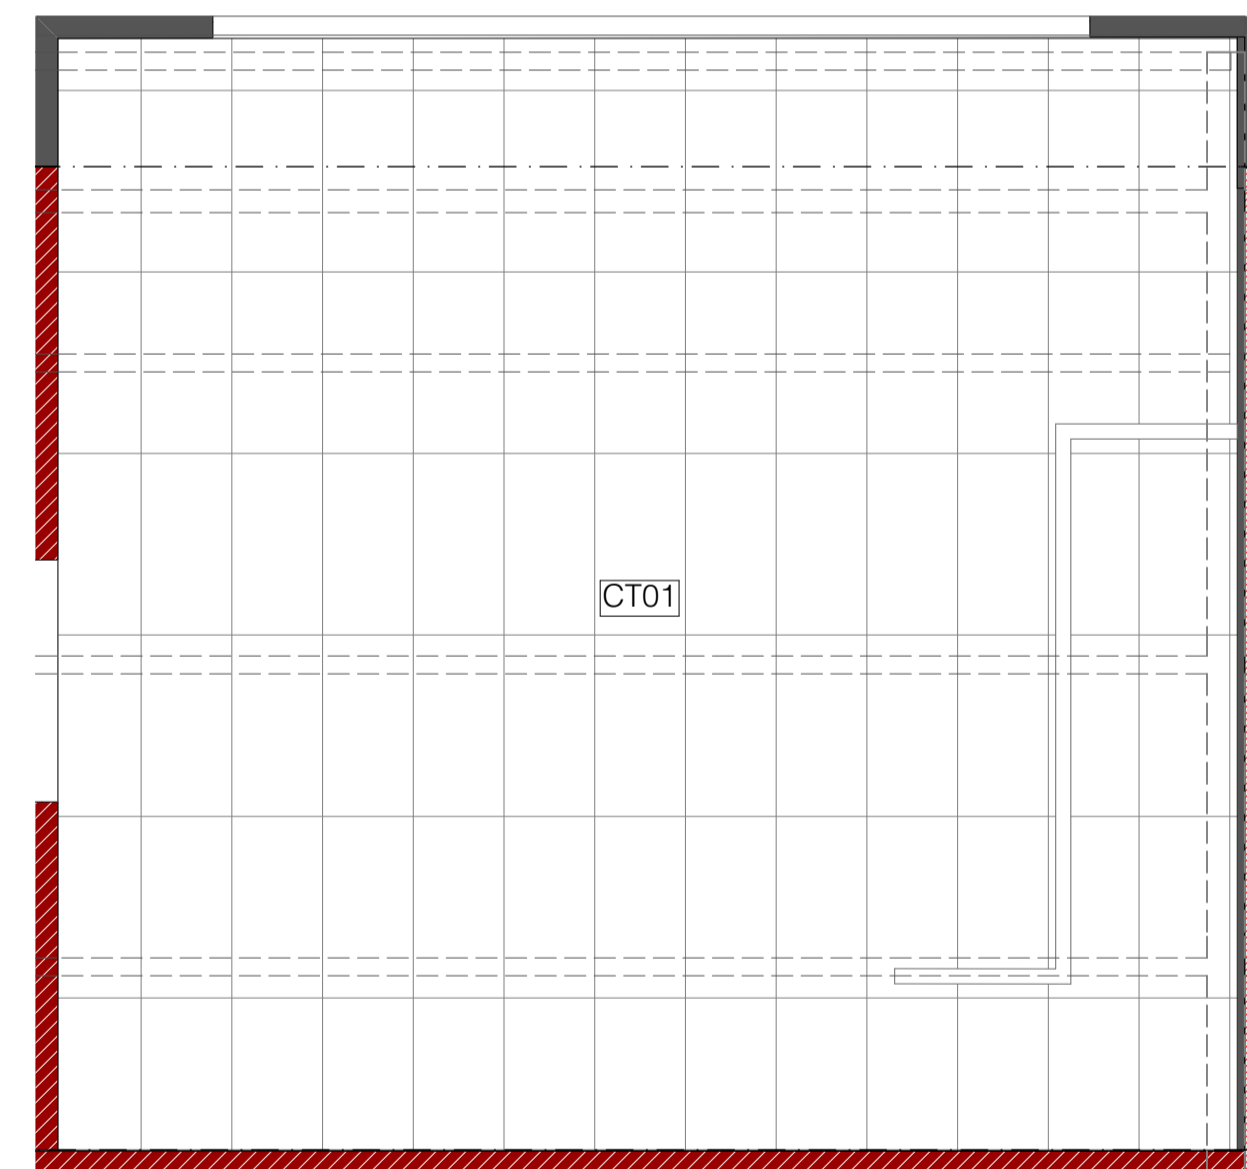

PROPOSED FIRST CEILING FINISHES - BUILDING 05
SCALE 1:50 @ A1

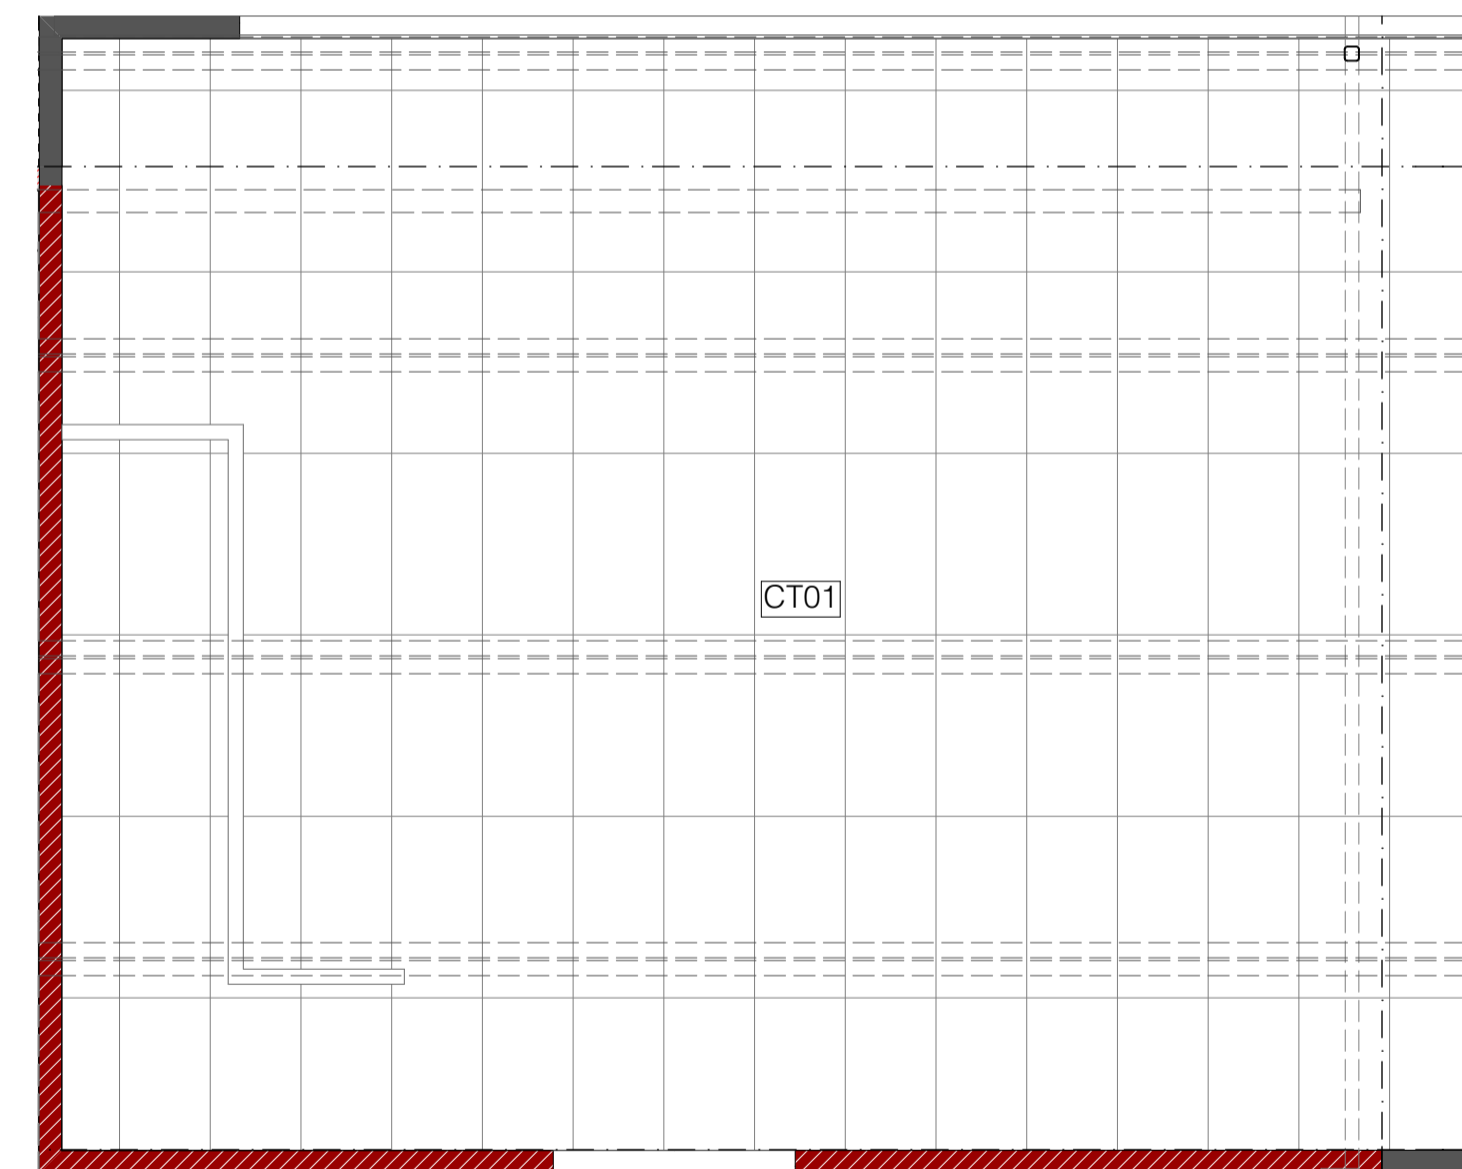

PROPOSED FIRST CEILING FINISHES - BUILDING 06
SCALE 1:50 @ A1

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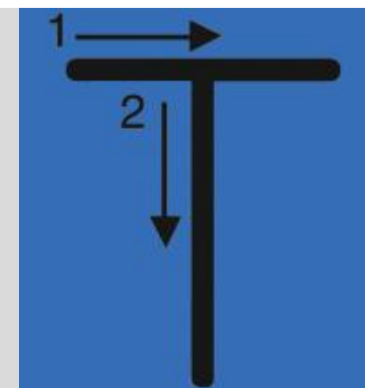
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PROJECT:

Te Rapa Stage 2

CLIENT: Fosters Construction
SITE: Te Rapa Industrial Park, Hamilton

FOR CONSTRUCTION ISSUE

DRAWING TITLE:

PROPOSED CEILING FINISHES - BUILDINGS 01-03

PROJECT REF:

T0424 TE RAPA S2

DATE:

25/06/19

SHEET:


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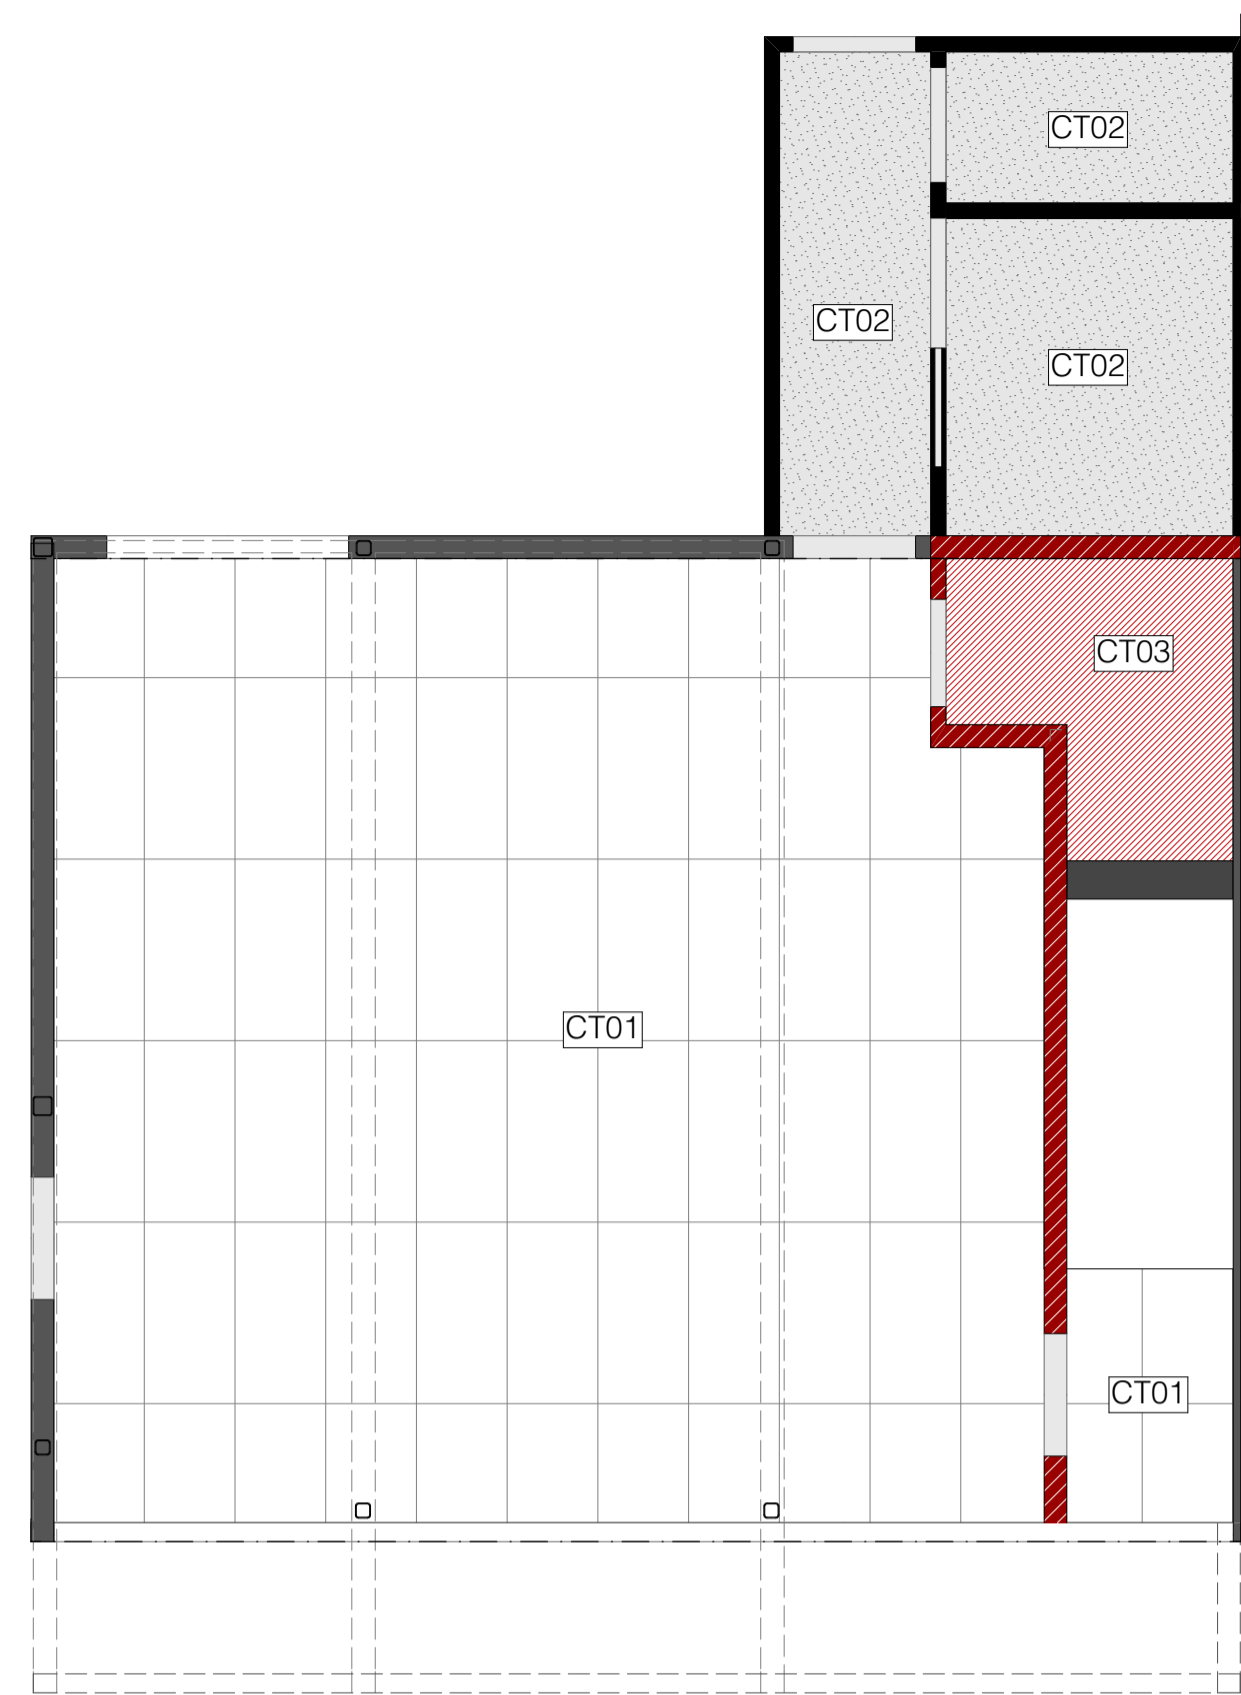
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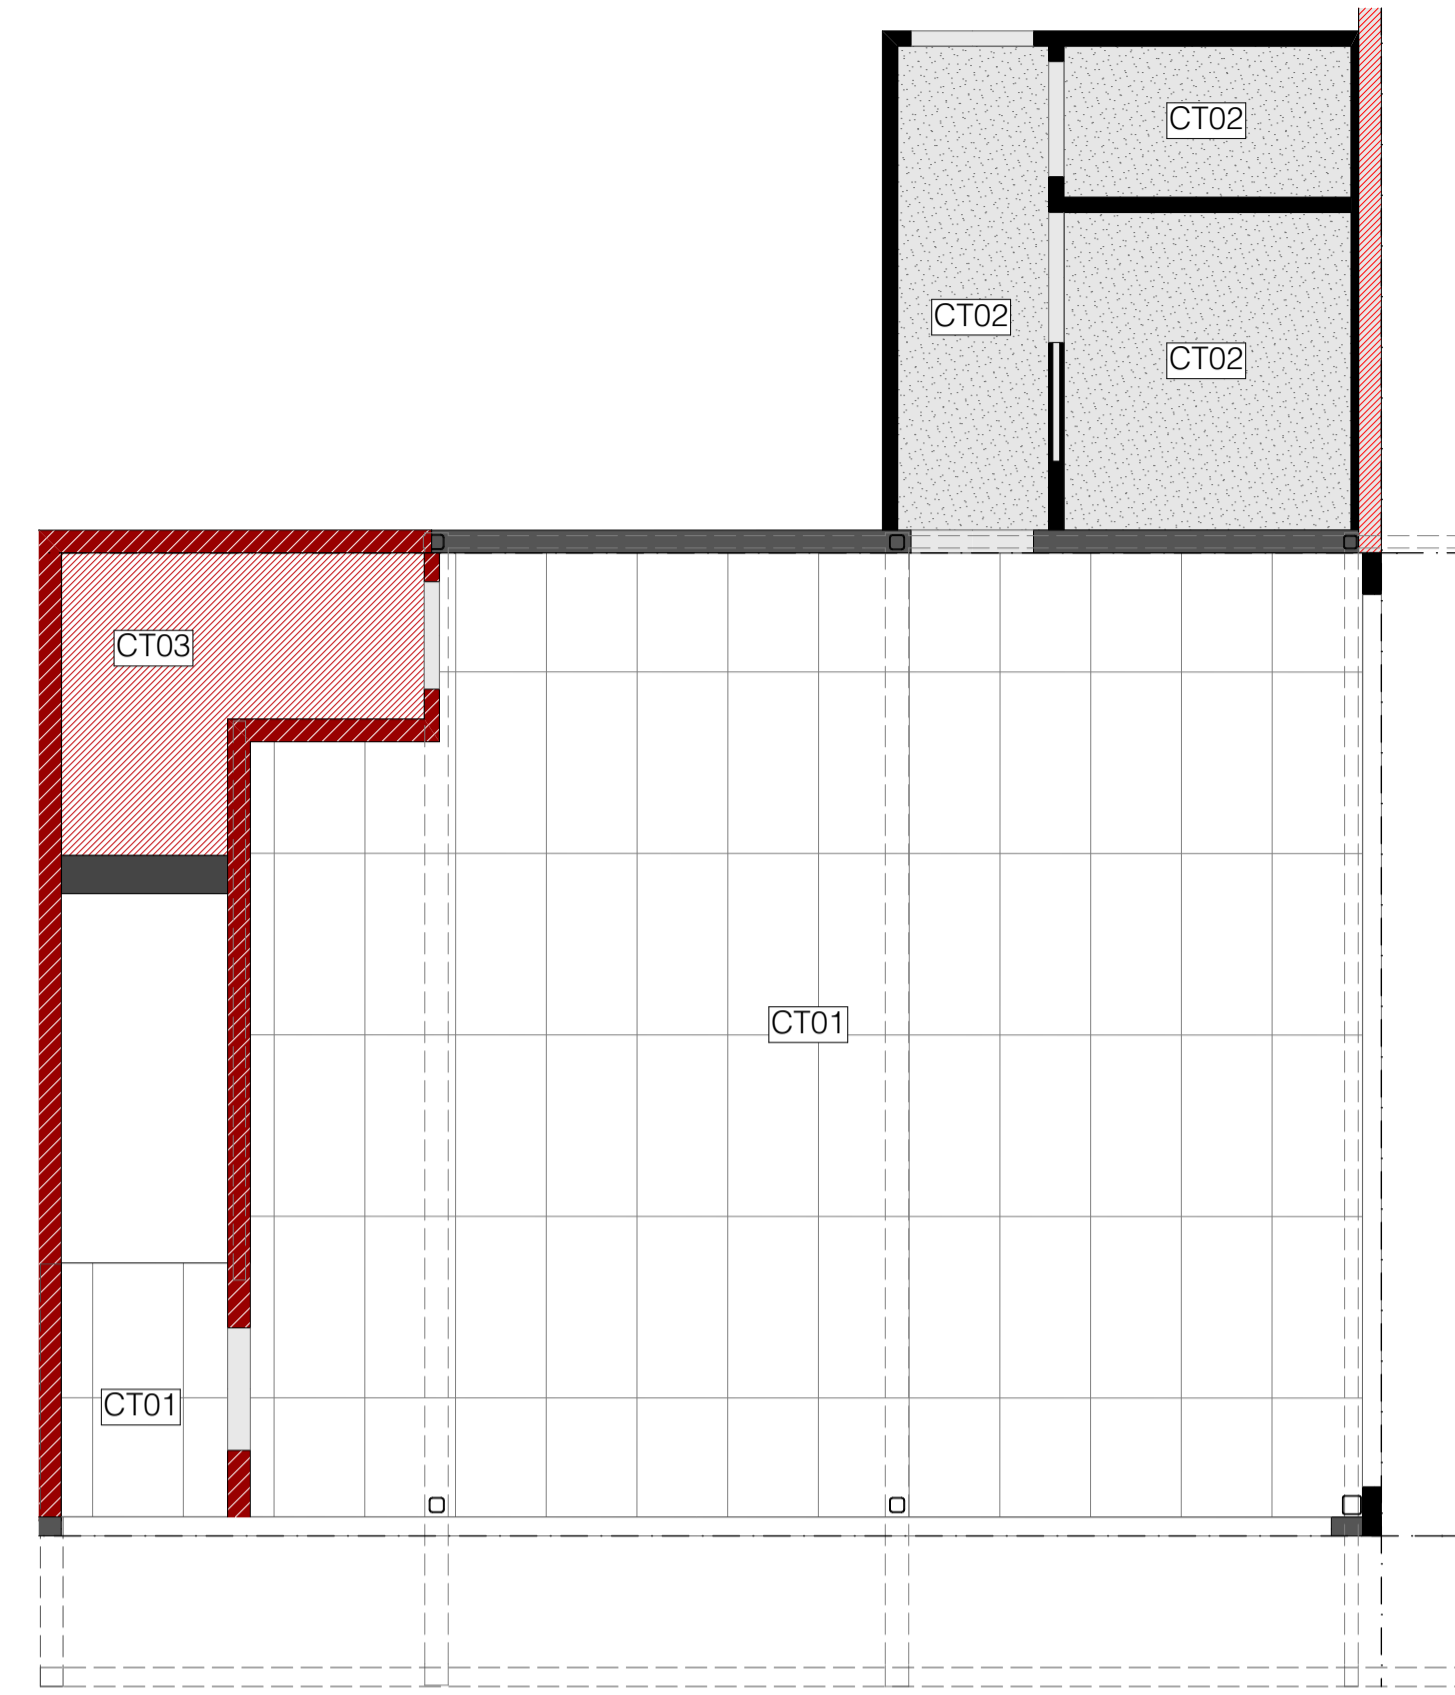
C01



PROPOSED GROUND CEILING FINISHES - BUILDING 04
SCALE 1:50 @ A1




PROPOSED GROUND CEILING FINISHES - BUILDING 05
SCALE 1:50 @ A1

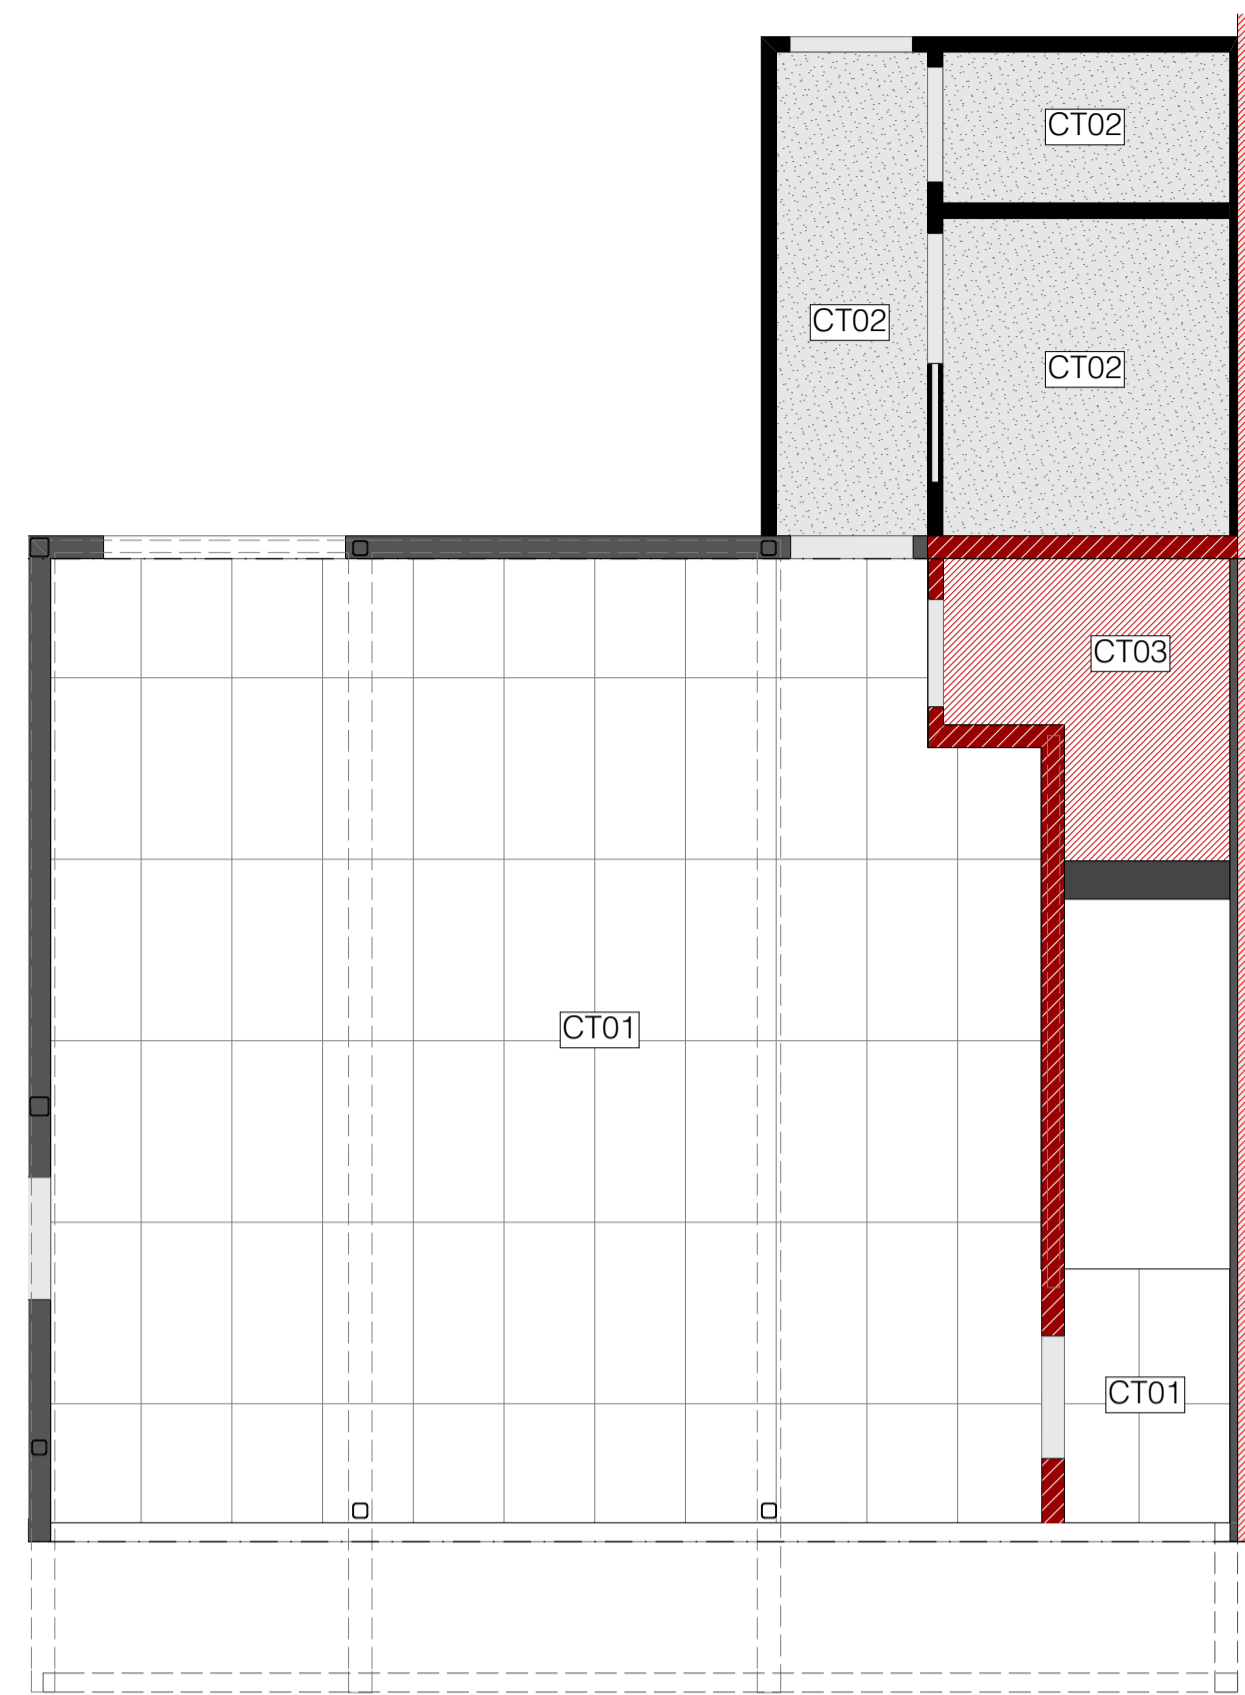


PROPOSED GROUND CEILING FINISHES - BUILDING 06
SCALE 1:50 @ A1

CEILING PLAN KEY


- RT01** Warehouse Roof: 0.55 BMT Dimond BB900 profiled COLORSTEEL roofing with MAXX finish over selected Thermakraft roofing underlay over safety mesh on roof structure
- RT04** Warehouse roof skylight: AMPELITE SL translucent sheet roofing to match profile of roof fixed over Thermakraft safety mesh on roof structure.
- CT01** Internal ceiling: RONDO DONN DX suspended grid system with 1200x600 USG IMPRESSIONS CLIMAPLUS mineral fibre ceiling tiles
- CT02** Internal ceiling: 13 GIB AQUALINE ceiling lining fixed to ex75x40mm Radiata H1.2 SG8 timber battens at 600 centres over ex100x50 Radiata H1.2 SG8 timber ceiling joists at 600mm centres.
- CT03** Underside of stairs: 16mm GIB Fyrlite lining to underside of timber stair structure in accordance with GIB specification - GBFC60. Fired rated lining to extend through to fire rated wall structure.

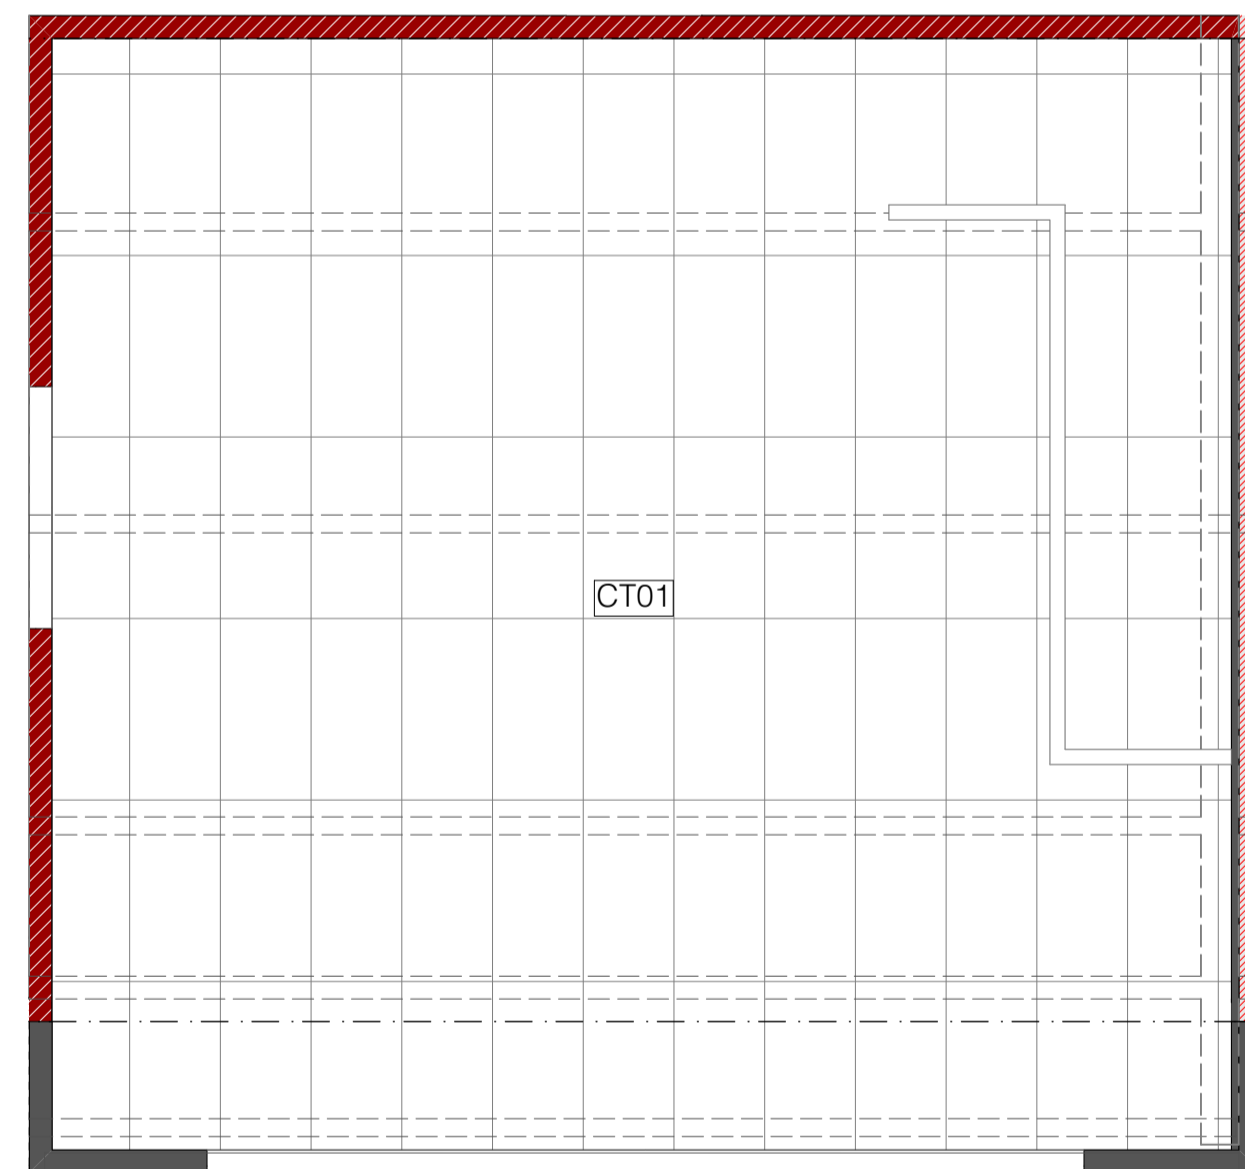

PROPOSED FIRST CEILING FINISHES - BUILDING 04
SCALE 1:50 @ A1

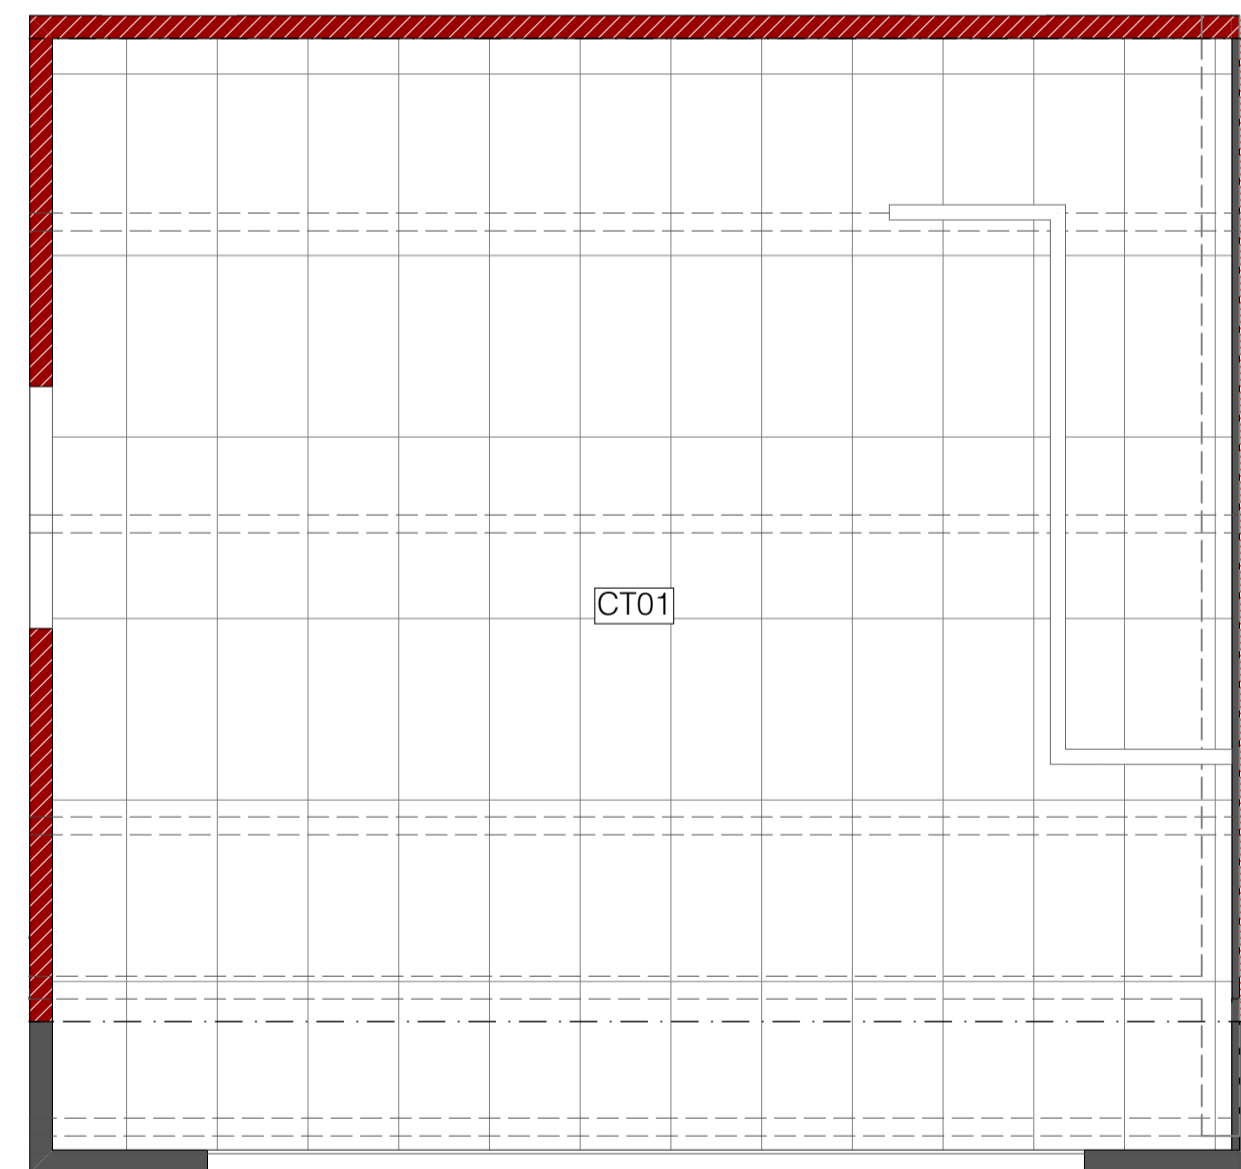

PROPOSED FIRST CEILING FINISHES - BUILDING 05
SCALE 1:50 @ A1

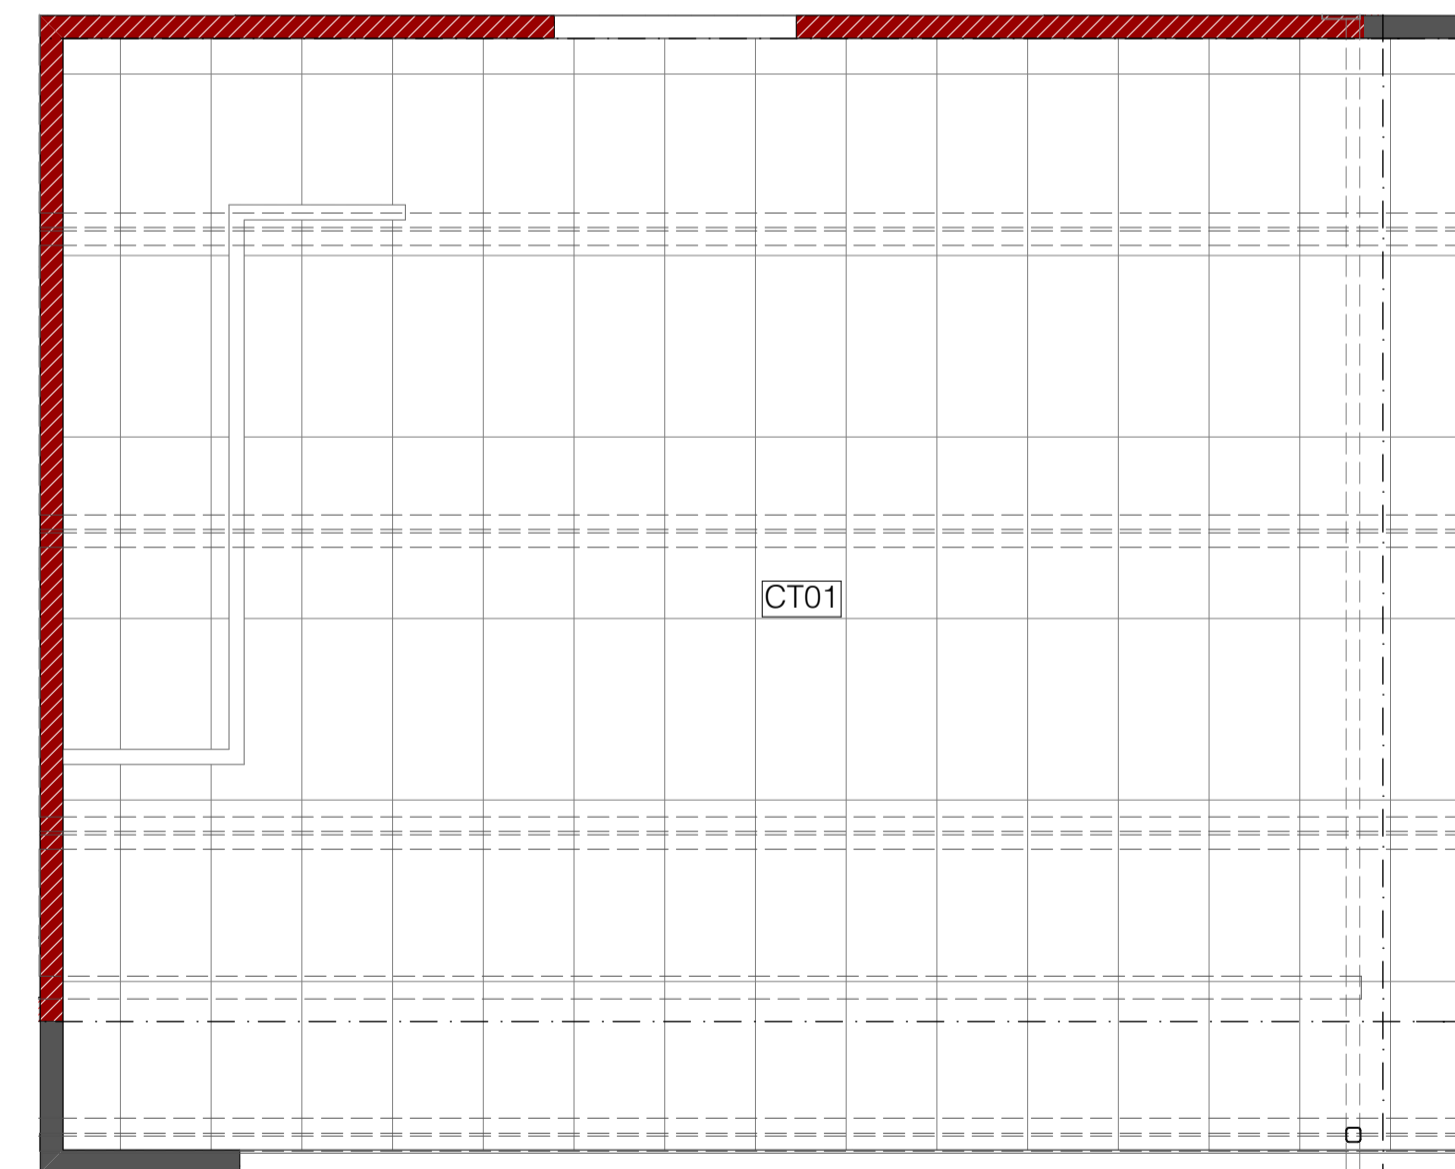

PROPOSED FIRST CEILING FINISHES - BUILDING 06
SCALE 1:50 @ A1

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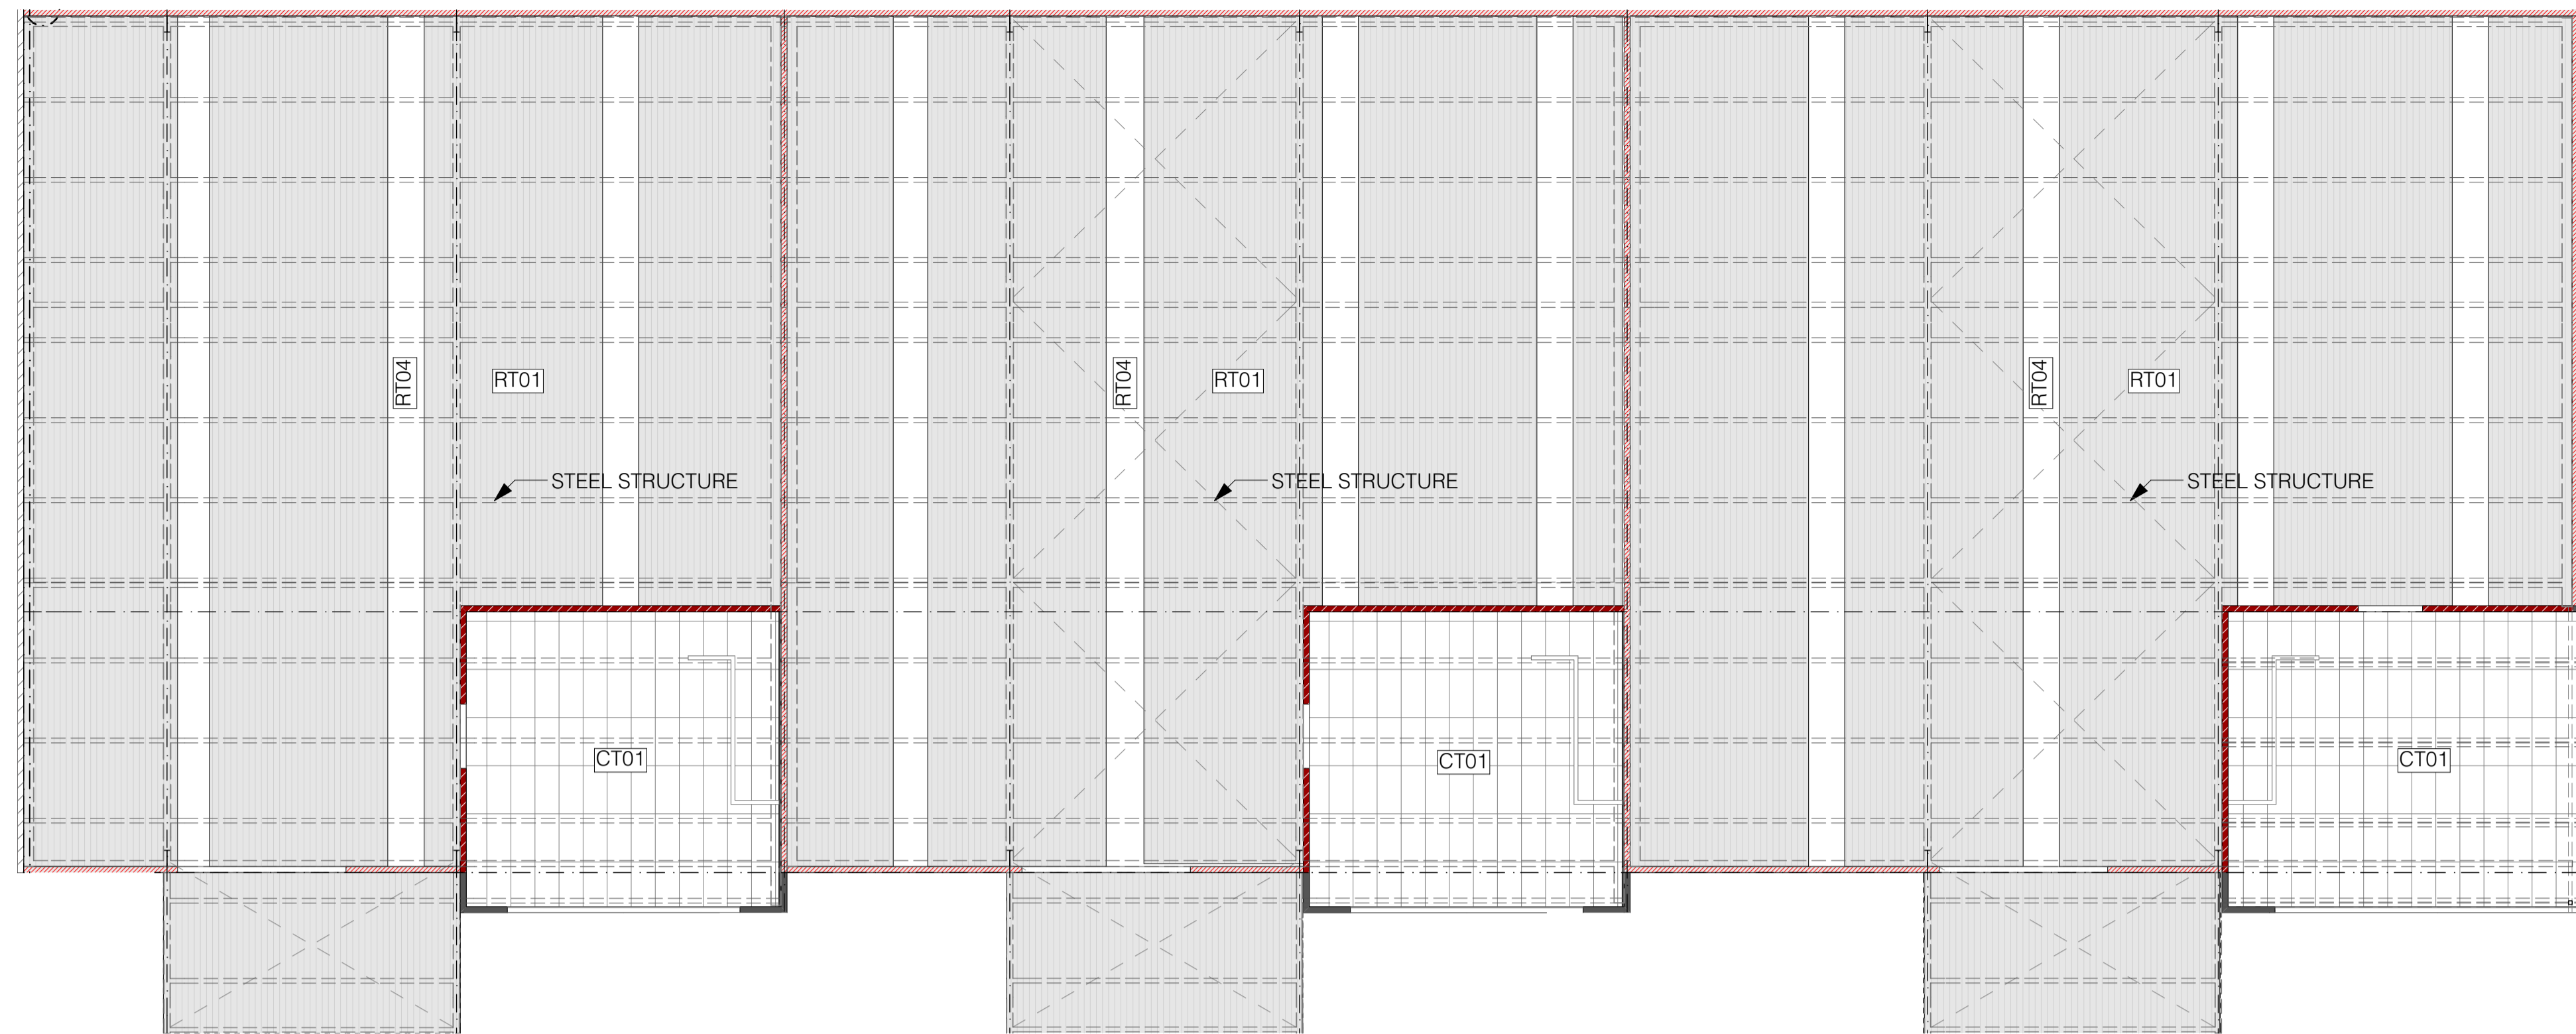
PROJECT:
Te Rapa Stage 2

CLIENT: Fosters Construction
SITE: Te Rapa Industrial Park, Hamilton

FOR CONSTRUCTION ISSUE

DRAWING TITLE:
PROPOSED CEILING FINISHES - BUILDINGS 04-06


PROJECT REF: T0424 TE RAPA S2	
DATE: 25/06/19	SCALE: 1:50 @ A1
SHEET: A25	REV: C01



PROPOSED WAREHOUSE CEILING FINISHES - BUILDING 04 - 06
SCALE 1:125 @ A1

CEILING PLAN KEY

- RT01** Warehouse Roof: 0.55 BMT Dimond BB900 profiled COLOURSTEEL roofing with MAXX finish over selected Thermakraft roofing underlay over safety mesh on roof structure
- RT04** Warehouse roof skylight: AMPELITE SL translucent sheet roofing to match profile of roof fixed over Thermakraft safety mesh on roof structure.
- CT01** Internal ceiling: RONDO DONN DX suspended grid system with 1200x600 USG IMPRESSIONS CLIMAPLUS mineral fibre ceiling tiles
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- CT03** Underside of stairs: 16mm GIB Fyrlite lining to underside of timber stair structure in accordance with GIB specification - GBFC60. Fired rated lining to extend through to fire rated wall structure.

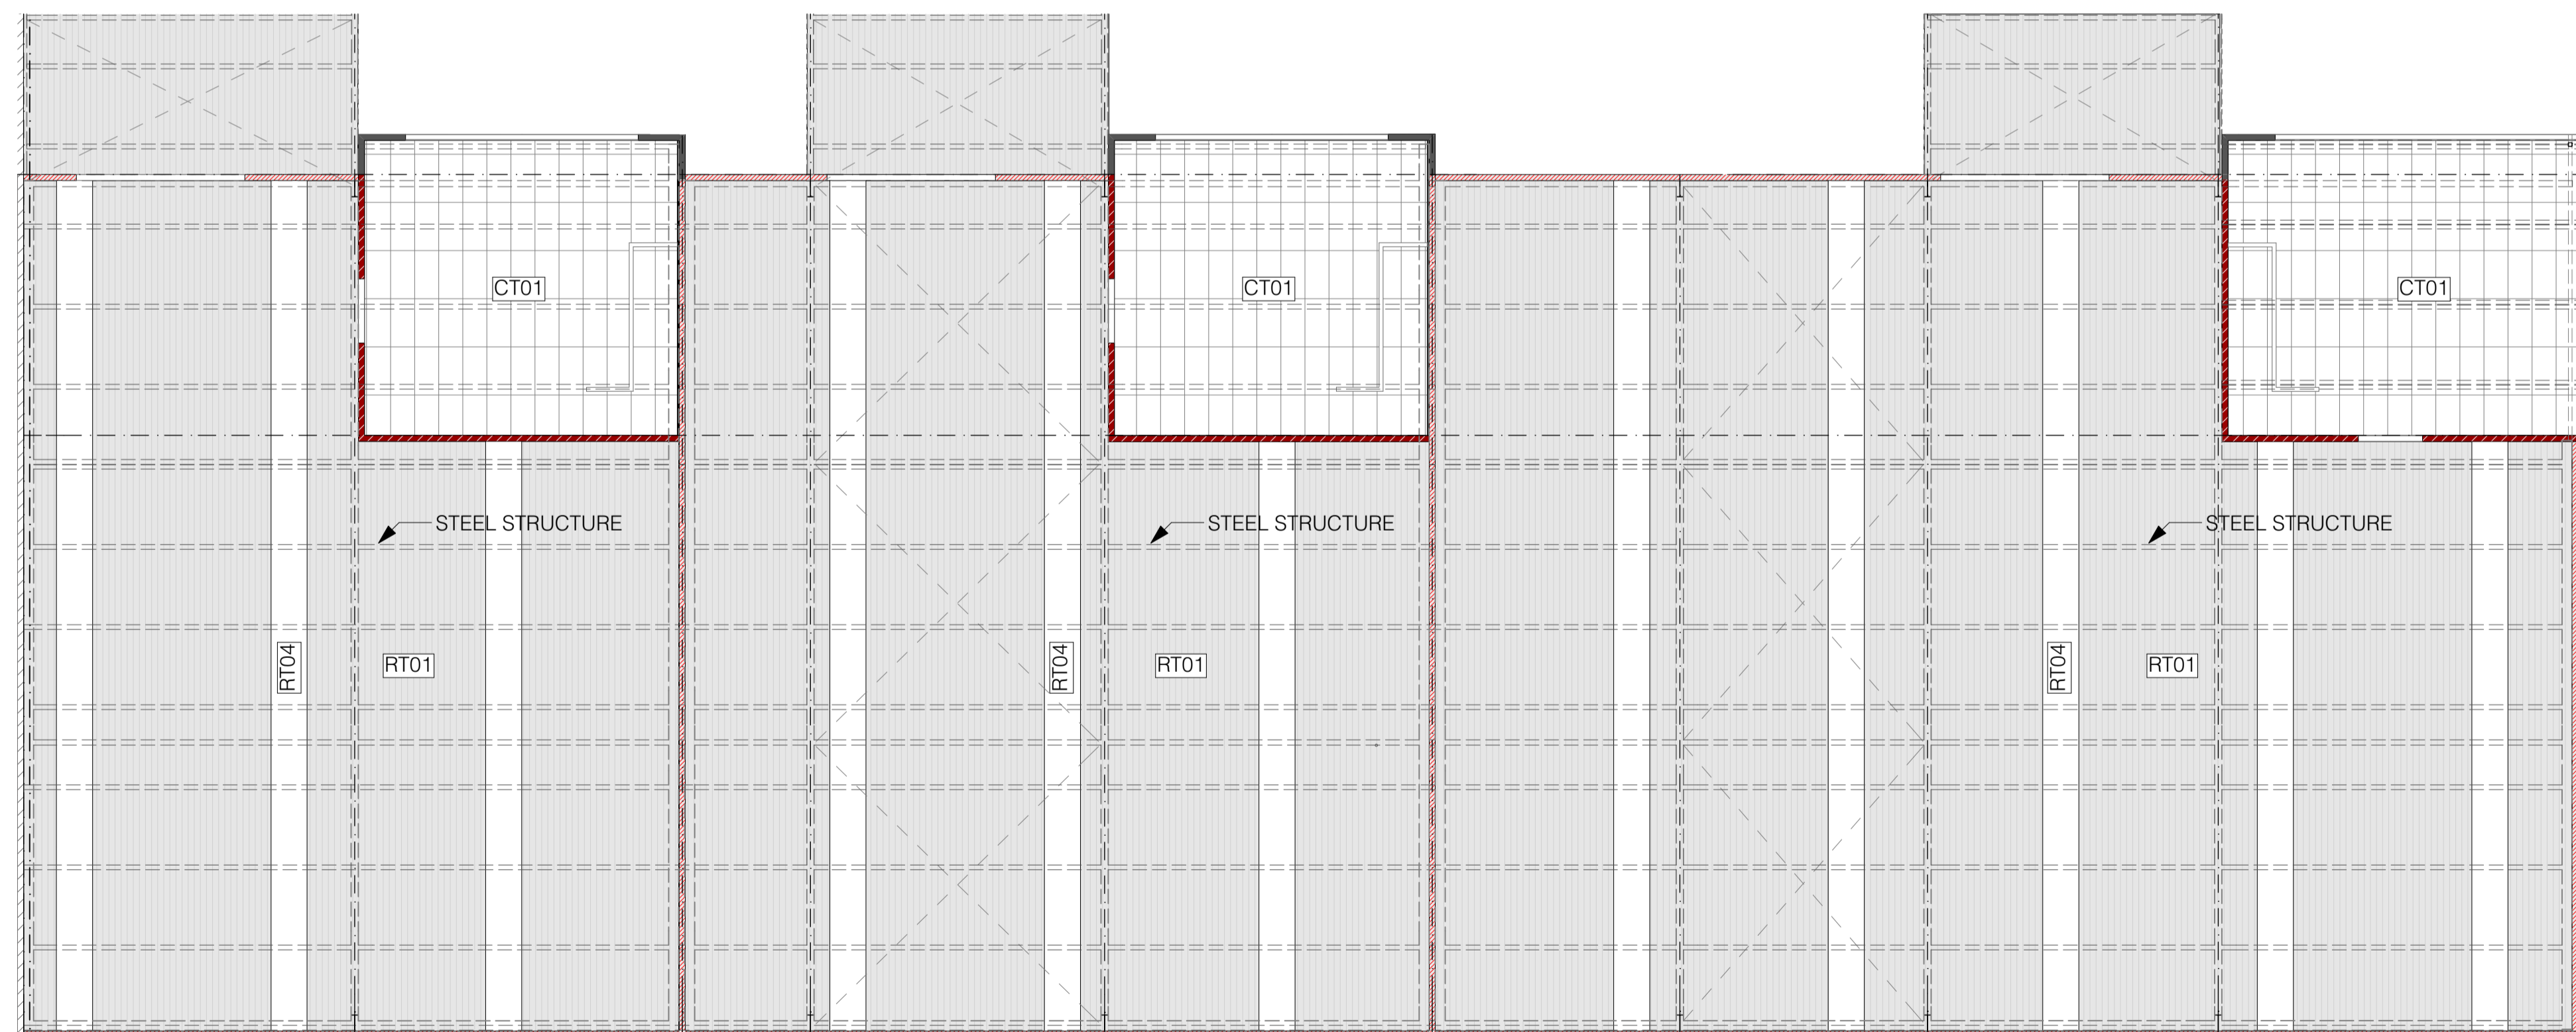

PROPOSED WAREHOUSE CEILING FINISHES - BUILDING 01 - 03
SCALE 1:125 @ A1

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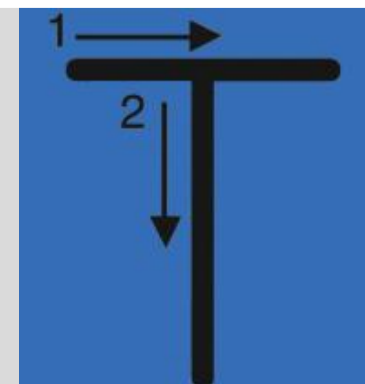
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PROJECT:

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CLIENT: Fosters Construction
SITE: Te Rapa Industrial Park, Hamilton

DRAWING TITLE:

PROPOSED CEILING FINISHES -
WAREHOUSE

PROJECT REF:

T0424 TE RAPA S2

DATE:

25/06/19

SHEET:


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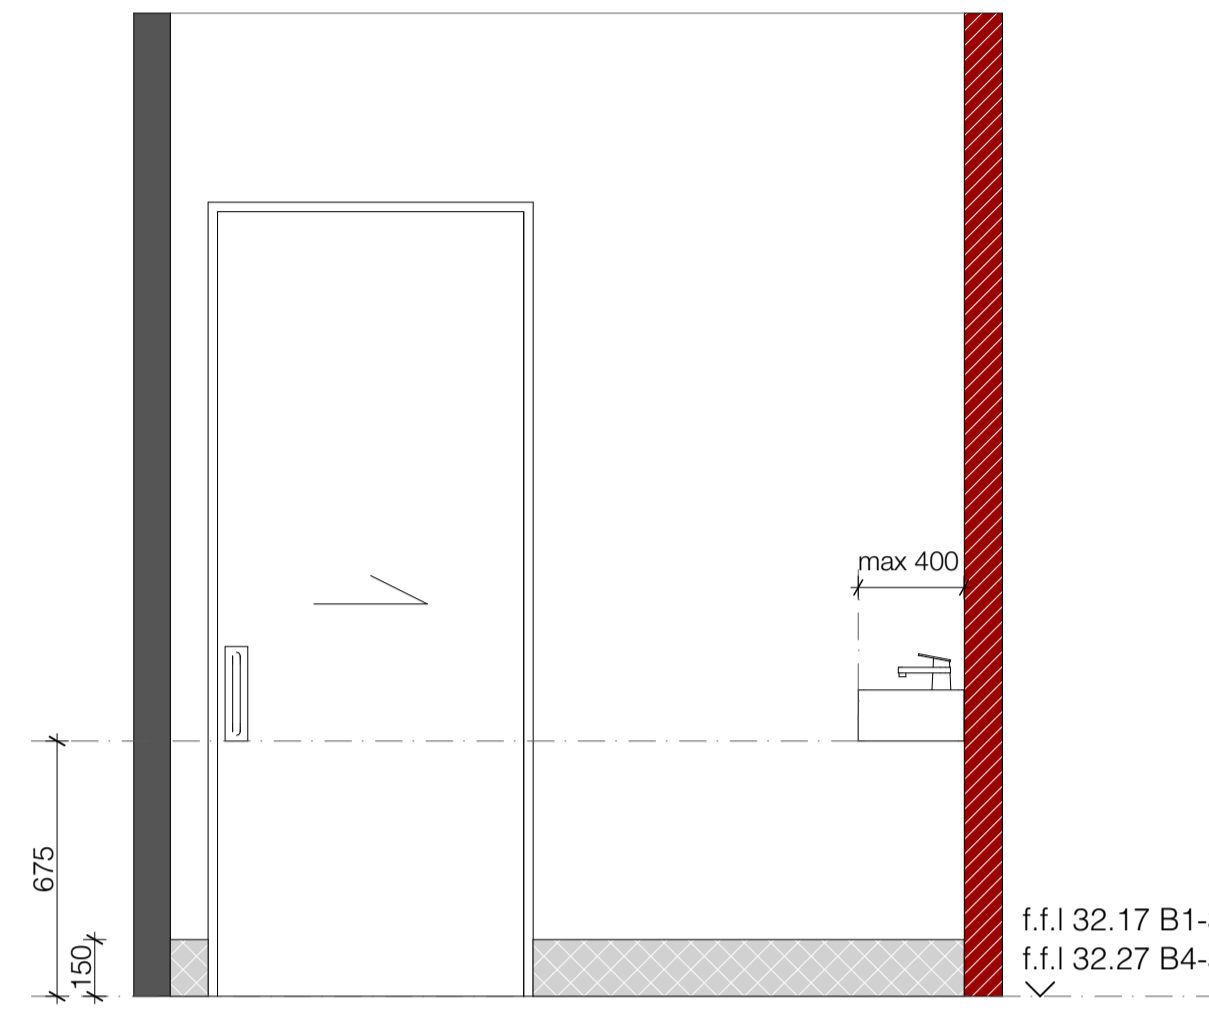
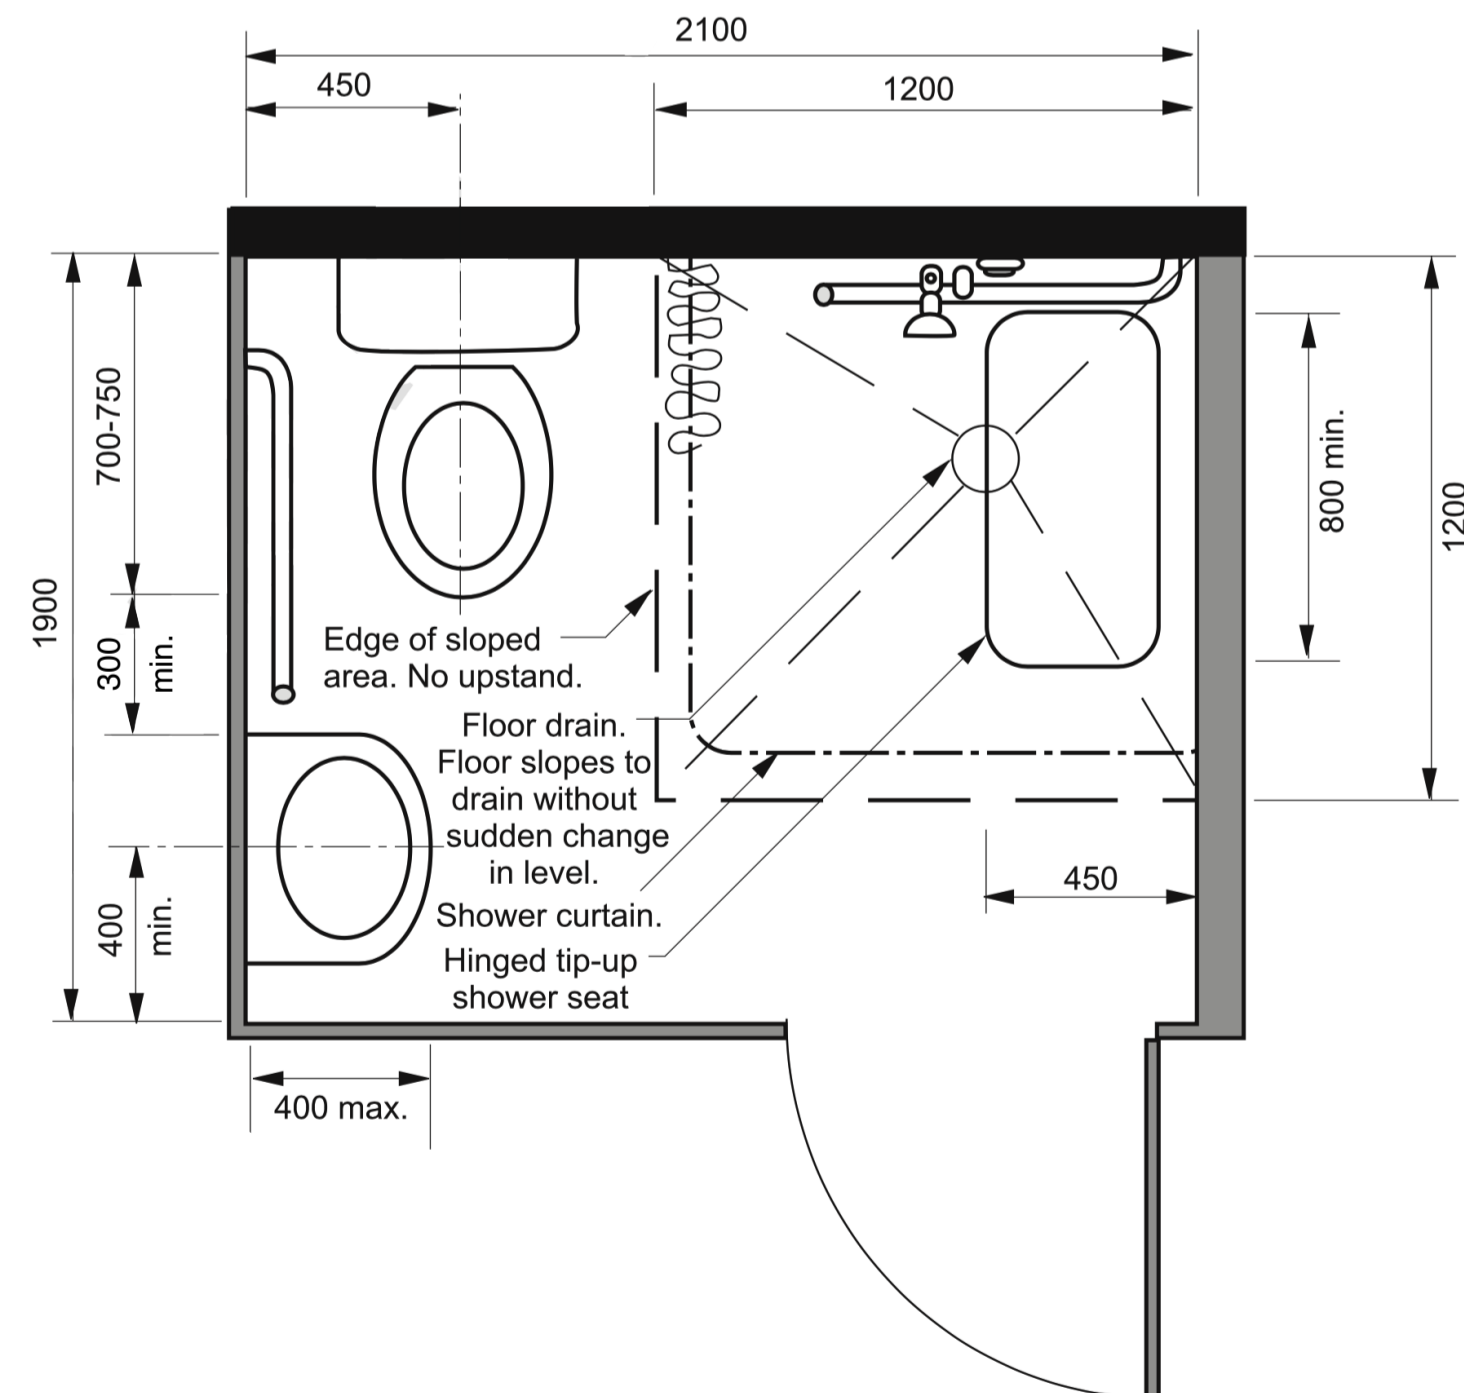
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REV:


C01




TYPICAL ACCESSIBLE BATHROOM PLAN
SCALE 1:10 @ A1

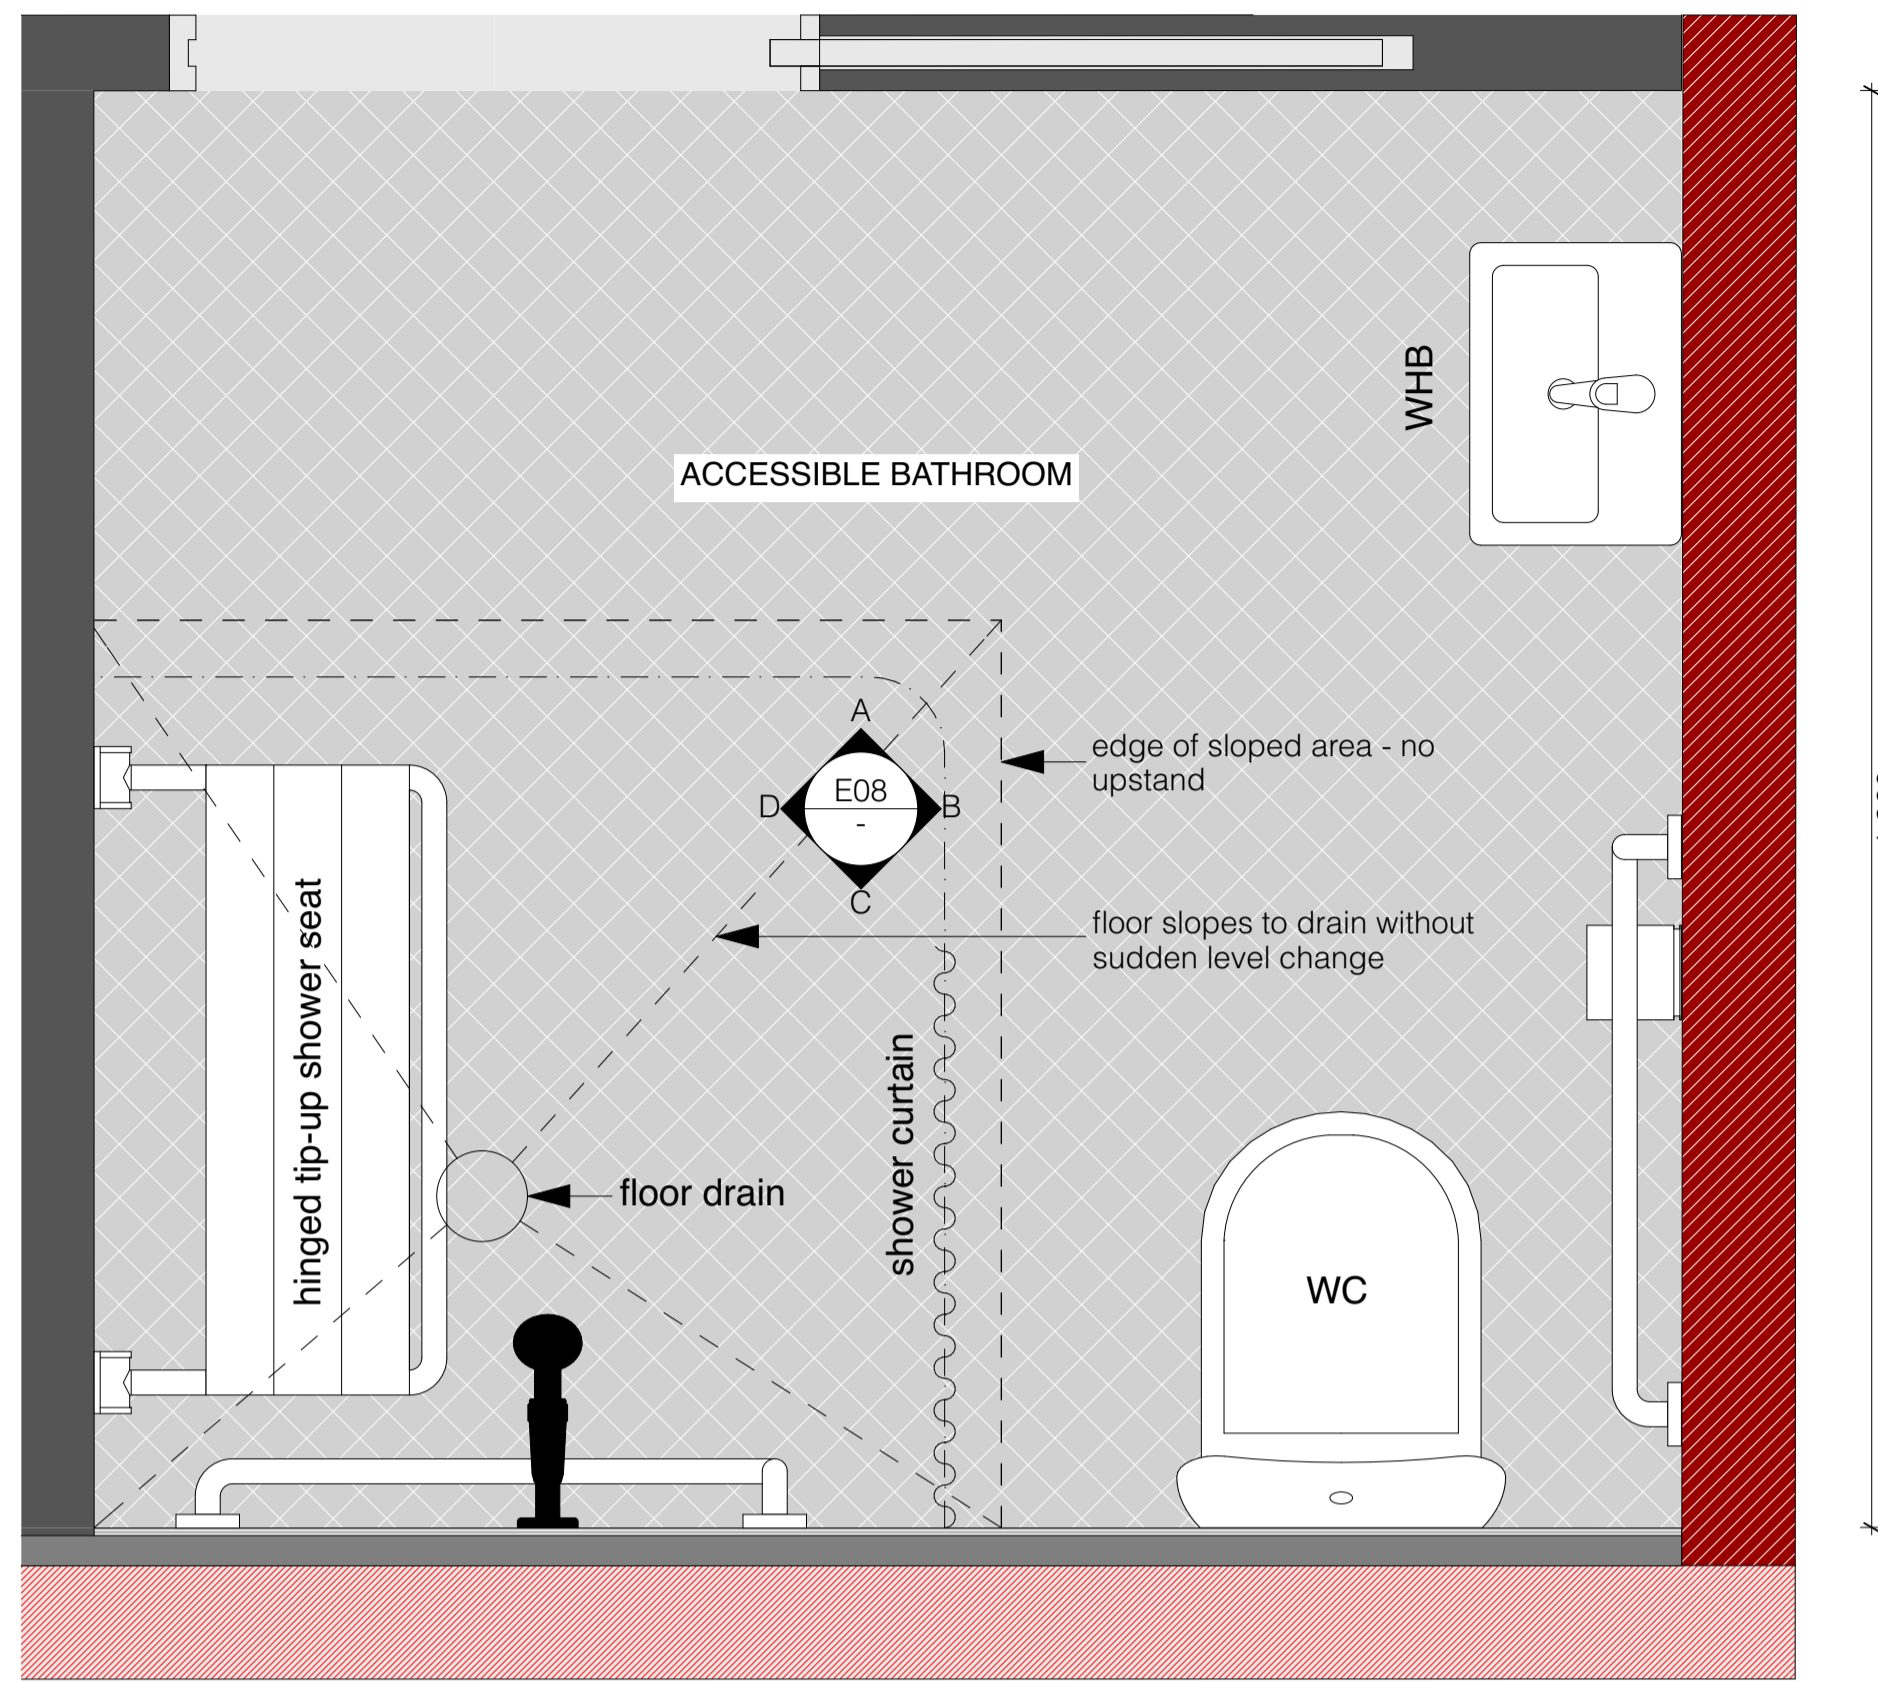


BATHROOM ELEVATION A
SCALE 1:20 @ A1

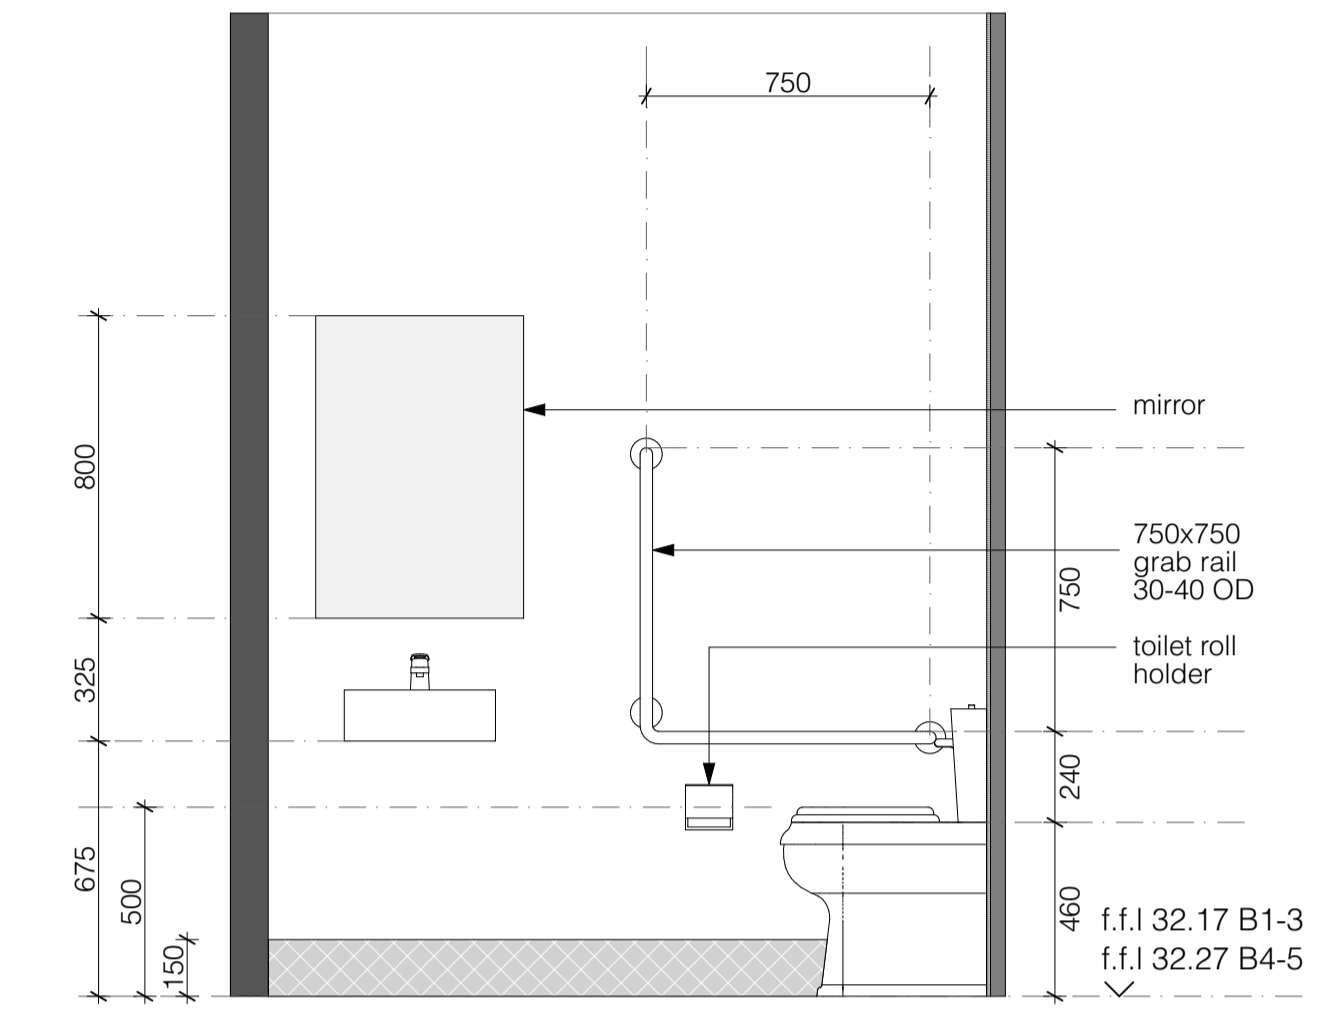

BATHROOM ELEVATION B
SCALE 1:20 @ A1

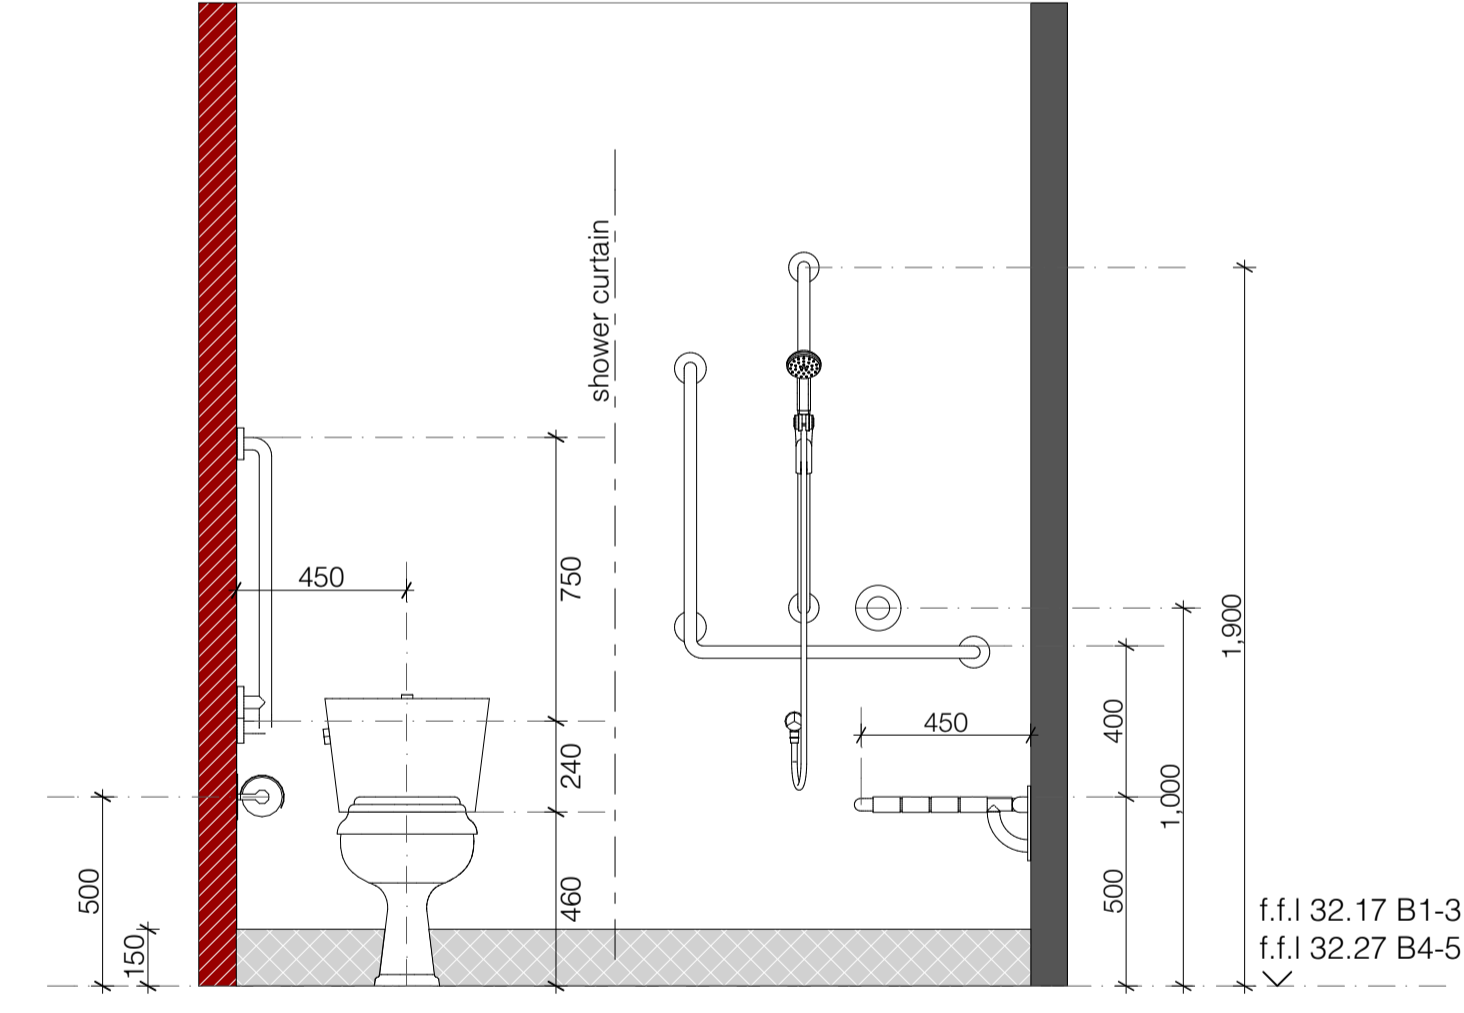

BATHROOM ELEVATION C
SCALE 1:20 @ A1

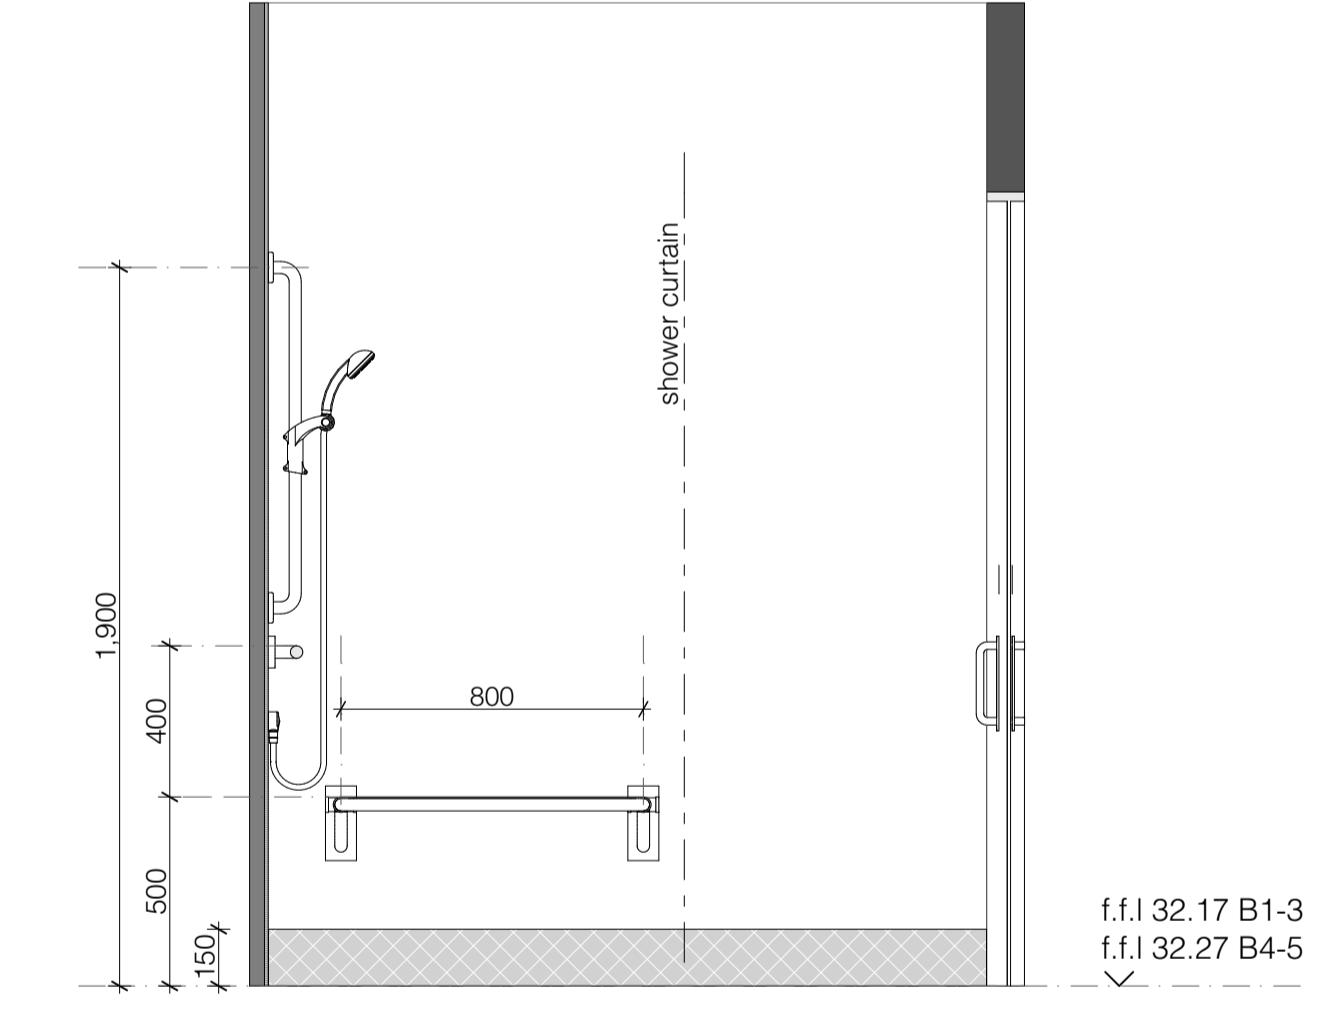

BATHROOM ELEVATION D
SCALE 1:20 @ A1

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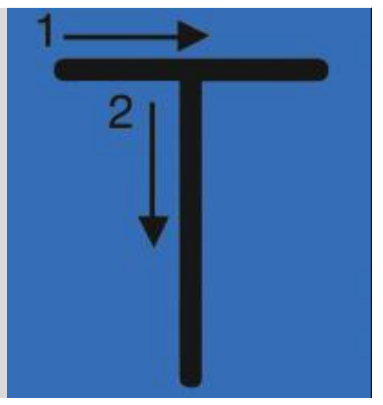
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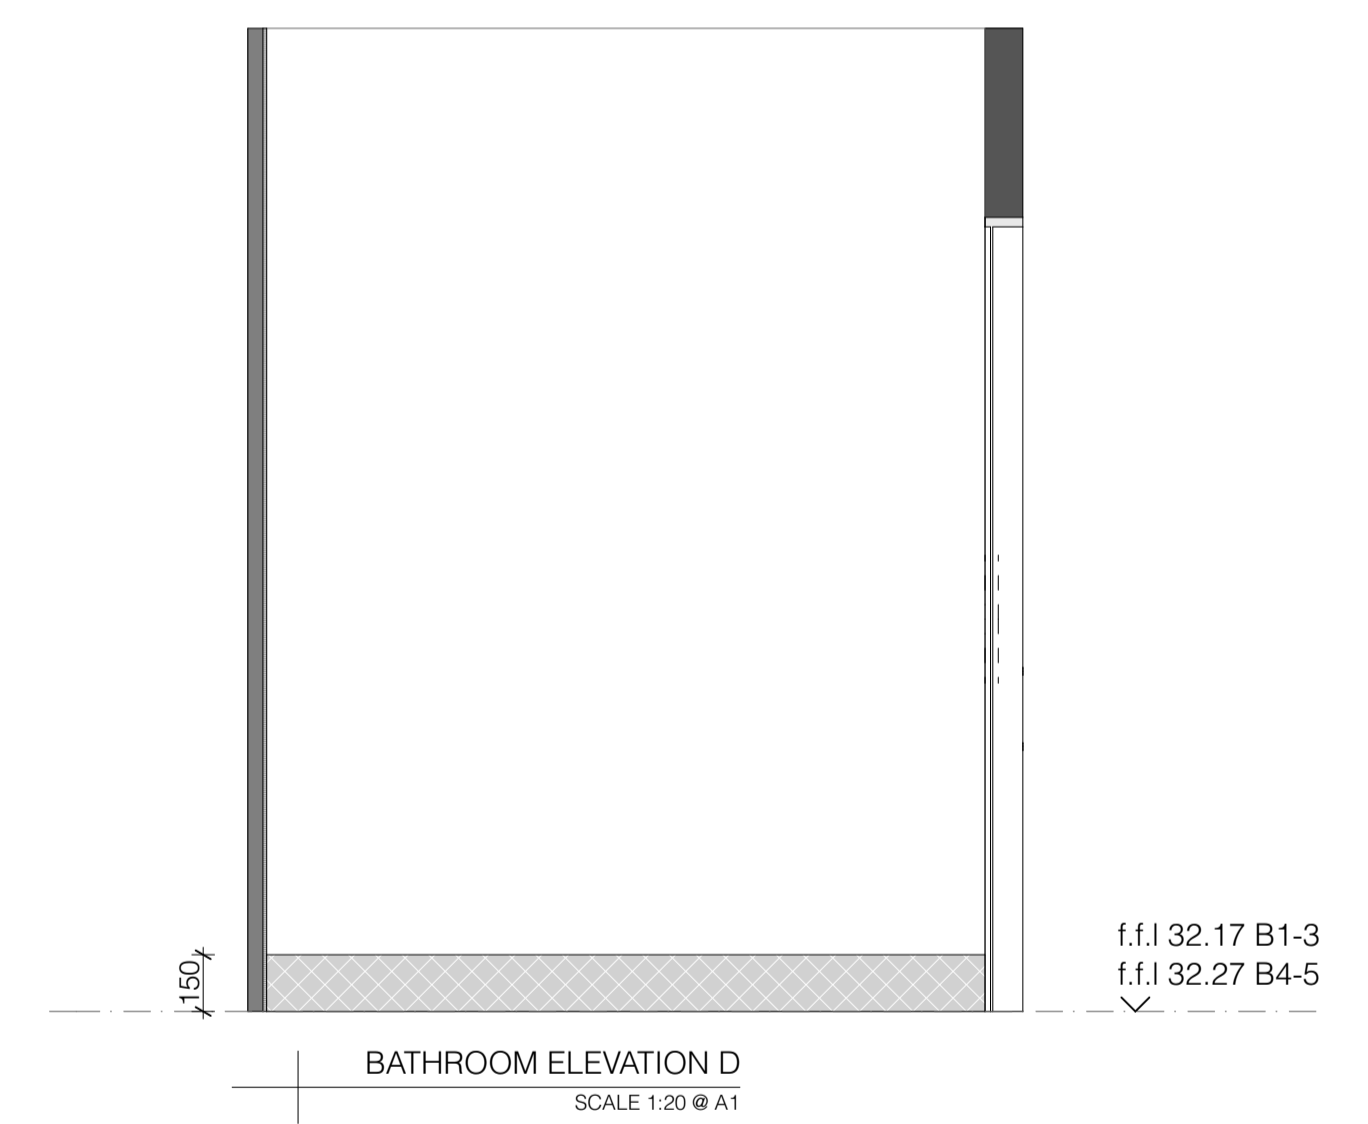
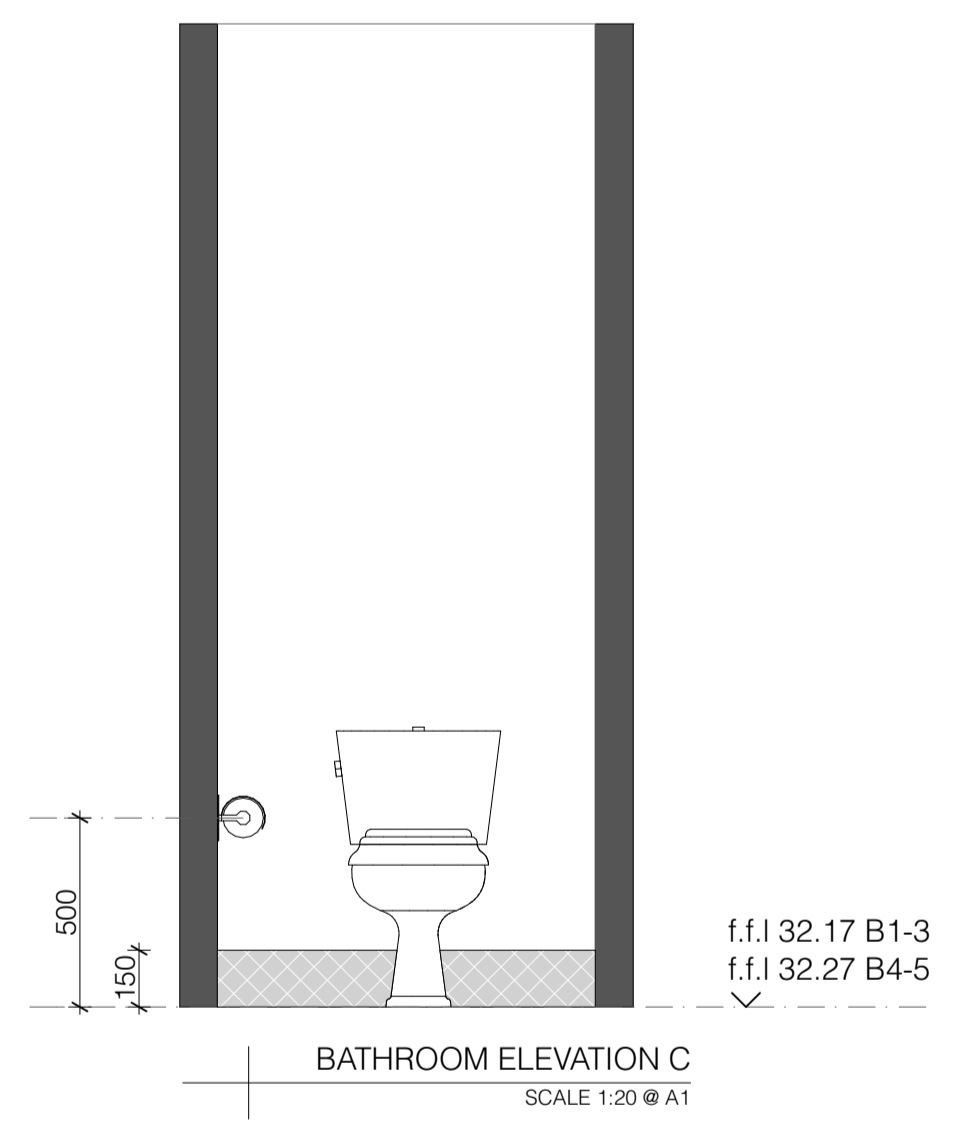
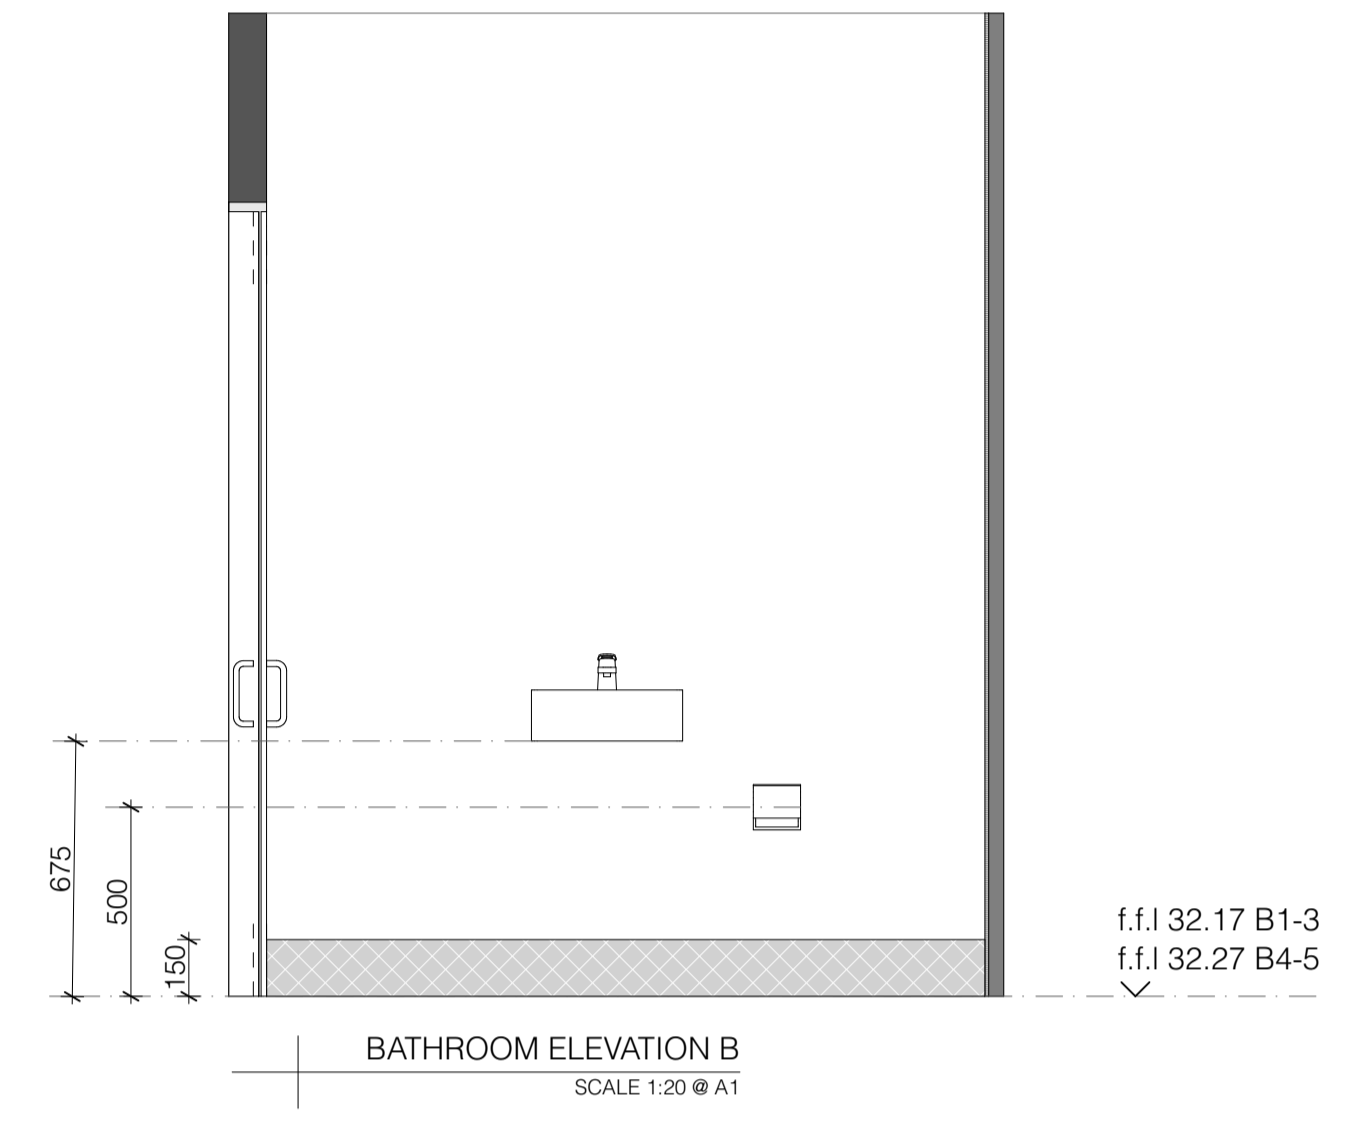
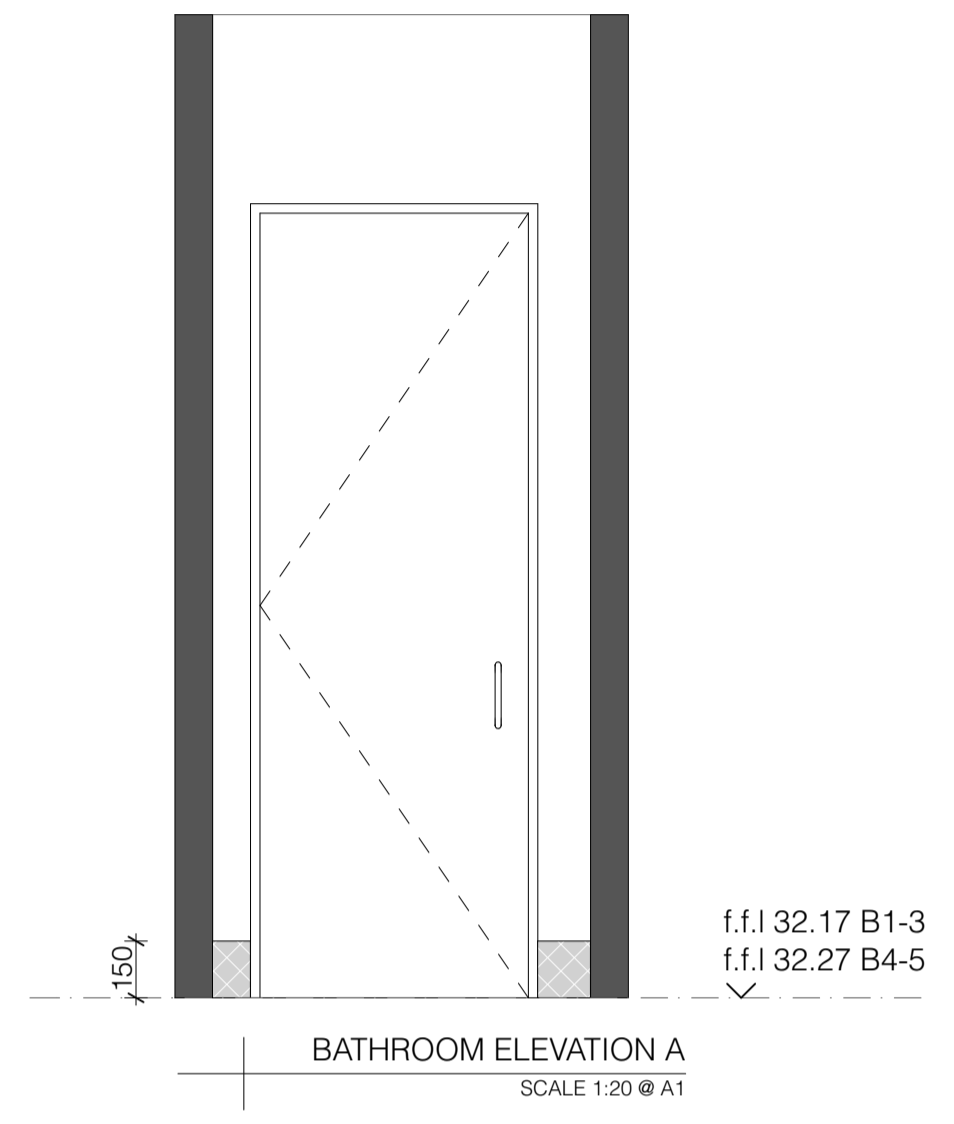
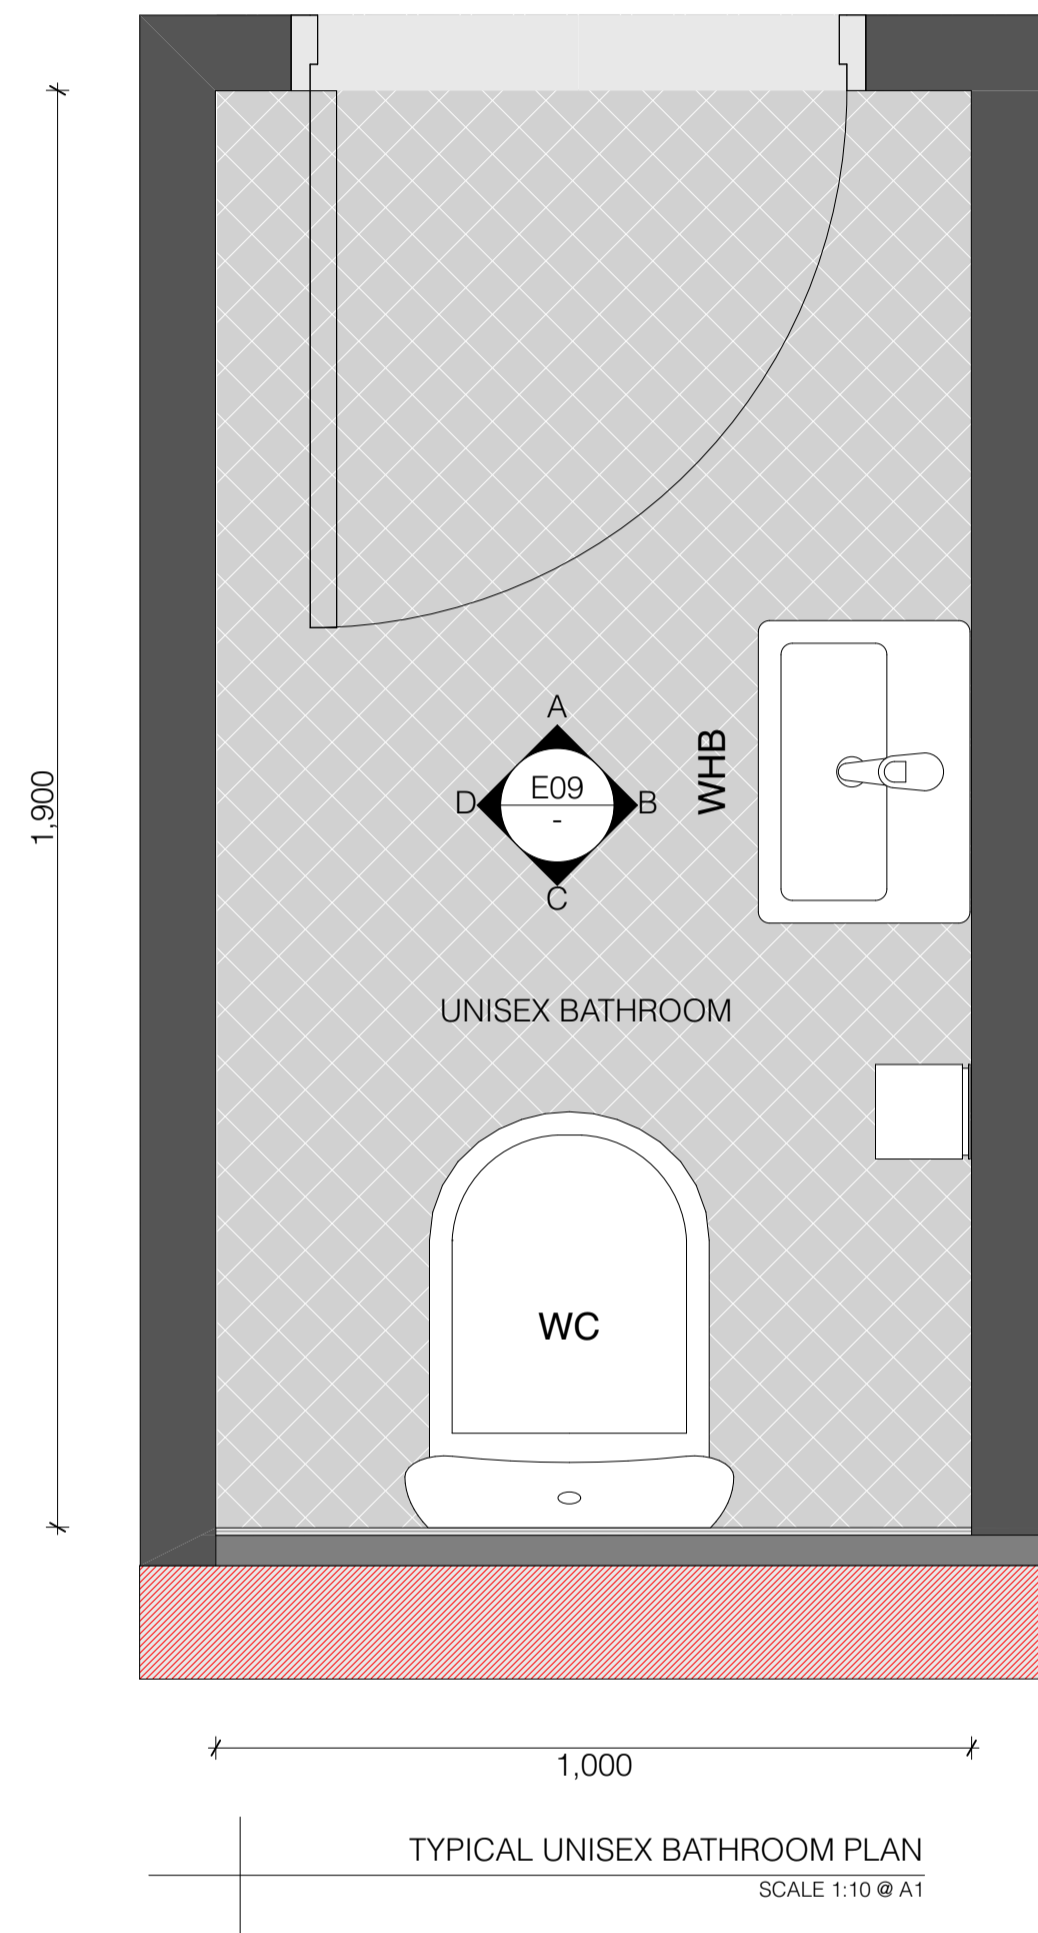


PROJECT: Te Rapa Stage 2

CLIENT: Fosters Construction
SITE: Te Rapa Industrial Park, Hamilton

DRAWING TITLE: TYPICAL ACCESSIBLE BATHROOM

PROJECT REF: T0424 TE RAPA S2	
DATE: 25/06/19	SCALE: 1:20, 1:1.6361 @ A1
SHEET: A27	REV: C01



NOTE:
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CLIENTS:



ISSUE:


C01

DATE:

25/06/19

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PROJECT:

Te Rapa Stage 2

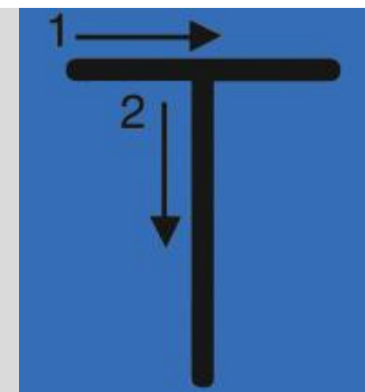CLIENT: Fosters Construction
SITE: Te Rapa Industrial Park, Hamilton

FOR CONSTRUCTION ISSUE

DRAWING TITLE:

TYPICAL UNISEX BATHROOM

PROJECT REF:

T0424 TE RAPA S2

DATE:

25/06/19

SCALE:


1:10, 1:20 @ A1

SHEET:


A28

REV:

C01

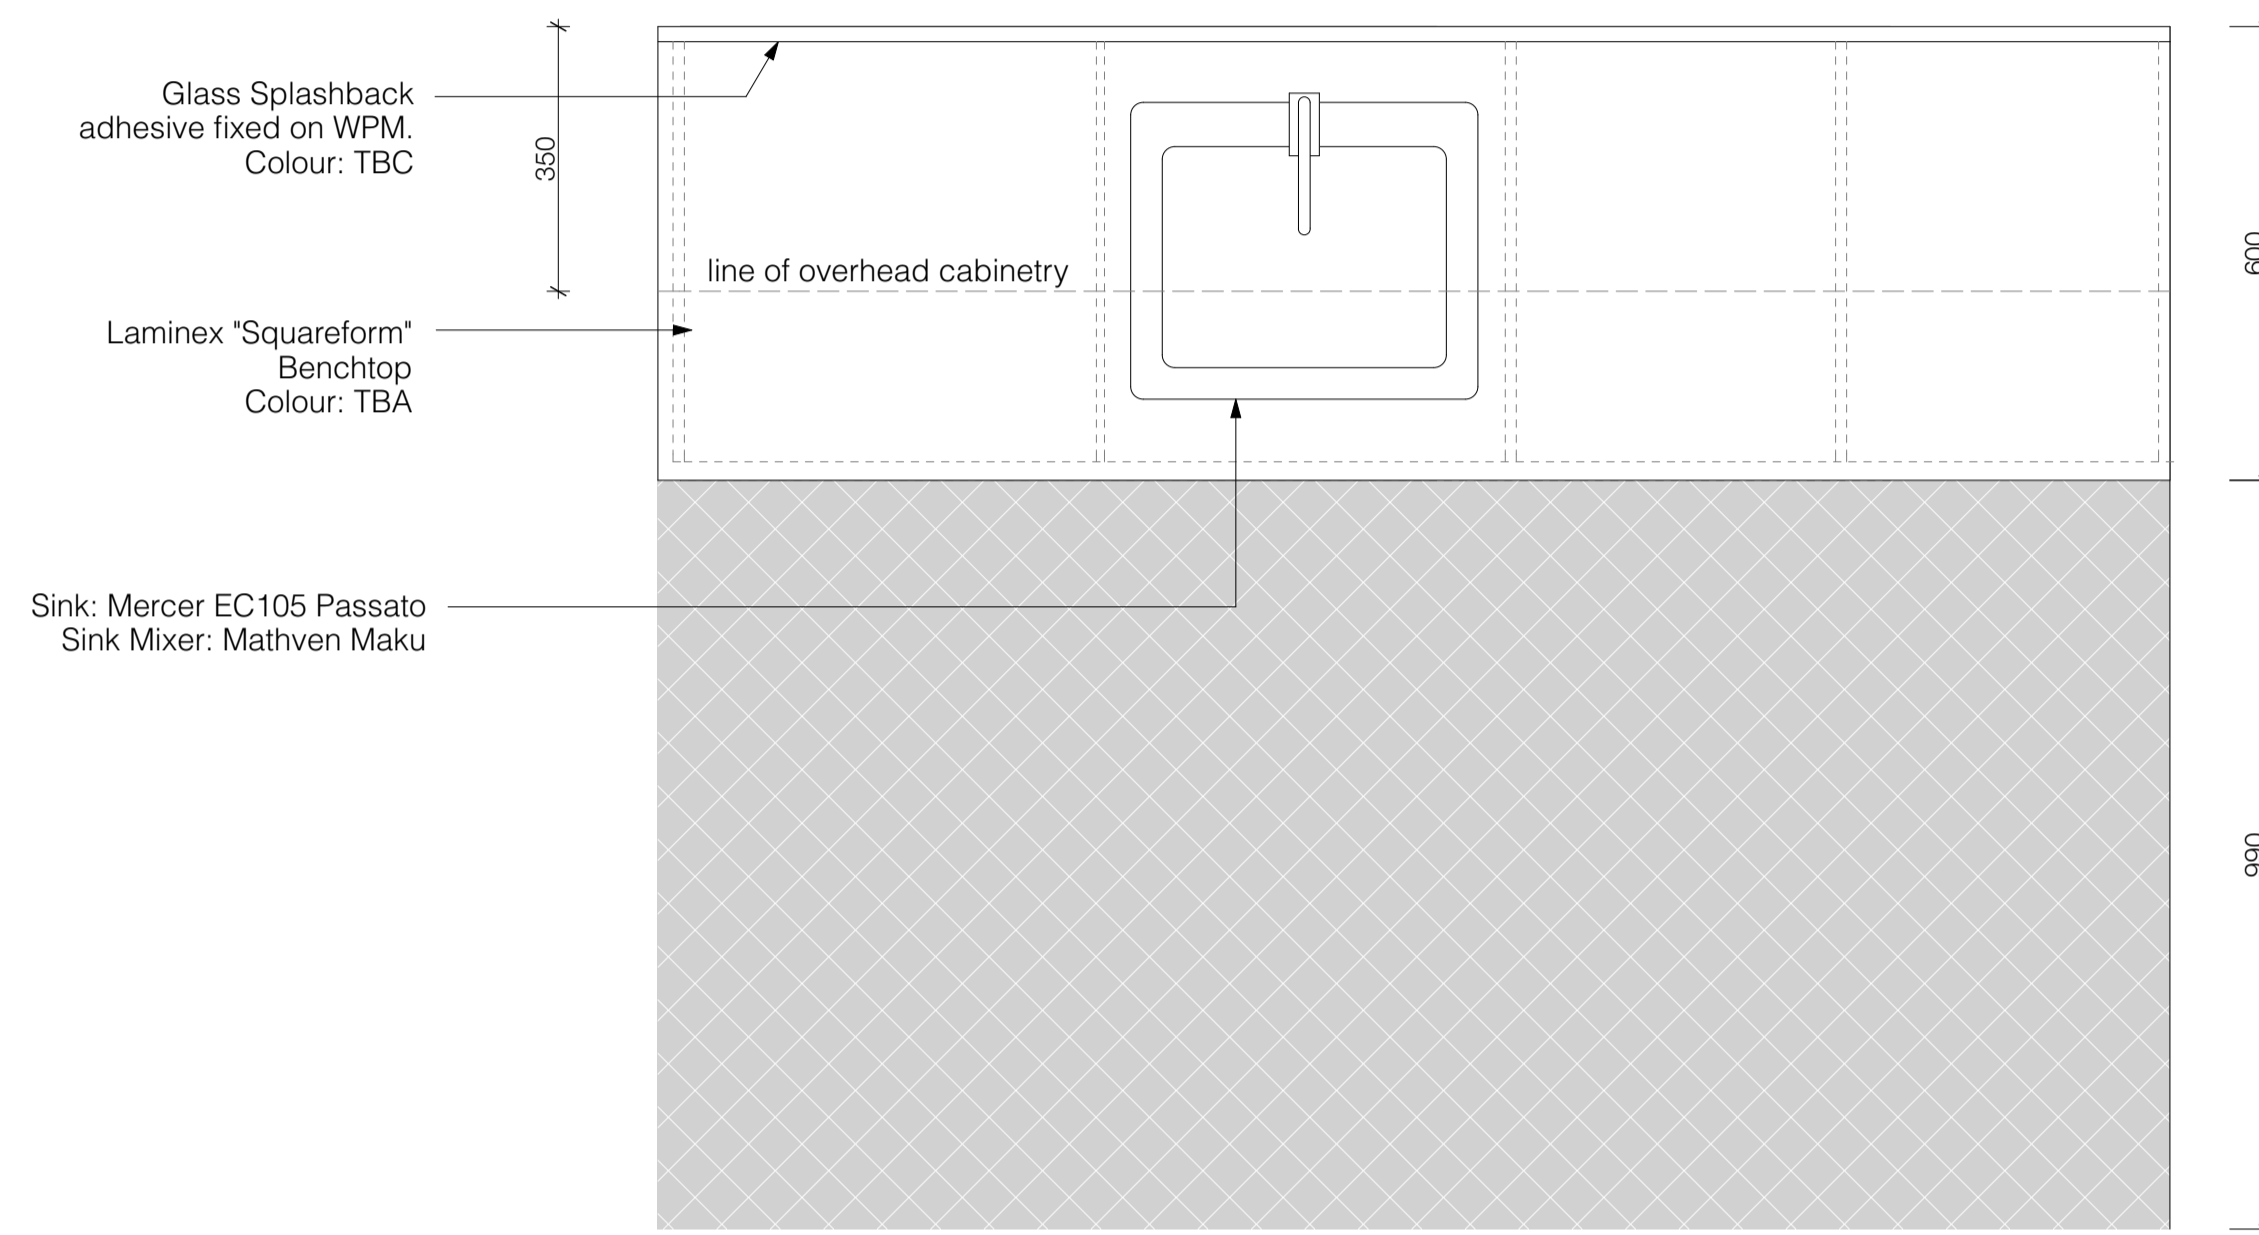

KITCHEN CABINET PLAN AND ELEVATION
SCALE 1:10 @ A1

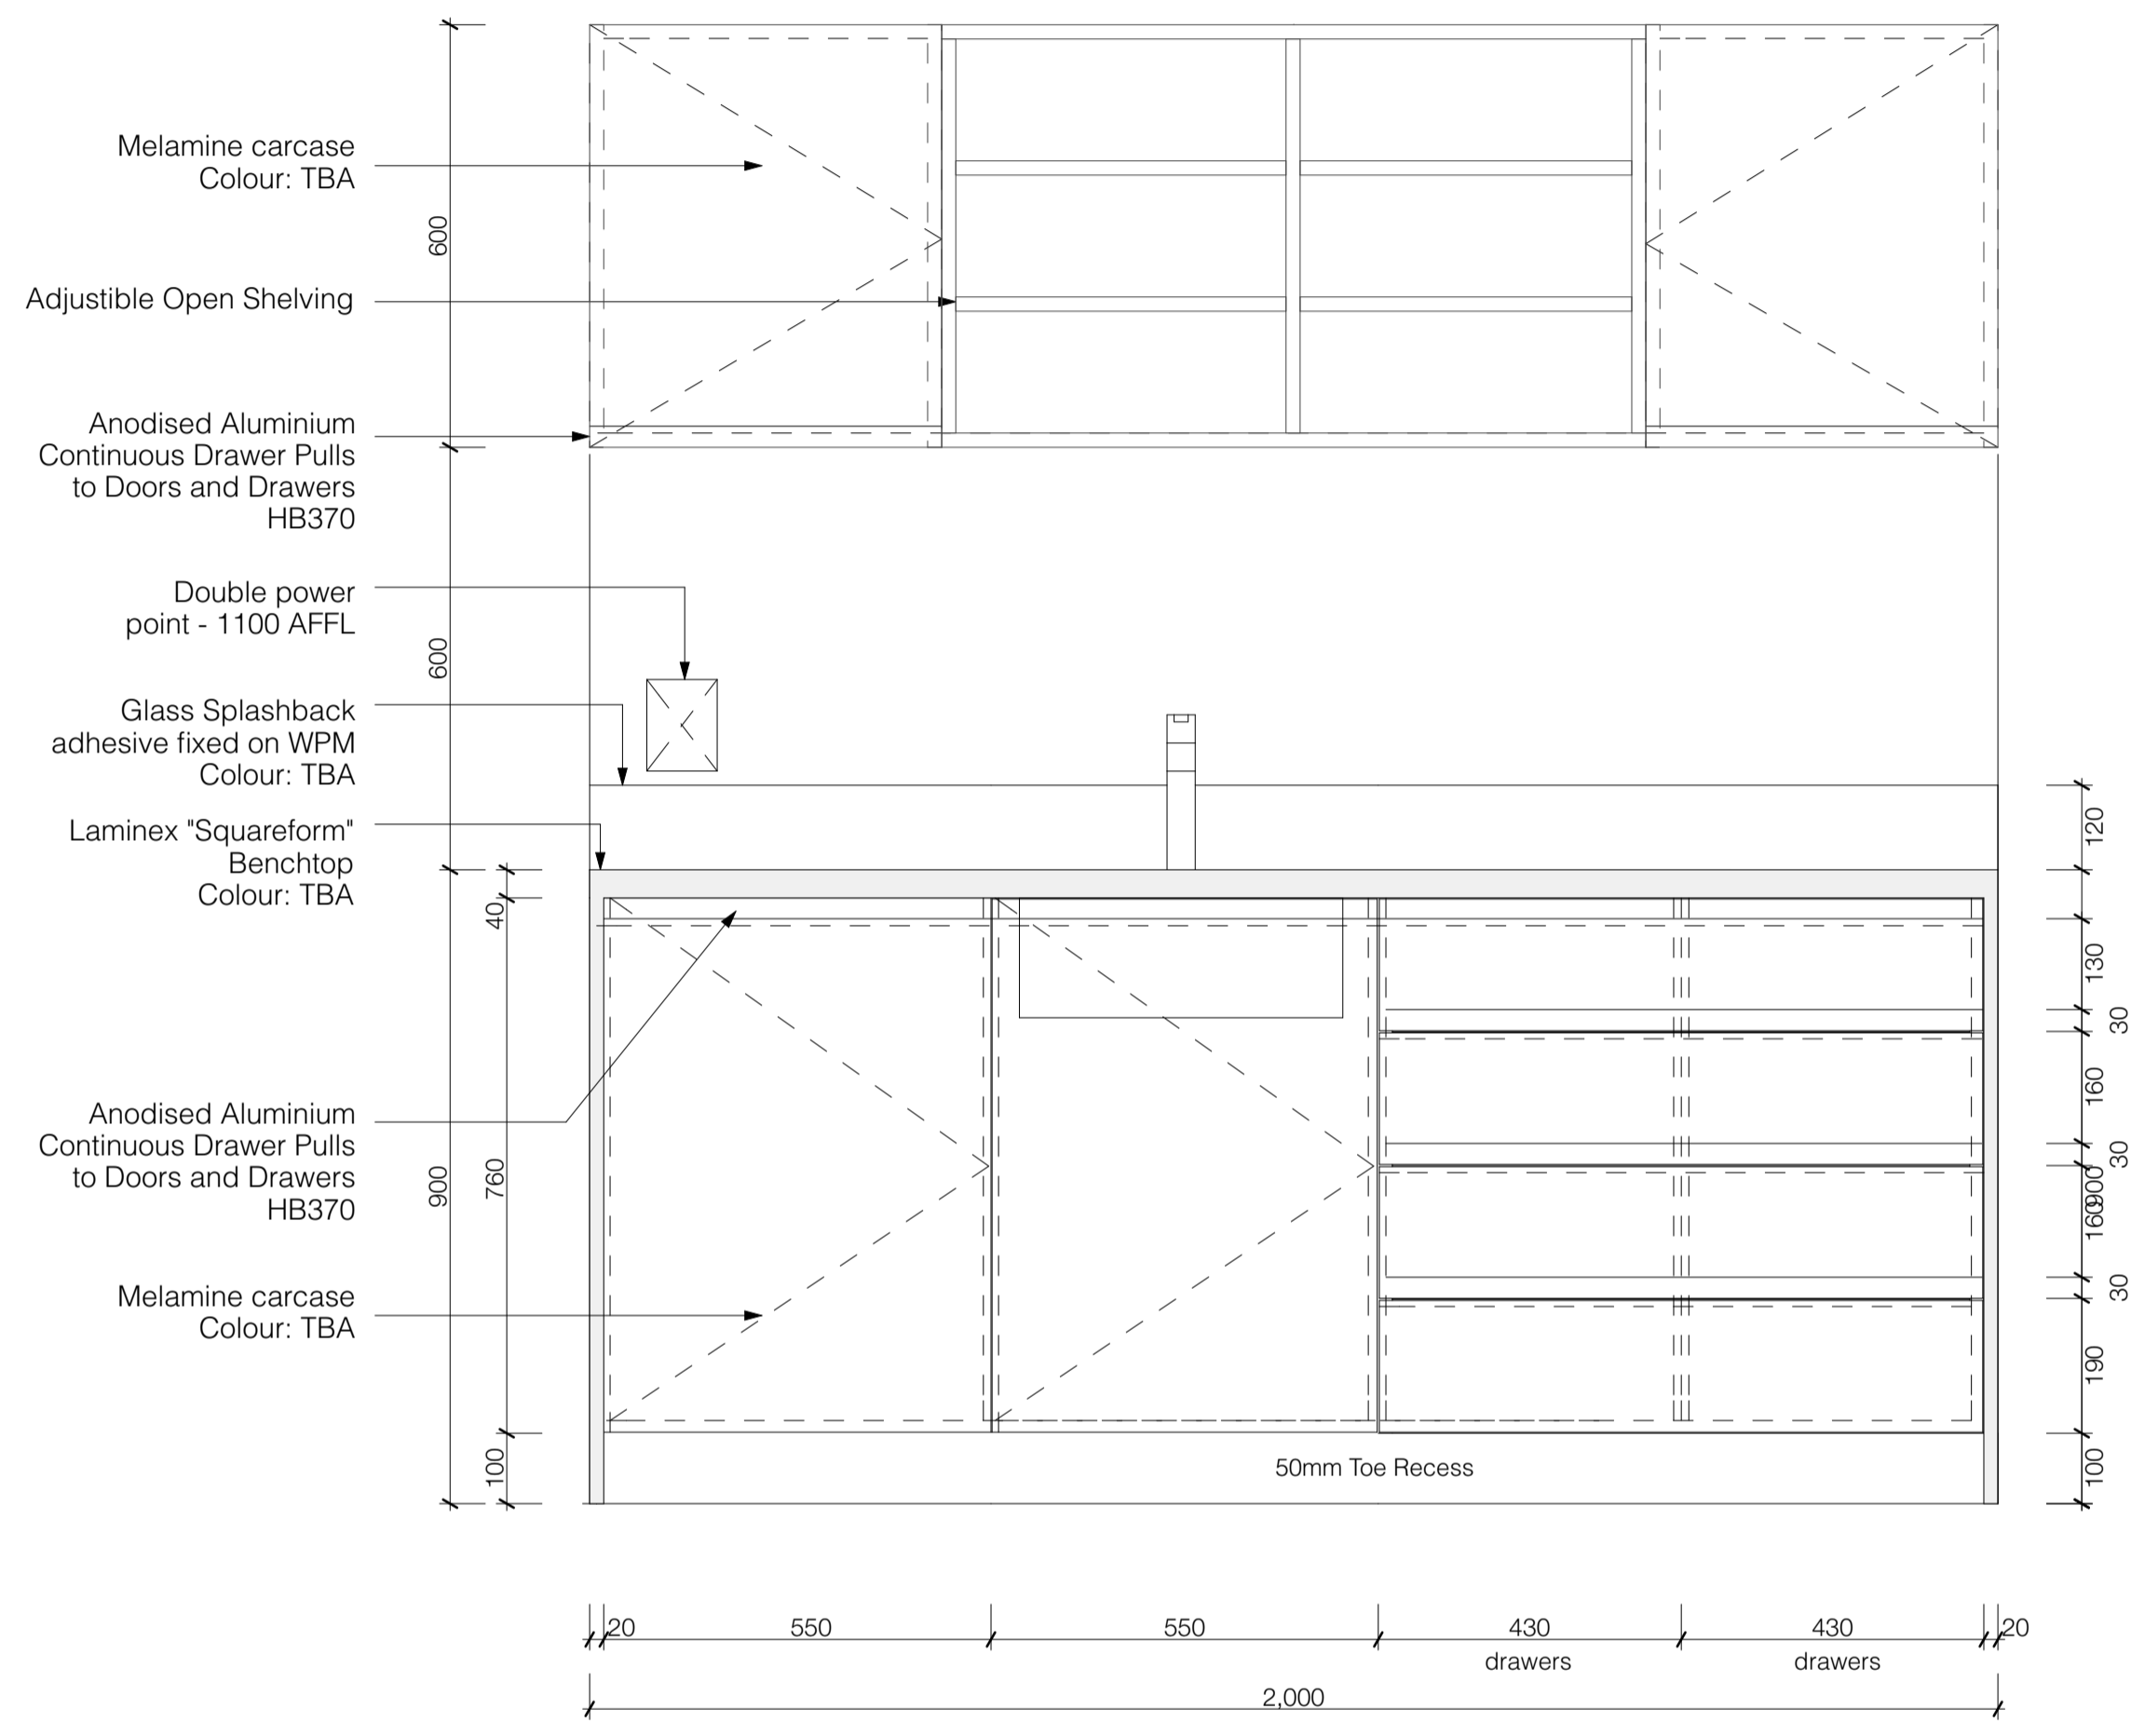

FOR CONSTRUCTION ISSUE

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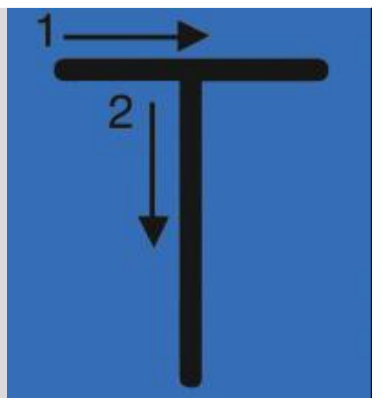
TE RAPA GATEWAY

FOSTER CONSTRUCTION

ISSUE:	DATE:
C01	25/06/19

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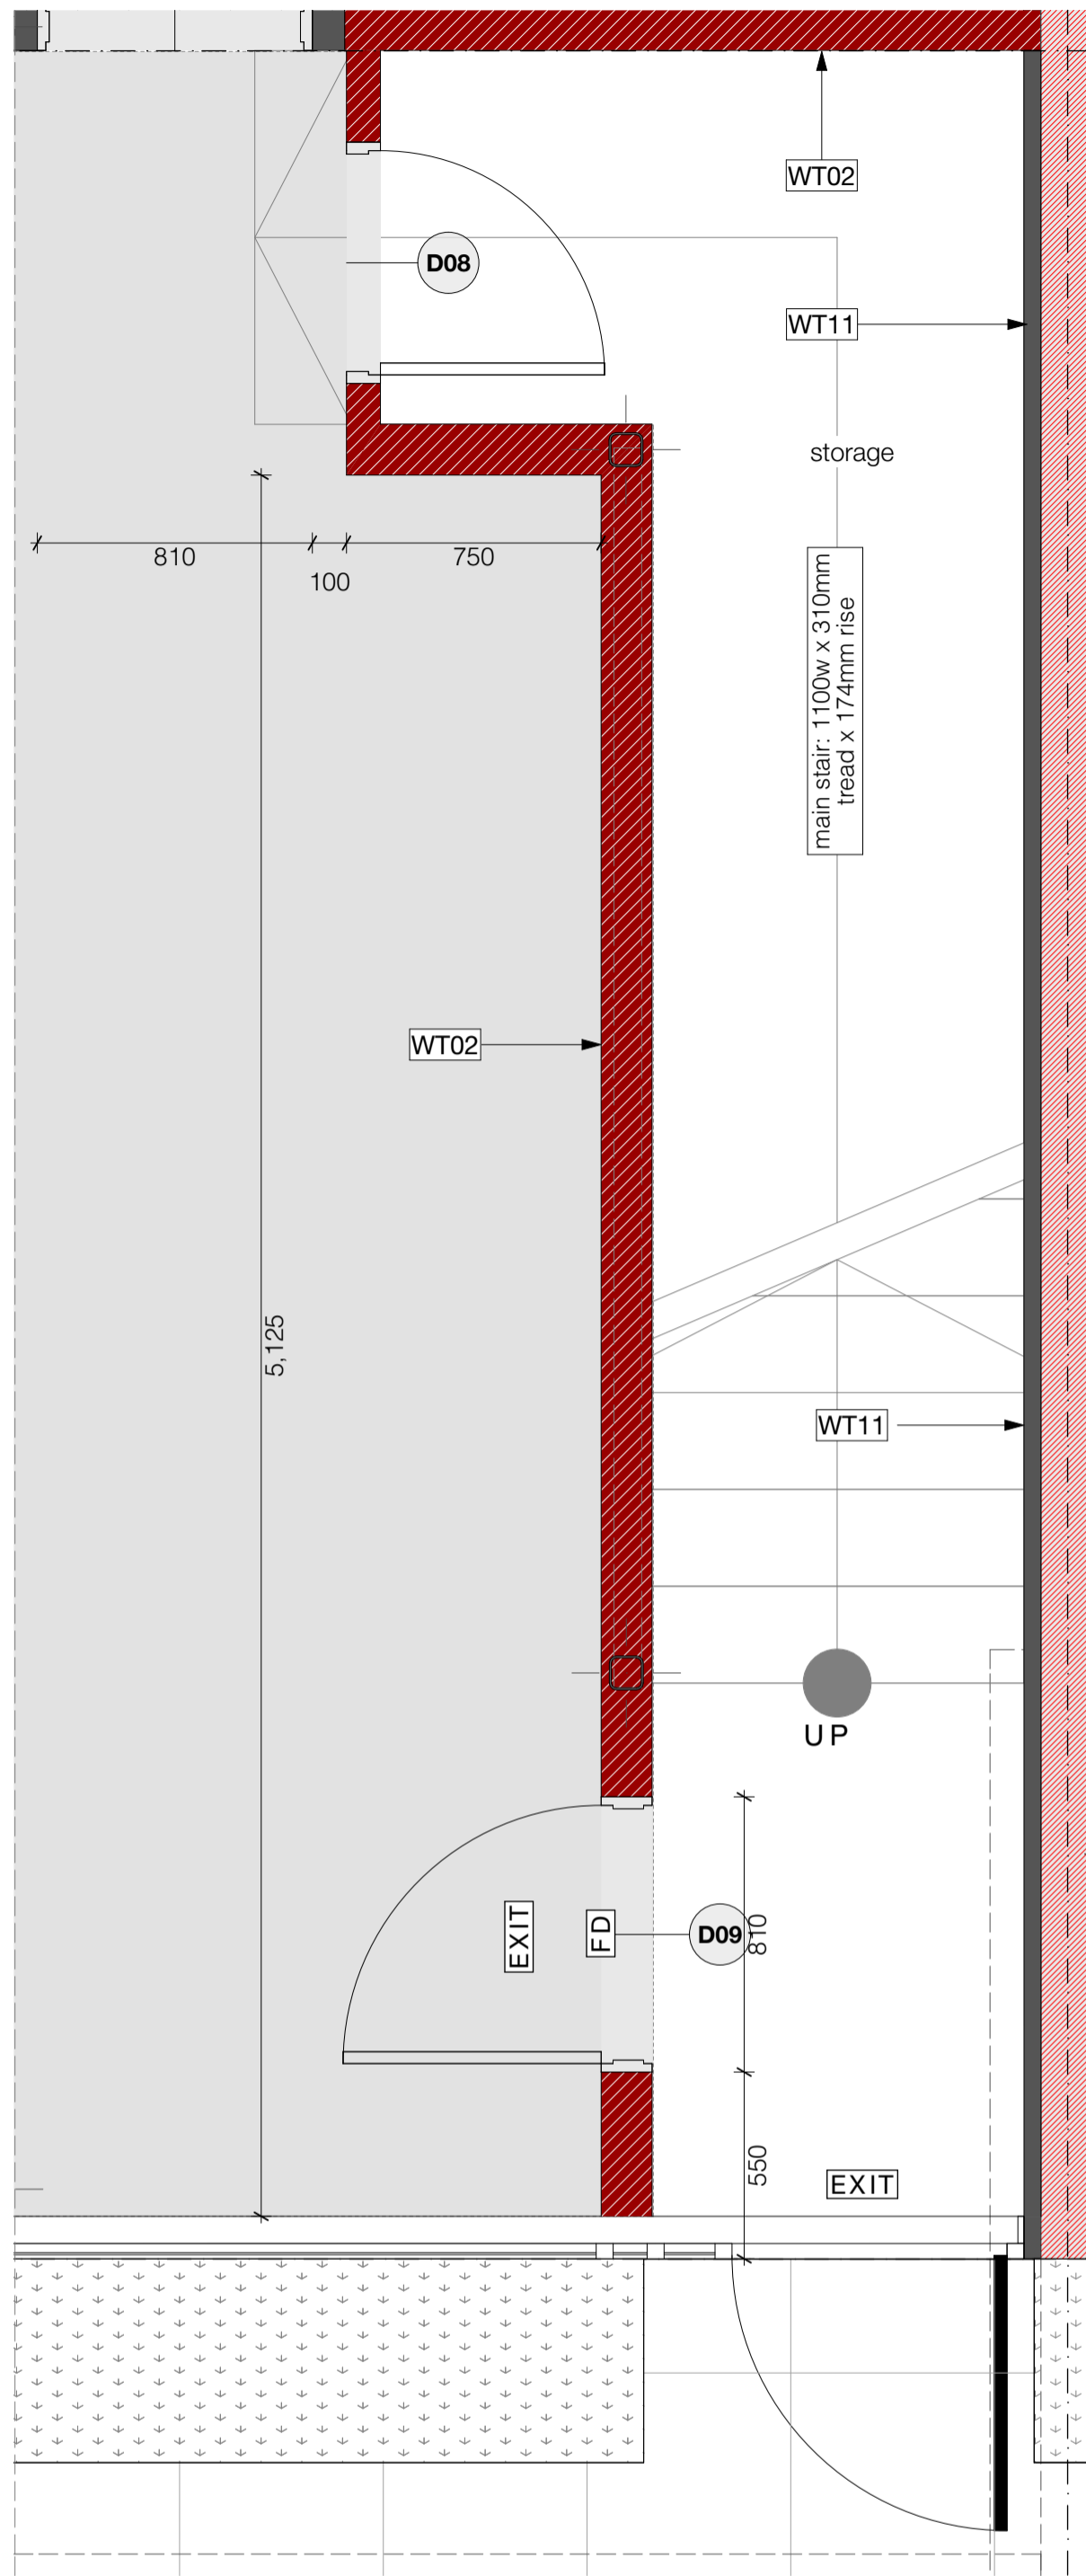


PROJECT:
Te Rapa Stage 2


CLIENT: Fosters Construction
SITE: Te Rapa Industrial Park, Hamilton

DRAWING TITLE:
TYPICAL KITCHEN


PROJECT REF: T0424 TE RAPA S2	
DATE: 25/06/19	SCALE: 1:10 @ A1
SHEET: A29	REV: C01




TYPICAL MAIN STAIR PLAN
SCALE 1:20 @ A1

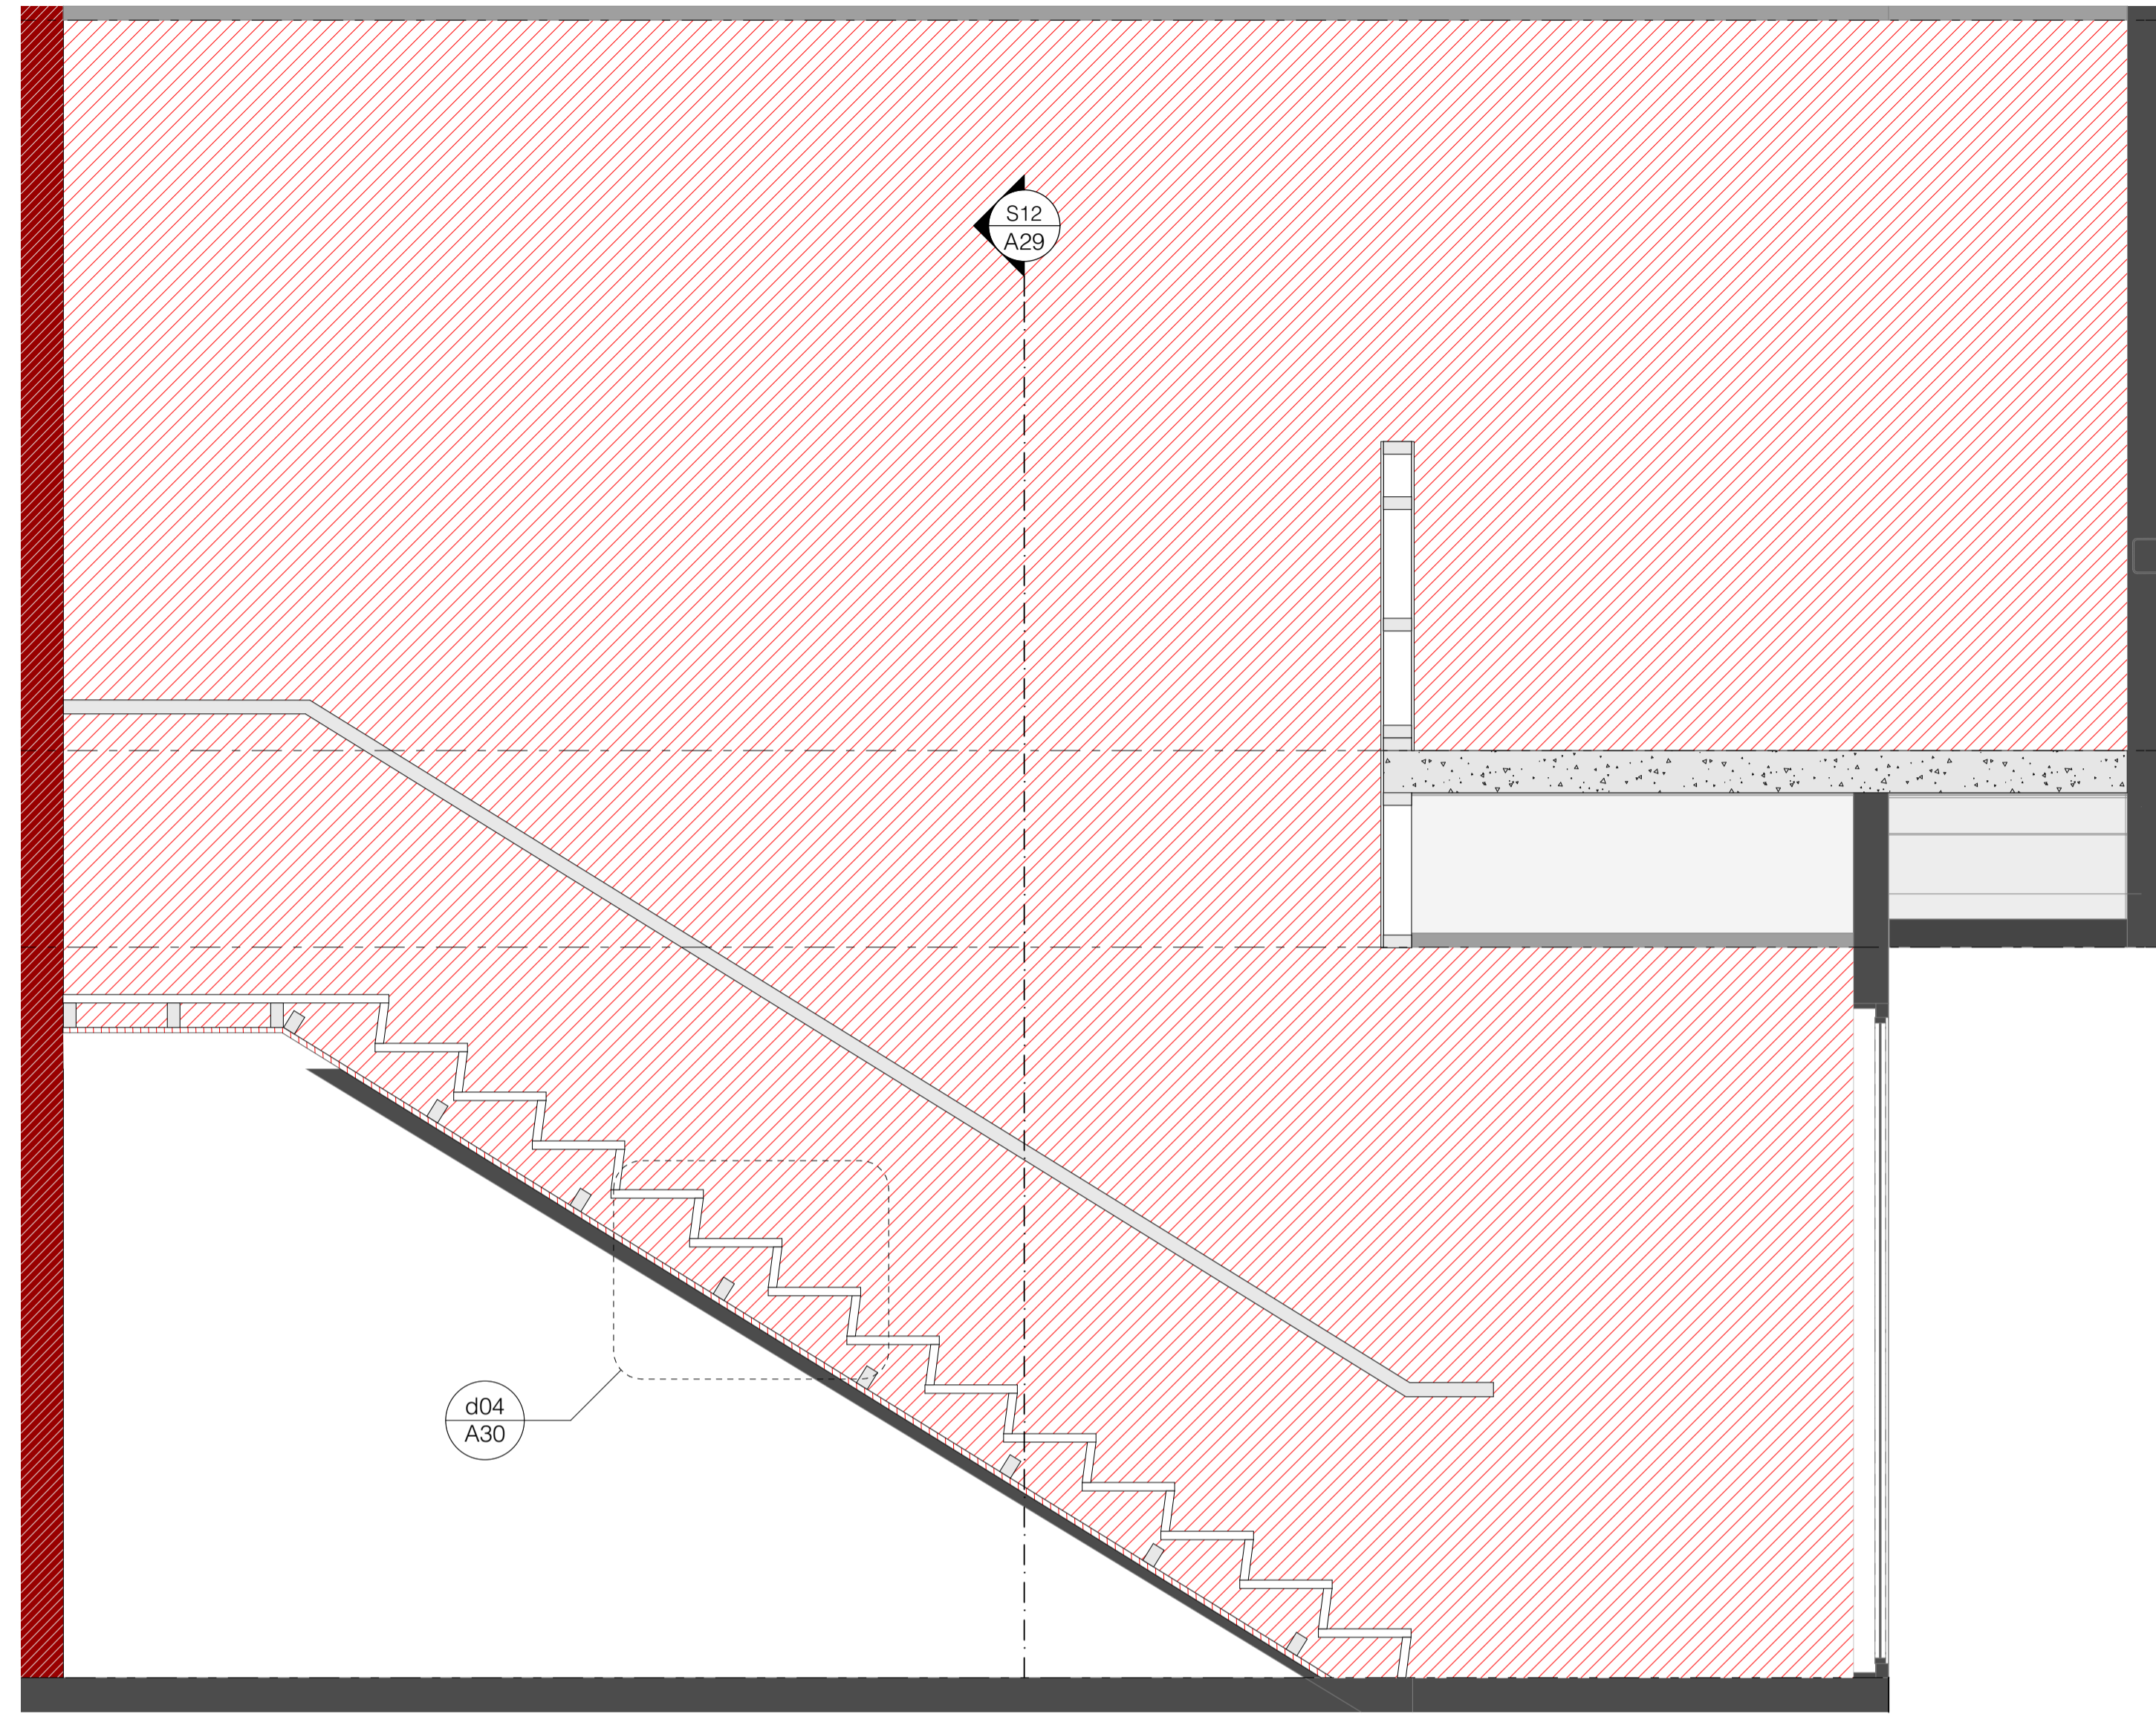

S11
A30
MAIN STAIR SECTION 11
SCALE 1:20 @ A1

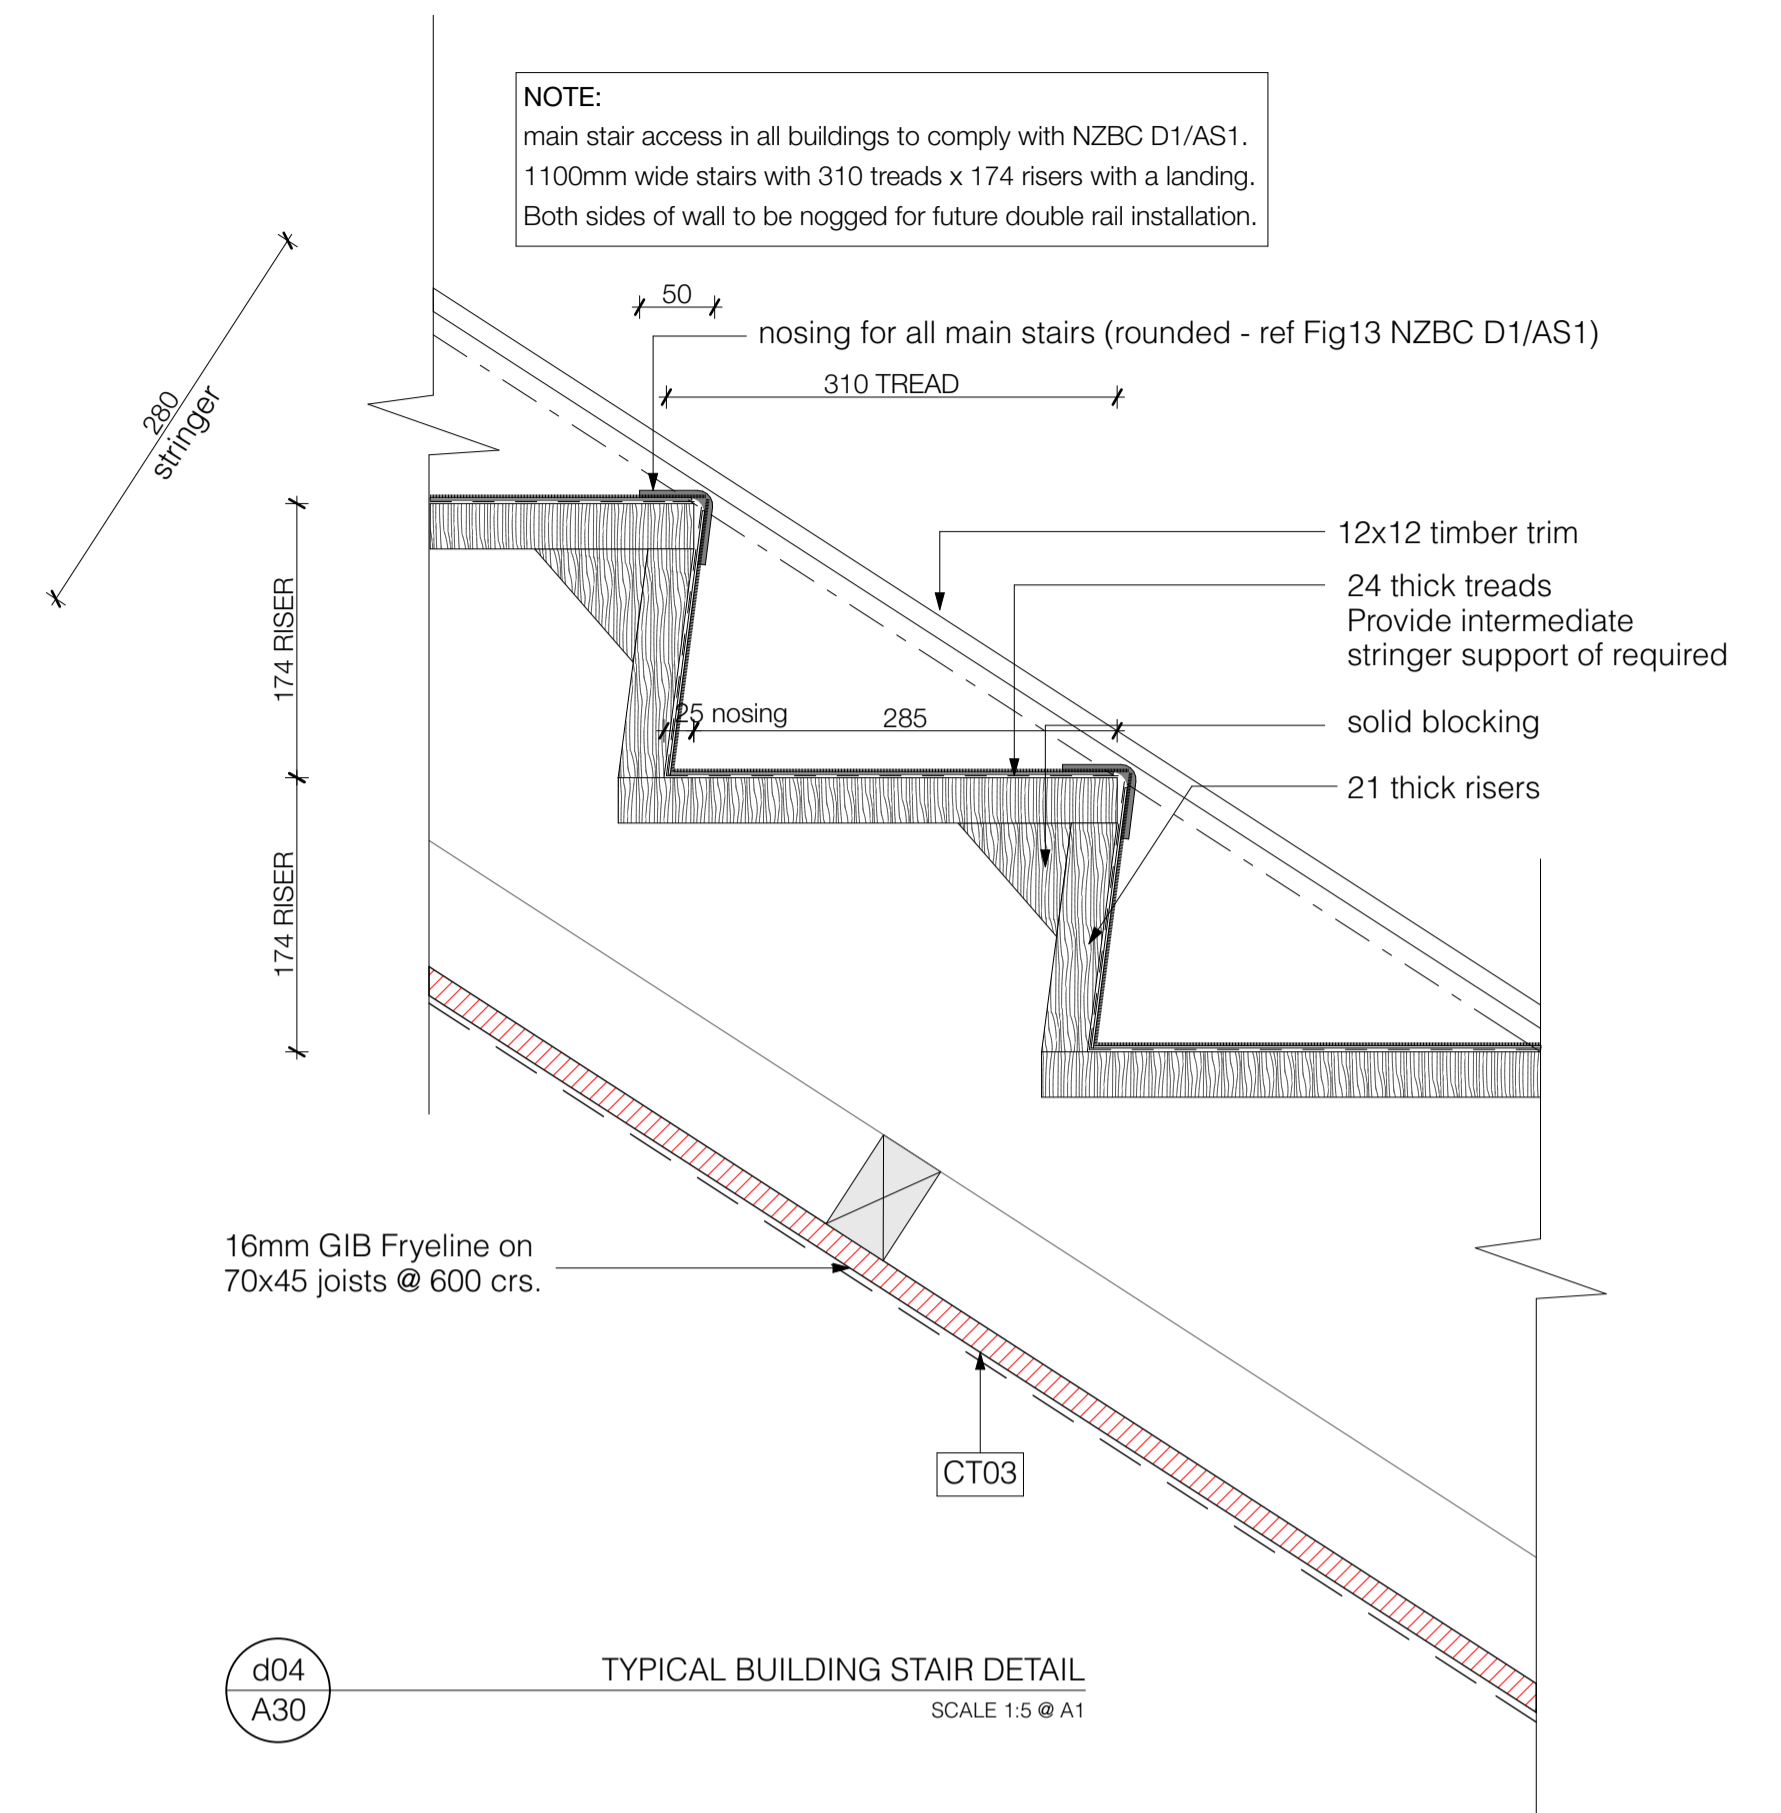

d04
A30
TYPICAL BUILDING STAIR DETAIL
SCALE 1:5 @ A1

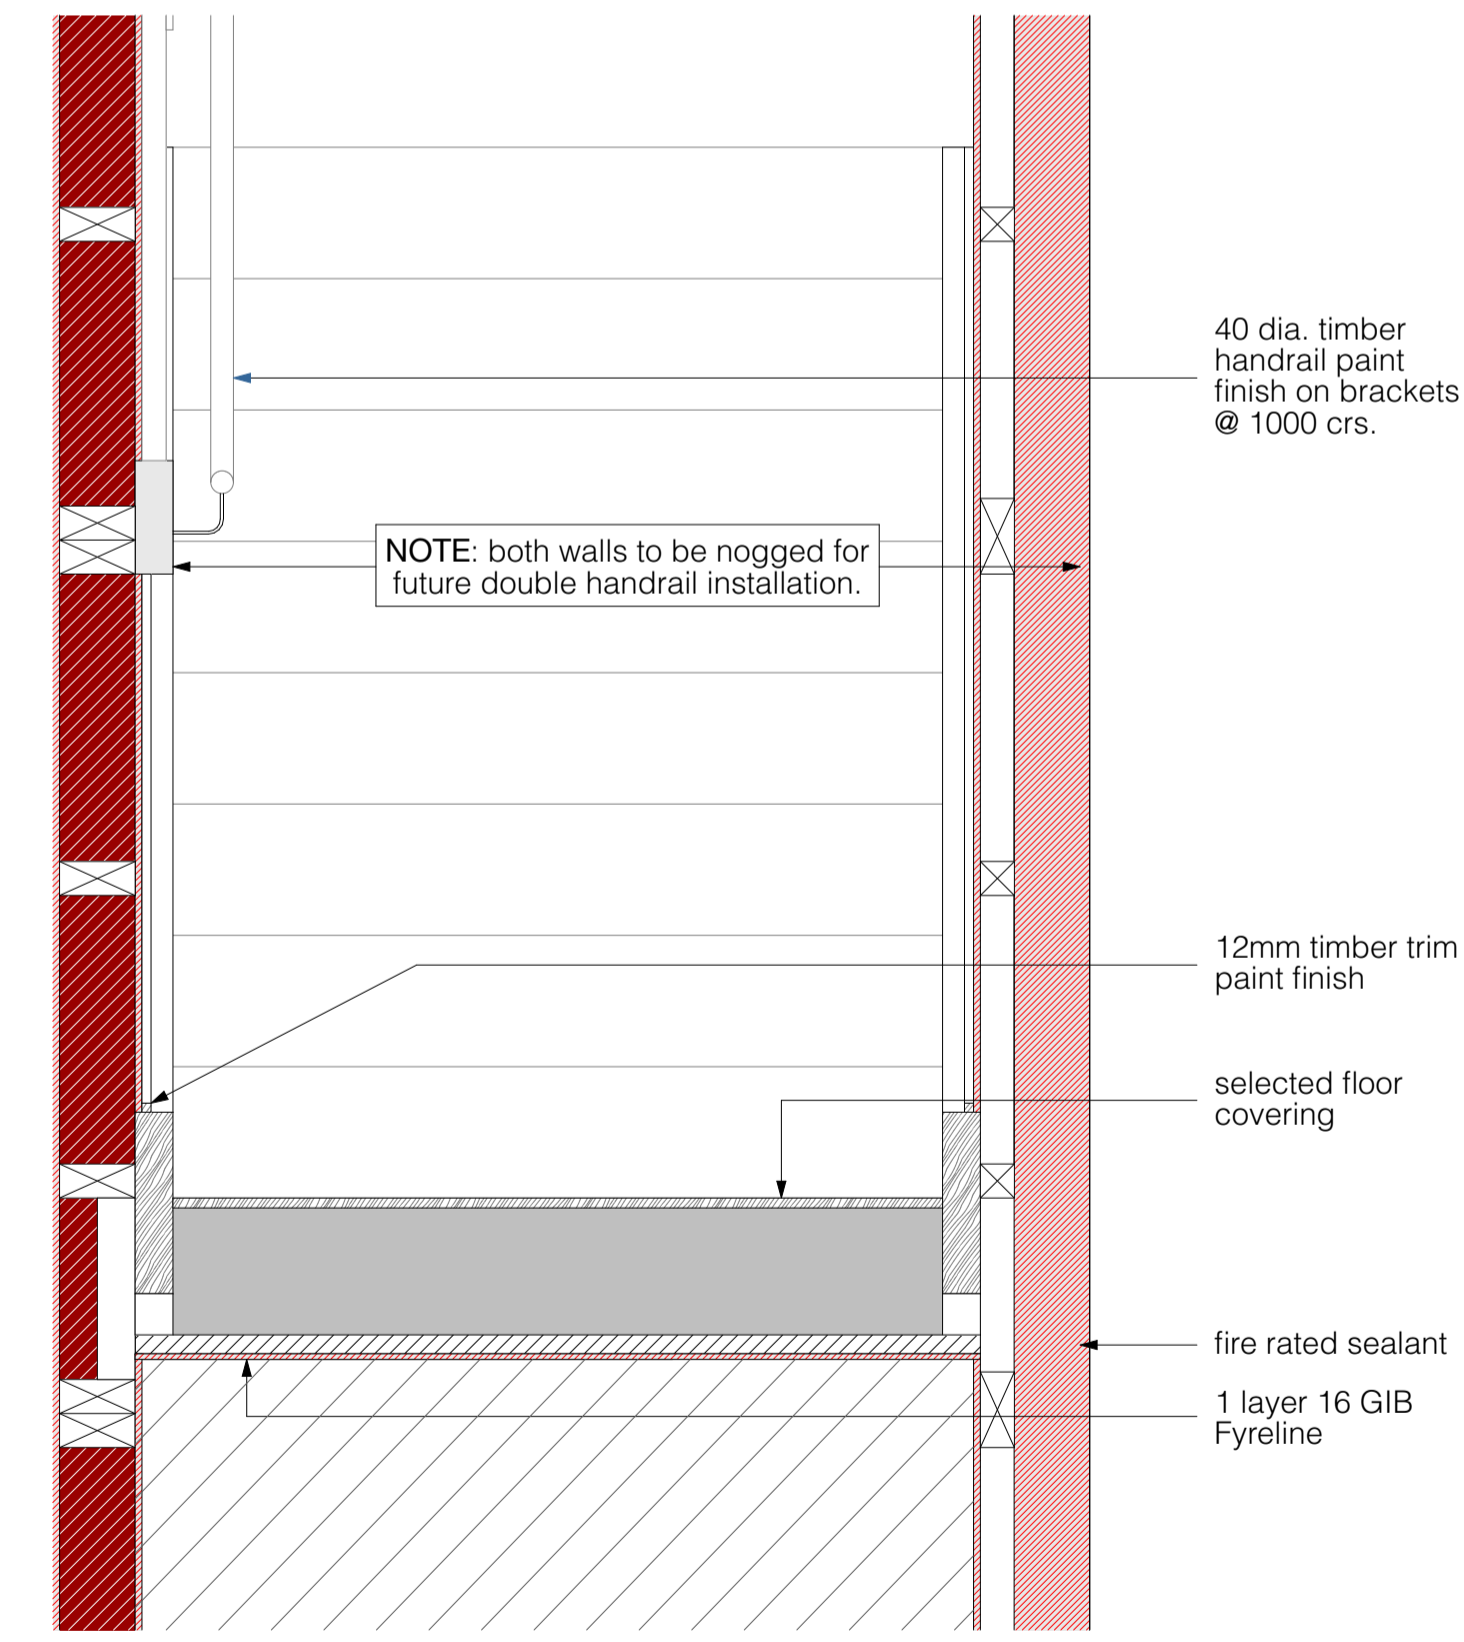

S12
A30
MAIN STAIR SECTION 12
SCALE 1:10 @ A1

FOR CONSTRUCTION ISSUE

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CLIENTS:



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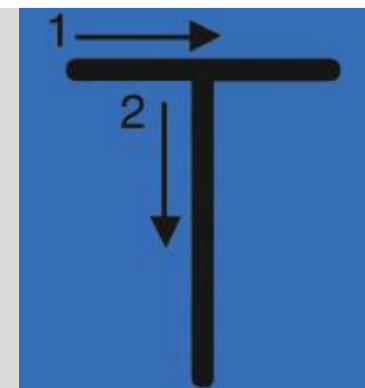
C01

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PROJECT:

Te Rapa Stage 2

CLIENT: Fosters Construction
SITE: Te Rapa Industrial Park, Hamilton

DRAWING TITLE:

TYPICAL STAIRS

PROJECT REF:

T0424 TE RAPA S2

DATE:

25/06/19

SHEET:


A30

SCALE:


1:20, 1:10, 1:5 @ A1

REV:

C01

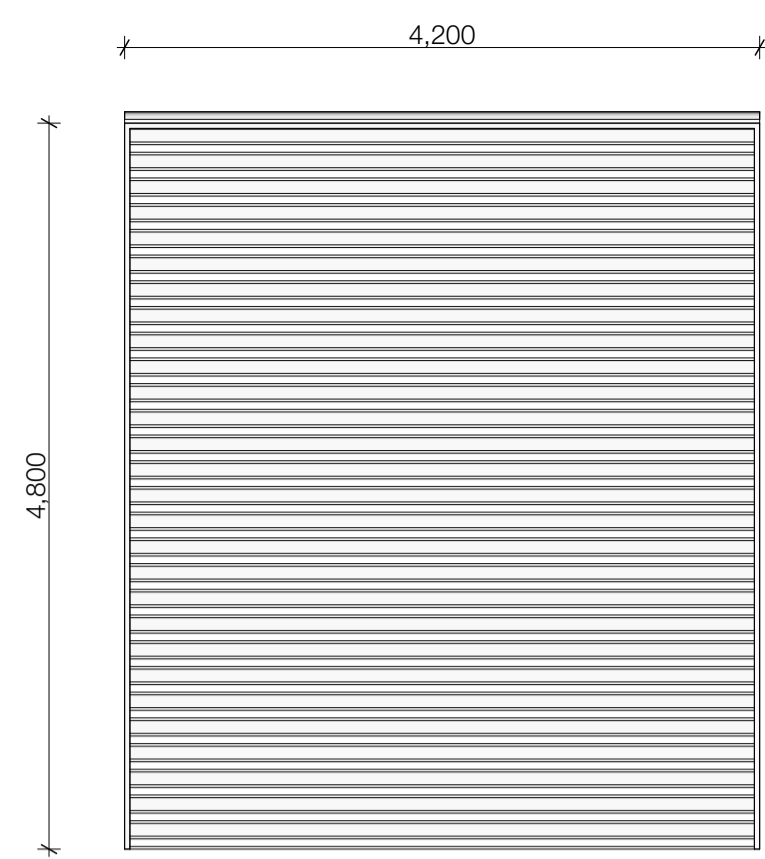


3 as shown; (D27, D36, D45)
3 handed (D10, D16, D19)

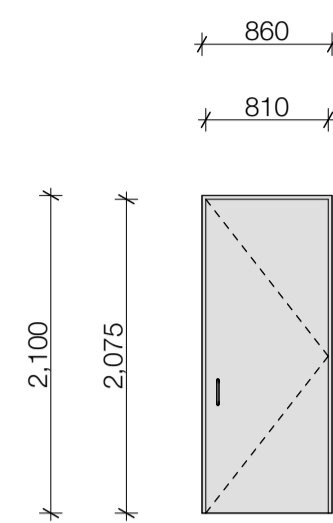


3 as shown;
(D28, D37, D46);
3 handed (D02,
D11, D20)

- exterior grade
- proprietary aluminium frame and face

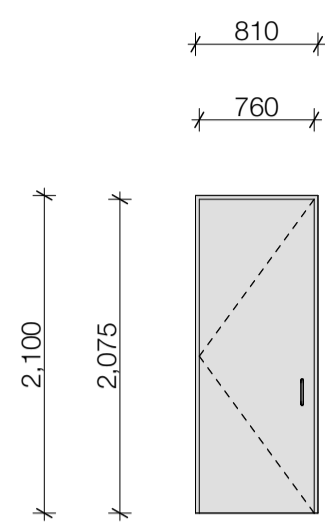


5 as shown;
(D03, D04, D12,
D13, D23); 5
handed (D29,
D30, D38, D39,
D49)

- interior grade
- solid core

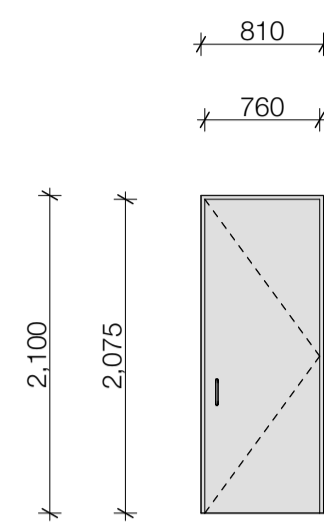


3 as shown;
(D05, D14, D24);
5 handed
(D31x3, D40,
D50)

- interior grade
- solid core

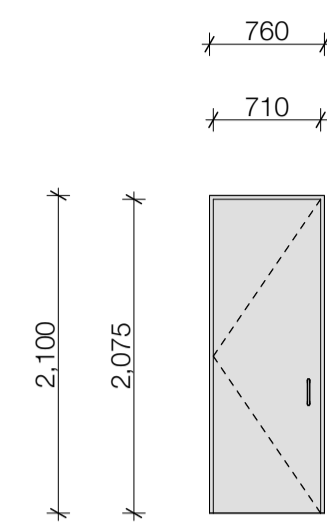


3 as shown;
(D06, D15, D25);
5 handed
(D32x3, D41,
D51)

- interior grade
- solid core

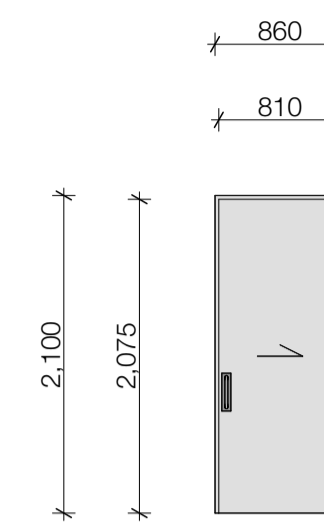


3 as shown;
(D07, D16, D26);
5 handed
(D33x3, D42,
D52)

- interior grade CS cavity sliding door
- solid core

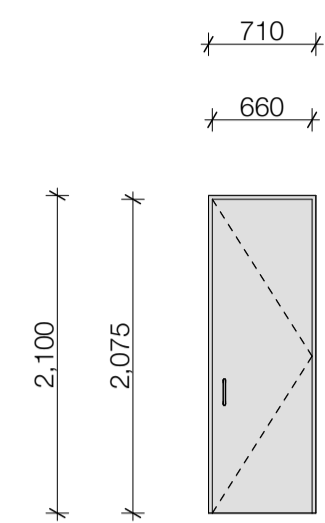


3 as shown;
(D08, D17, D48);
3 handed (D22,
D34, D43)

- interior grade
- solid core

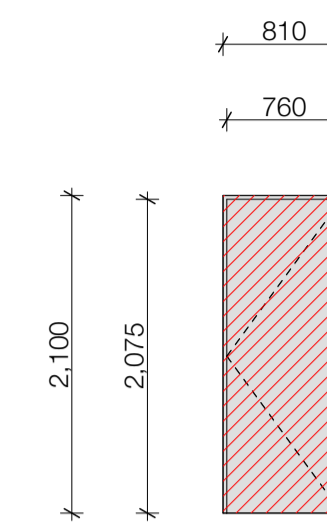

3 as shown;
(D09, D18, D47);
3 handed (D21,
D35, D44)


- interior grade fire door
- /60/30 sm
- solid core
- overhead closer

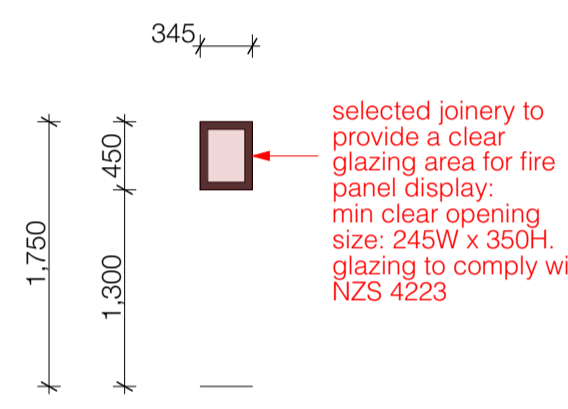

selected joinery to provide a clear glazing area for fire panel display. min clear opening size: 245W x 350H. glazing to comply with NZS 4223


2 as shown;
(FAP 4x2); 4
handed (FAP 1,
FAP 2, FAP 3,
FAP 5)

- external glazed window for Fire Alarm Panel (FAP)

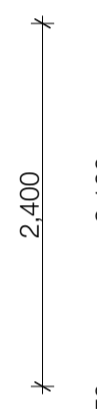


3 as shown;
(Unit 01, Unit
02, Unit 04); 1
item handed
(Unit 05)

- external glazing unit
- 150 concrete up-stand at f.f.l.

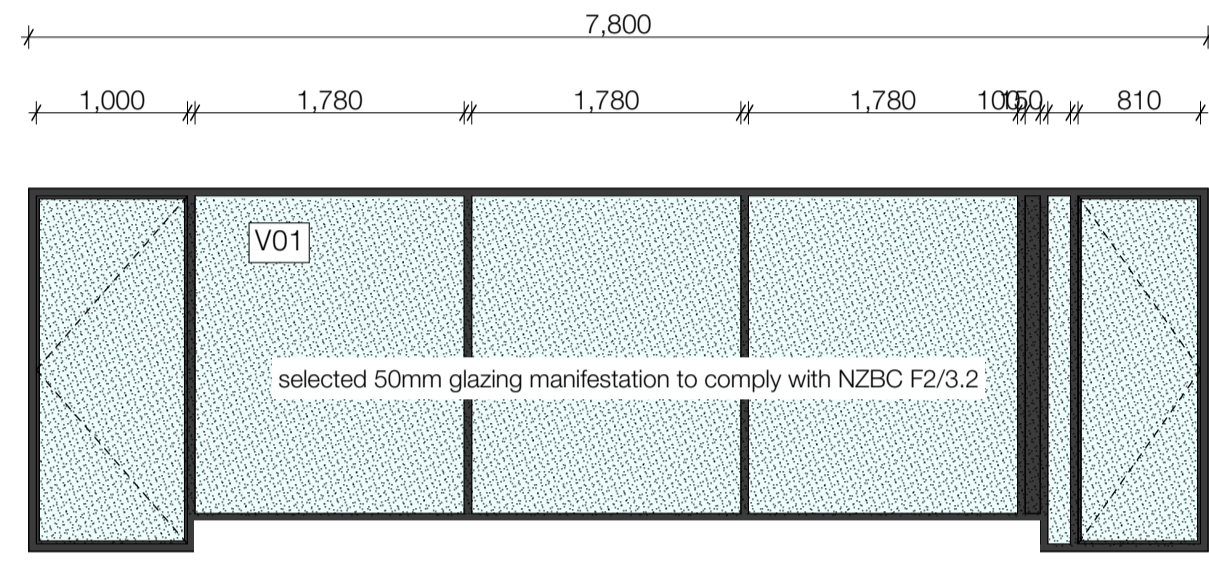


selected 50mm glazing manifestation to comply with NZBC F2/3.2

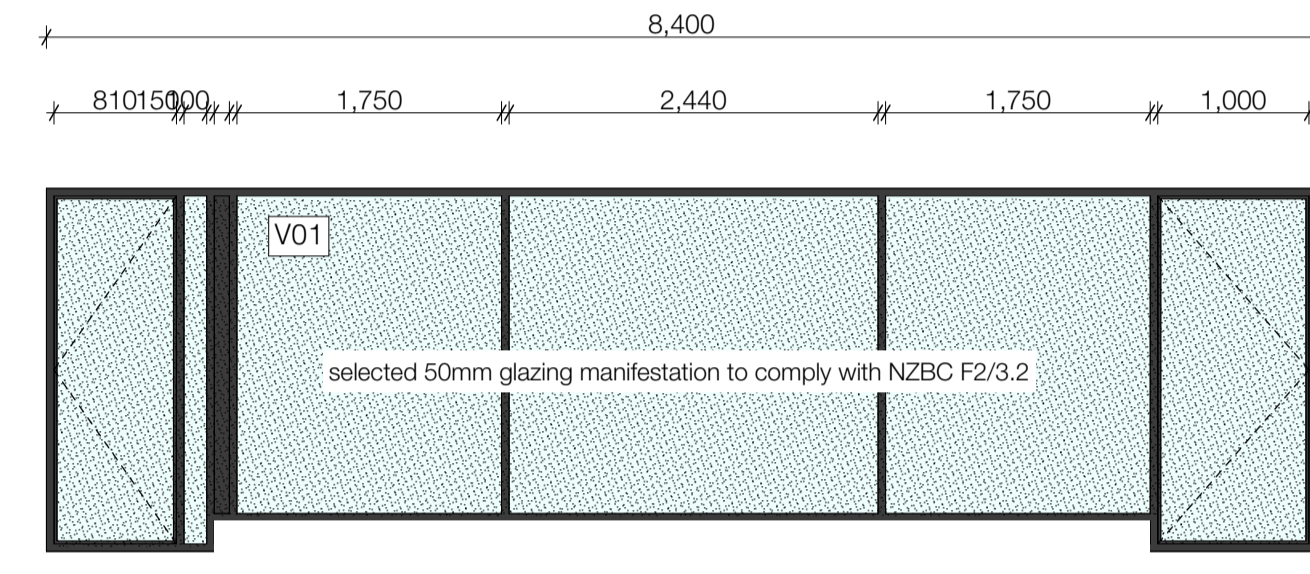

selected 50mm glazing manifestation to comply with NZBC F2/3.2


2 items (Unit 03,
Unit 06)

- external glazing unit
- 150 concrete up-stand at f.f.l.

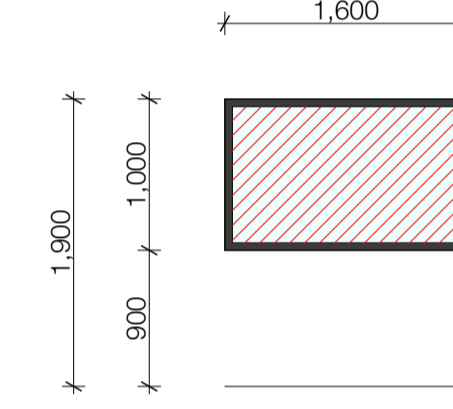


5 as shown;
(W04, W05,
W11, W14,
W16); 5 handed
(W01, W02,
W07, W09,
W18)

- internal window
- glazed with FR -/60/60 insulated glass

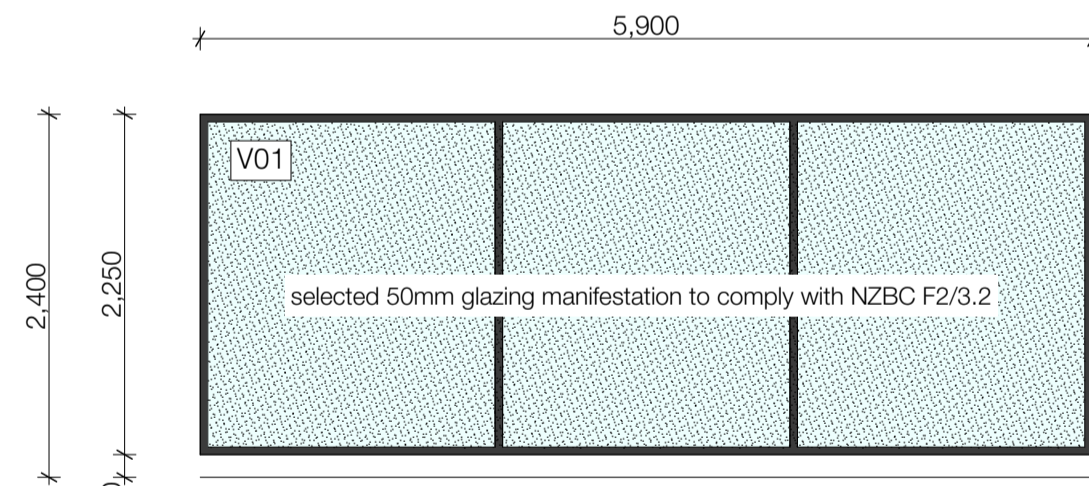


2 items (W03,
W06)

- external glazing unit
- 150 concrete up-stand at f.f.l.

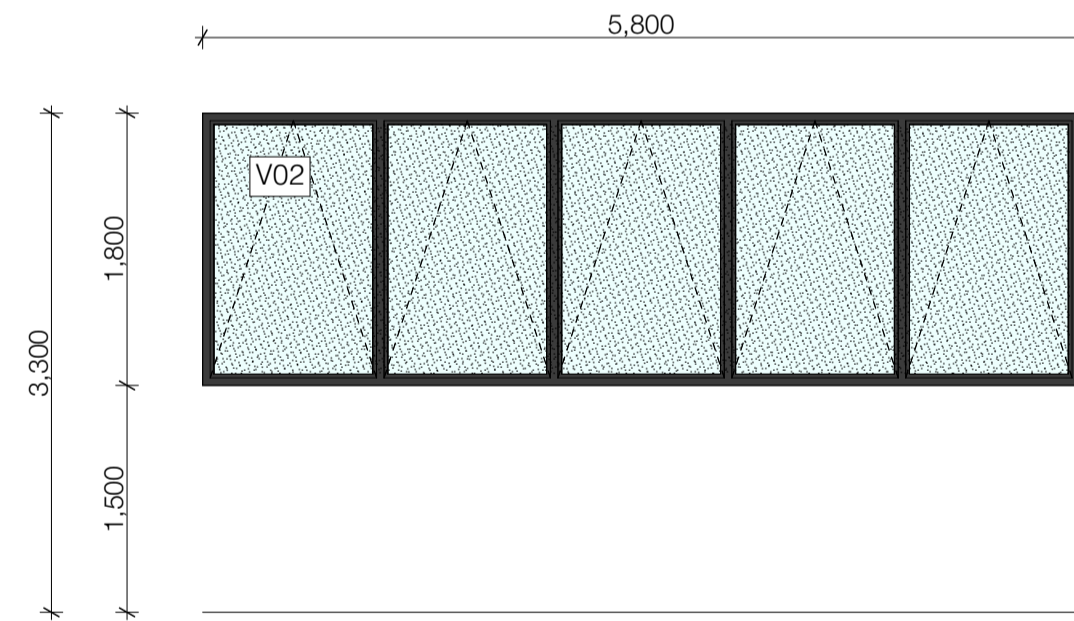

3 as shown;
(W12, W15,
W17); 3 handed
(W08, W10,
W19)

- external glazing unit

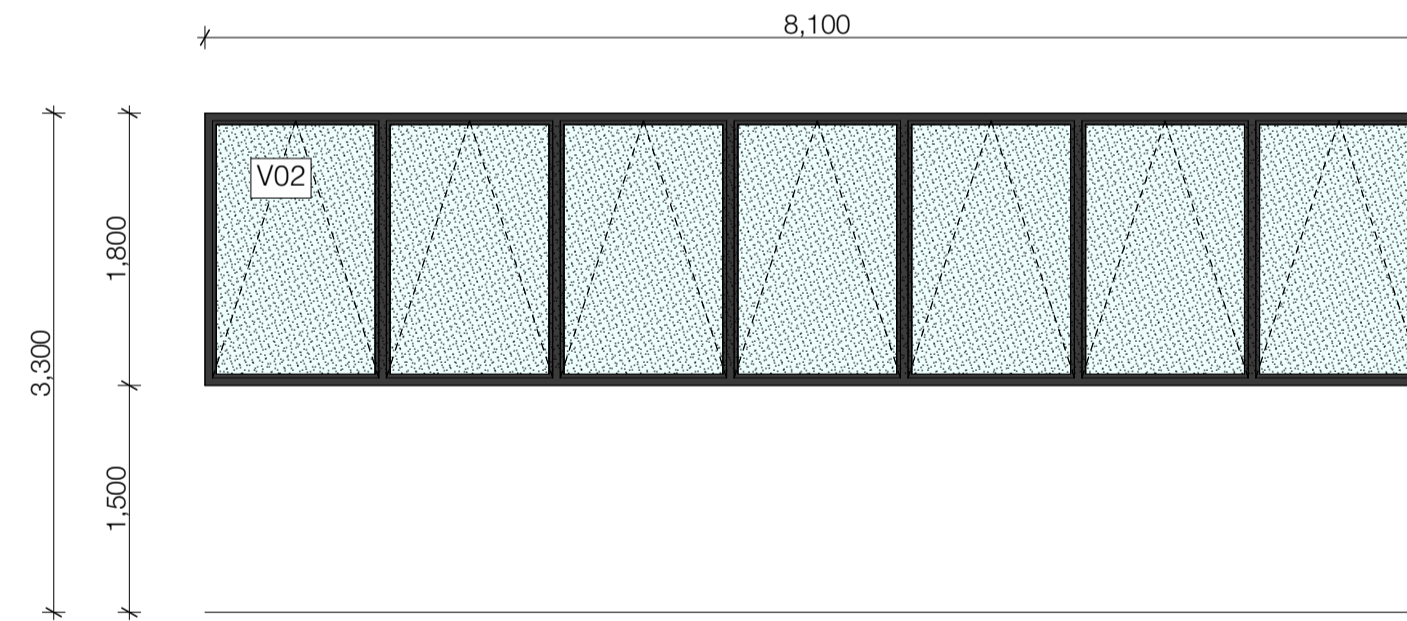

2 items (W13,
W18)

- external glazing unit

NOTE: ALL INTERNAL DOORS / WINDOWS FINISHED WITH 60mm SINGLE BEVEL FJ TIMBER ARCHITRAVE WITH NOMINATED PAINT FINISH.

GLAZING KEY:

- V01 external window VANTAGE 135 Flushglaze suite in seismic frames with powder coat finish.
- V02 external window VANTAGE 40 Metro suite with powder coat finish.
- selected Low E Plus or Max glazing for all joinery to comply with NZS 4223.

WINDOWS:

Windows are viewed from the outside rooms they will occur in

Dimensions are rough opening sizes unless noted otherwise, and must be confirmed on site before fabrication

Glass is to be weighted for size and application, in accordance with NZS 4223

Aluminium frames are to be powder coat finished.

All opening windows are to be fitted with stainless steel restrictor stays.

All internal windows to be glazed with FR 60/60/60 insulated glass to meet fire protection requirements.

The contractor is to use these drawings as the basis for the works and allow for window swings, handling etc. and to provide and install all items of hardware not specified, shown or listed, but required for the completion and proper finish of the works.

The window joinery sections specified are for guidance only. The window joinery manufacturer is to use frames sized to suit locations.

For ULS and SLS figures refer to the structural engineer. These will be basic wind loads and will not take account of local factors. Window manufacture designers will need to apply appropriated C factors to determine actual wind loads at difference locations on the building, as per AS/ANS 1170.2

All openings to be finished internally with 60mm single bevel finger-jointed timber architrave with nominated paint finish.

Refer specified hardware schedule for all door and window hardware requirements.

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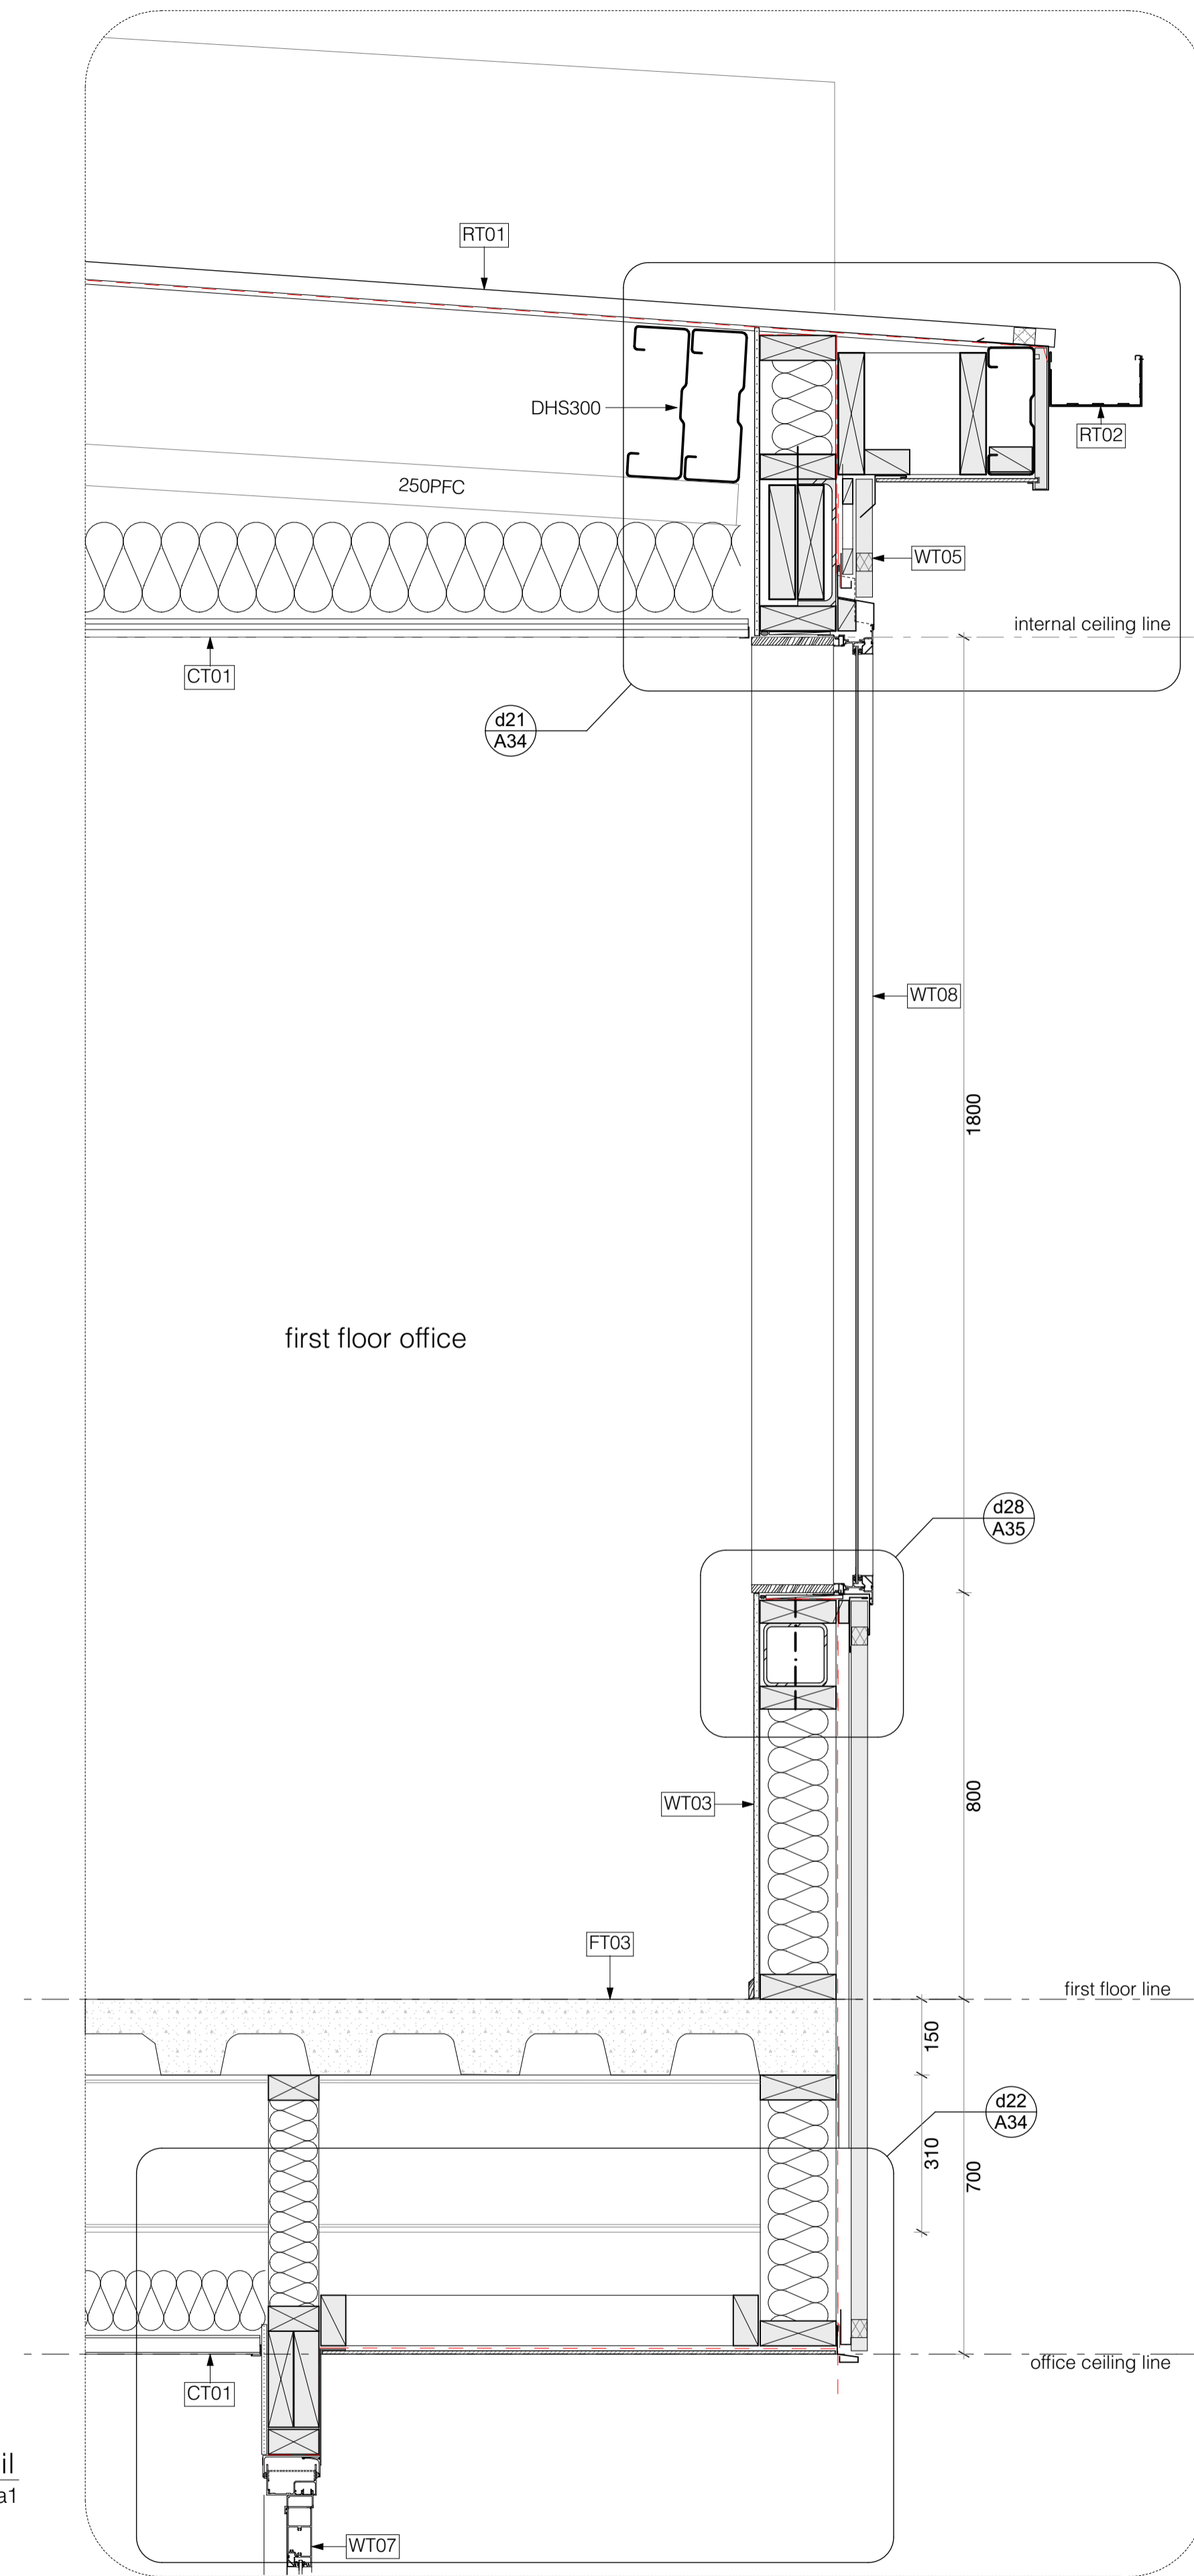
PROJECT:
Te Rapa Stage 2

CLIENT: Fosters Construction
SITE: Te Rapa Industrial Park, Hamilton


FOR CONSTRUCTION ISSUE

DRAWING TITLE:
DOOR + WINDOW SCHEDULE

PROJECT REF: T0424 TE RAPA S2	
DATE: 25/06/19	SCALE: 1:50 @ A1
SHEET: A31	REV: C01



d01 A17 facade detail scale 1:5 @ a1

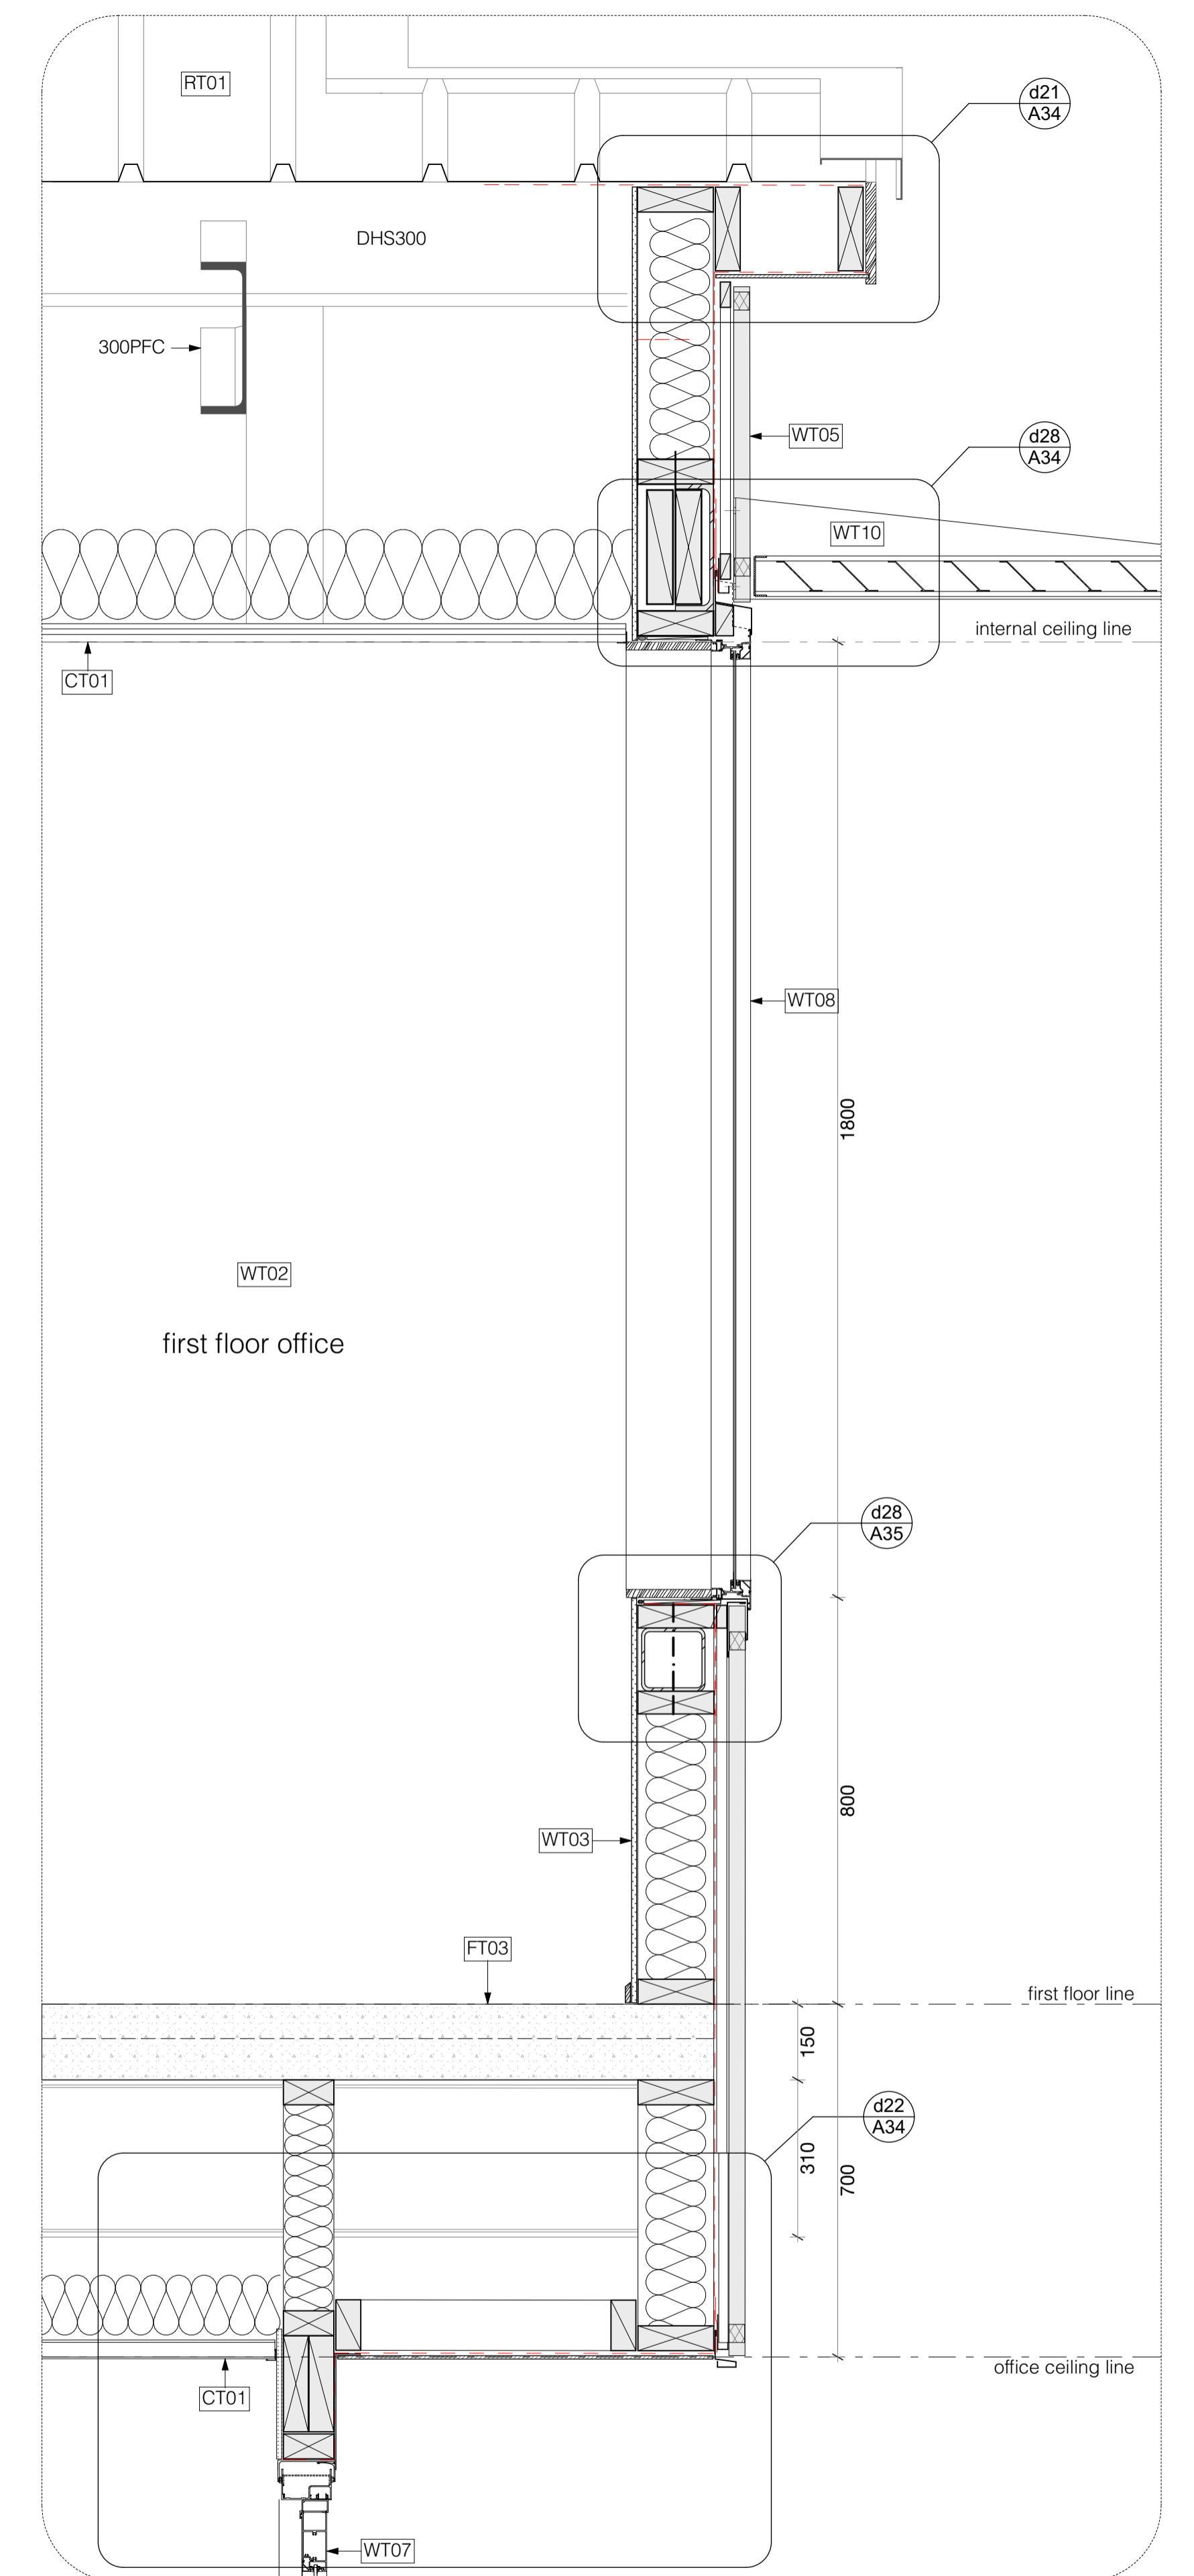

d02 A20 facade detail scale 1:5 @ a1

FOR CONSTRUCTION ISSUE

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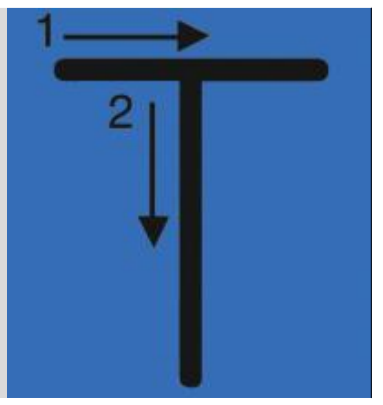
TE RAPA GATEWAY

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ISSUE:	DATE:
C01	25/06/19

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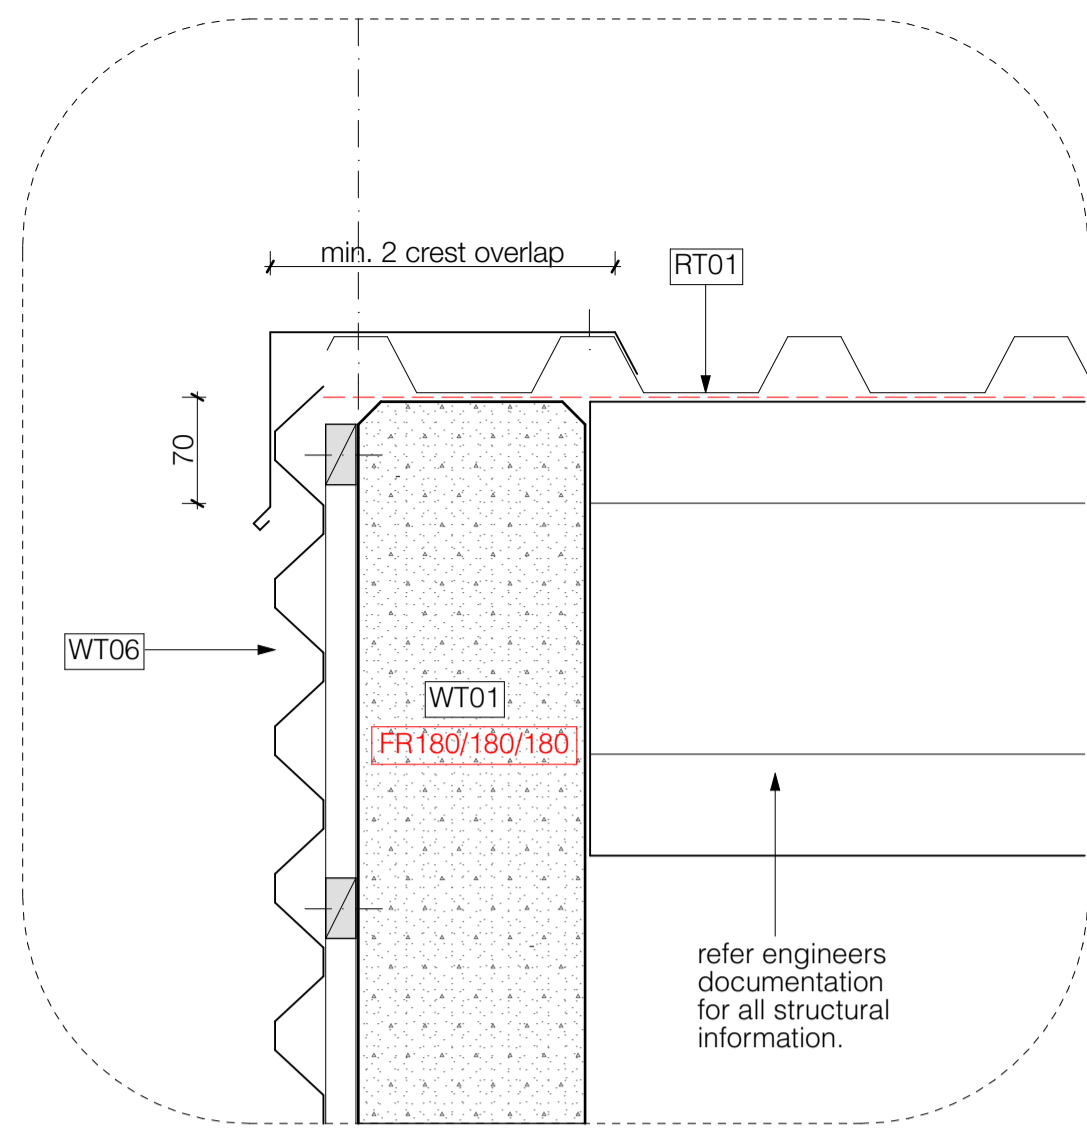


PROJECT:
Te Rapa Stage 2


CLIENT: Fosters Construction
SITE: Te Rapa Industrial Park, Hamilton

DRAWING TITLE:
DETAILS - 1:10


PROJECT REF: T0424 TE RAPA S2	
DATE: 25/06/19	SCALE: 1:10 @ A1
SHEET: A32	REV: C01




d05 roof barge detail
scale 1:5 @ a1

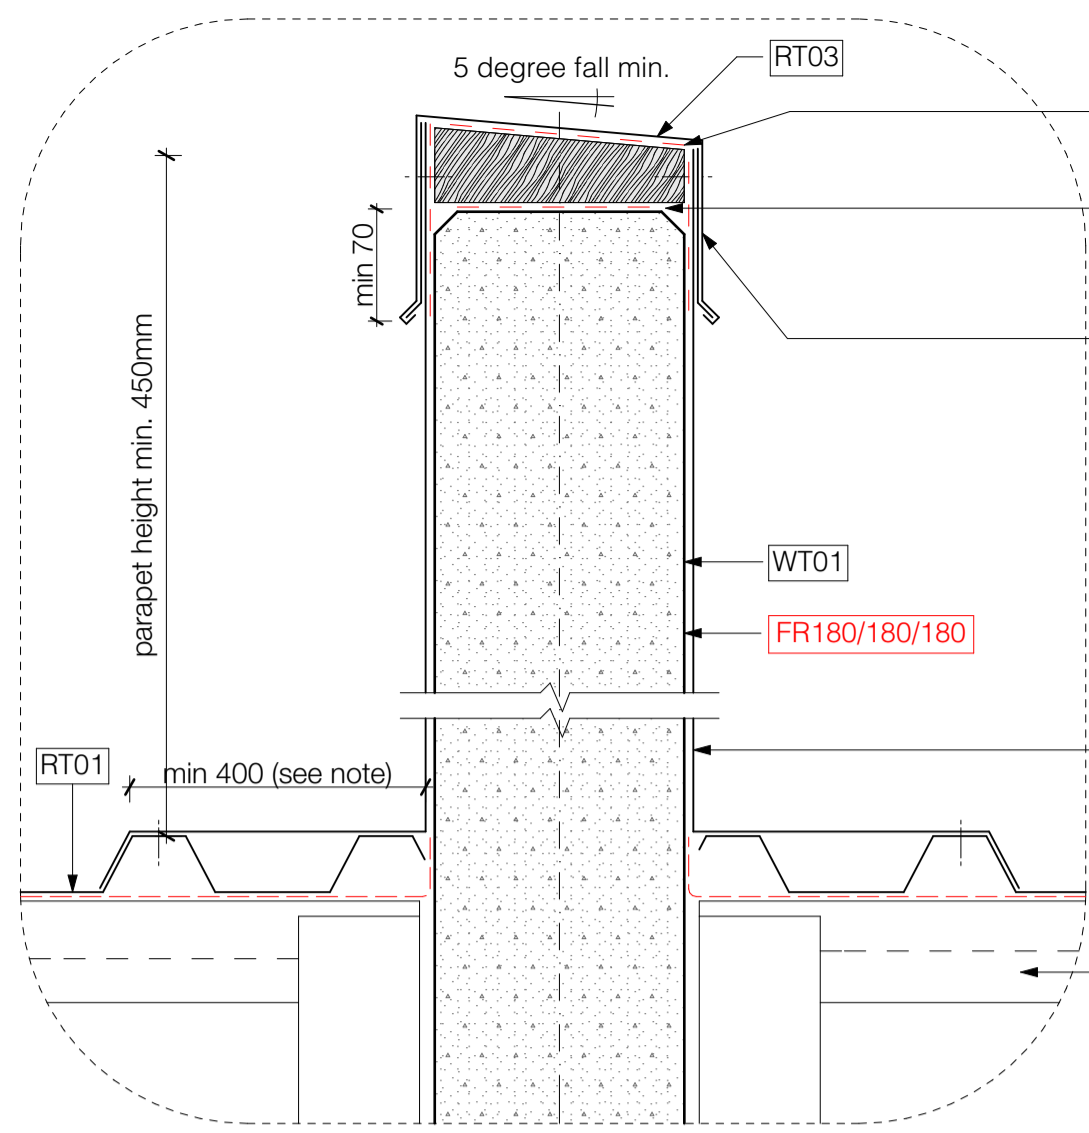


d09 inter wall parapet detail
scale 1:5 @ a1

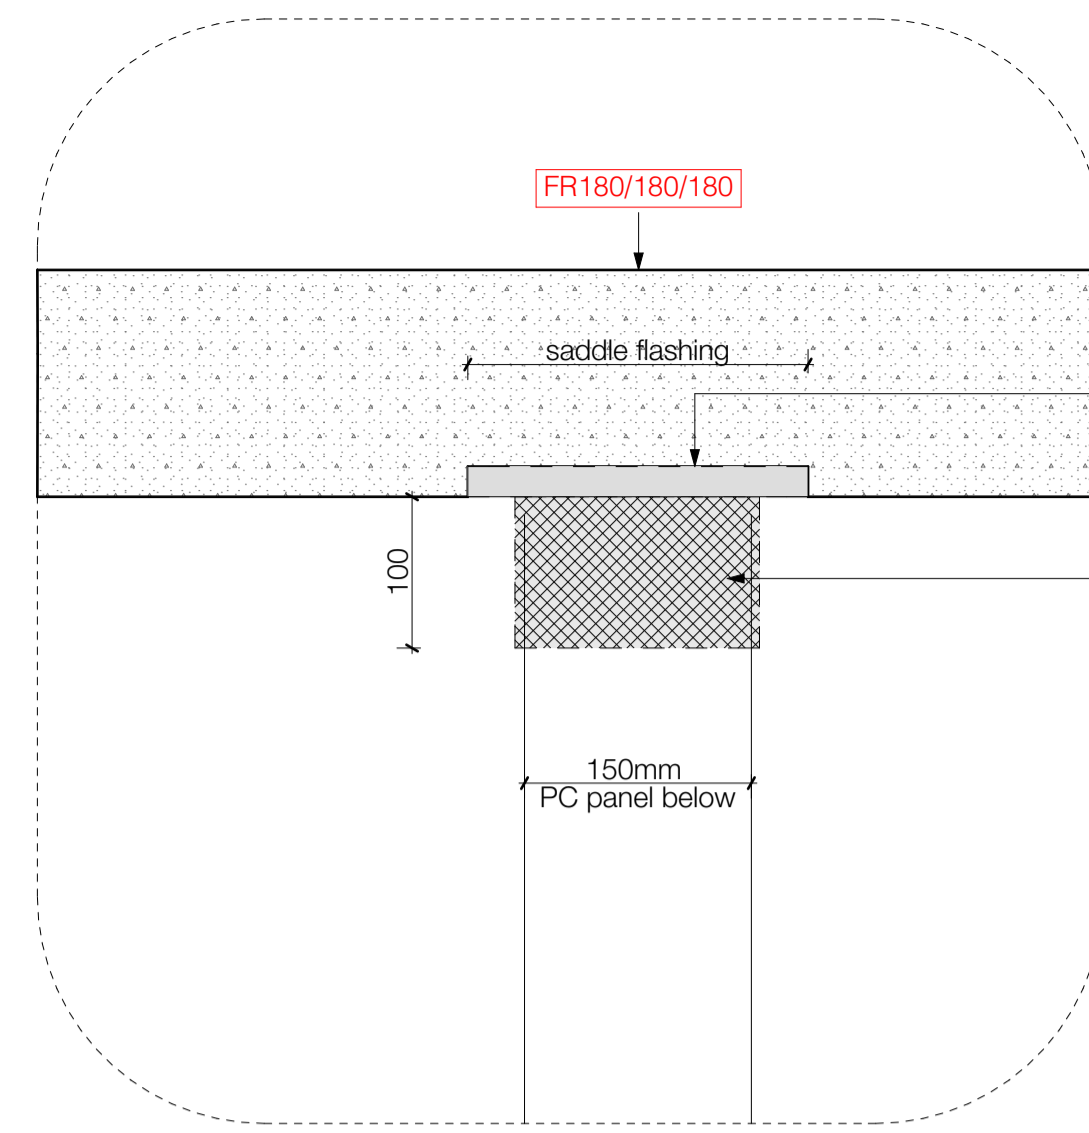


d10 pc panel parapet capping detail
scale 1:5 @ a1

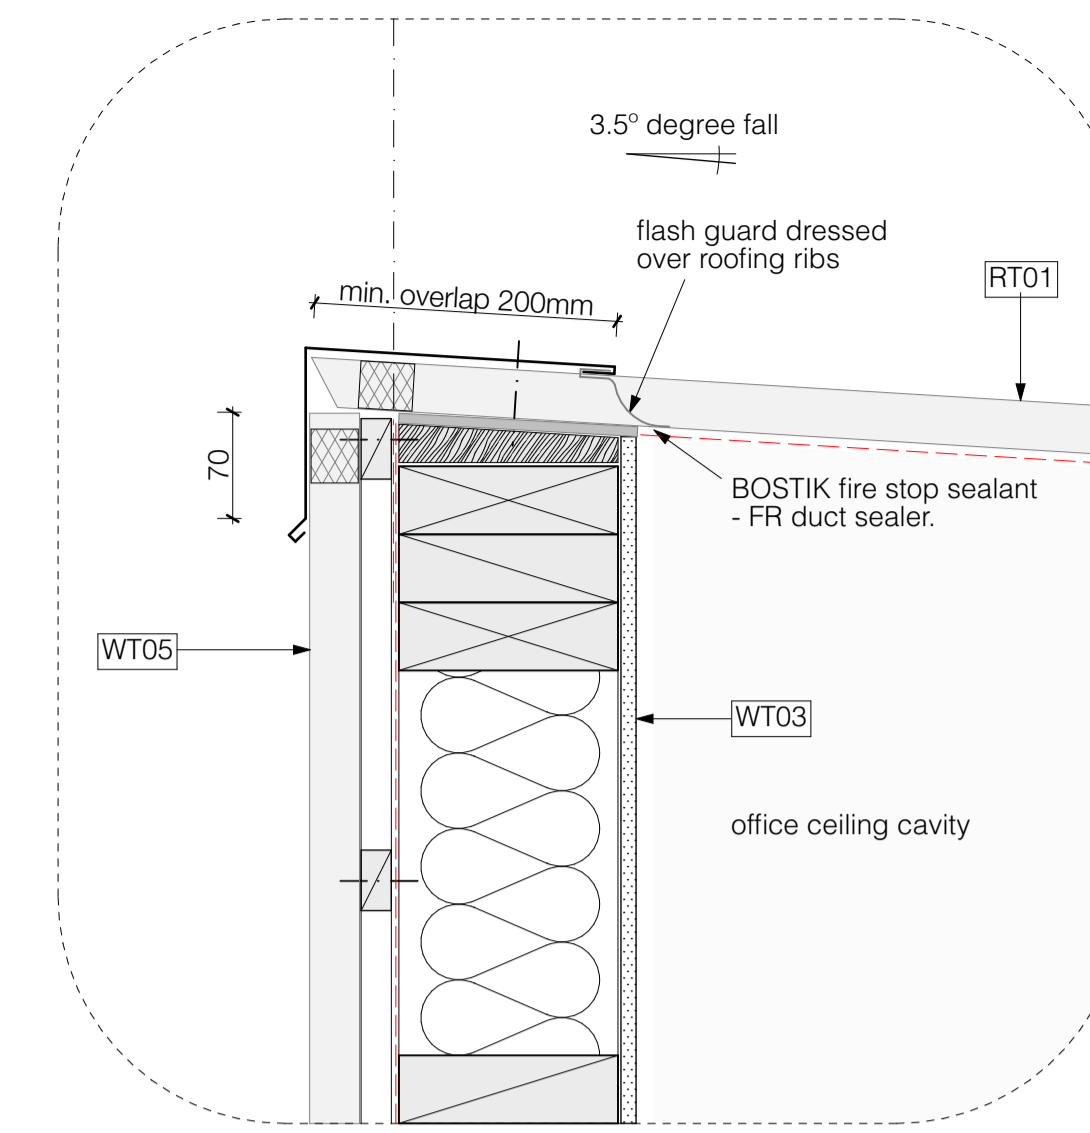


d13 cladding / barge detail
scale 1:5 @ a1

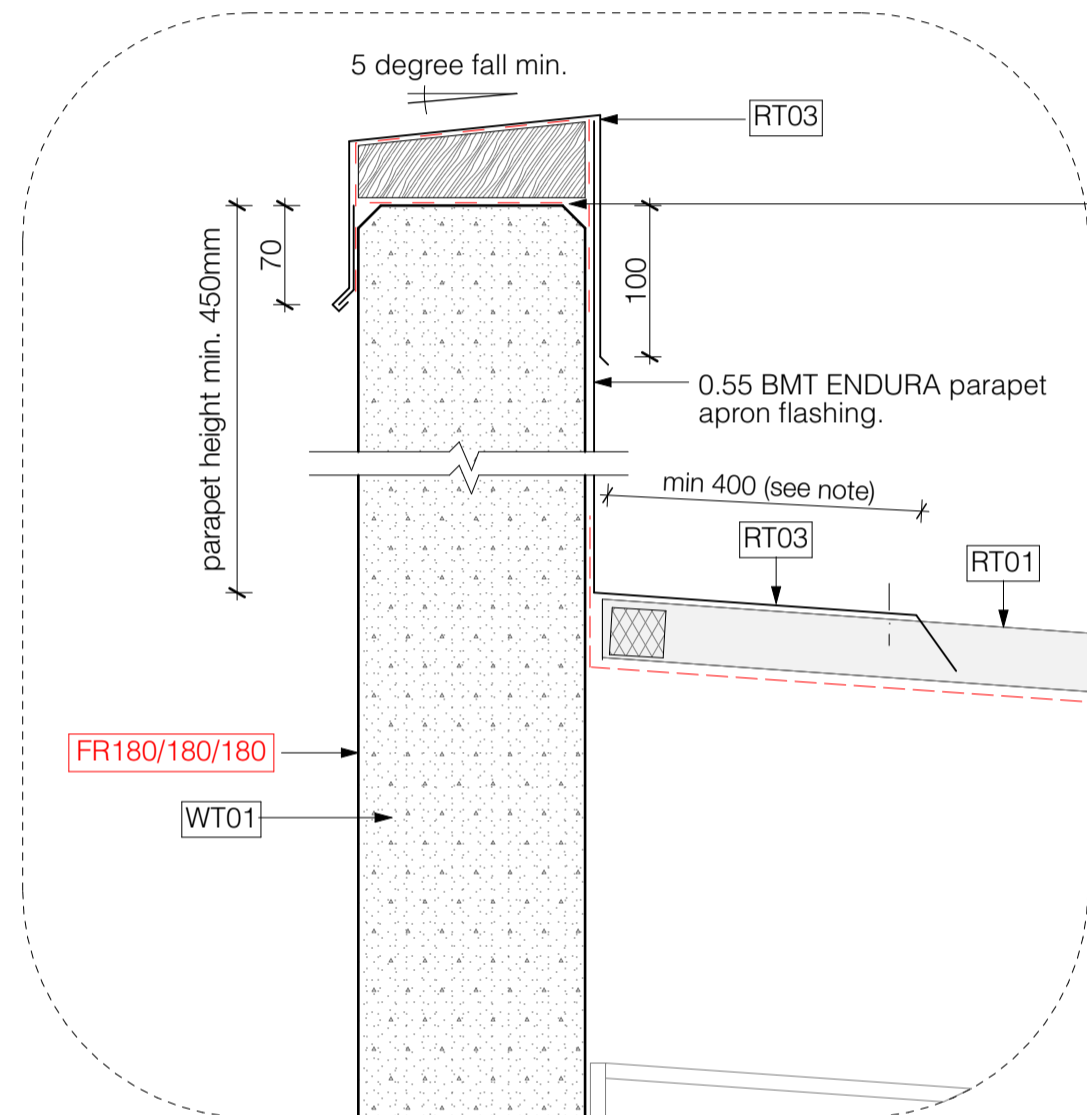


d06 parapet detail
scale 1:5 @ a1

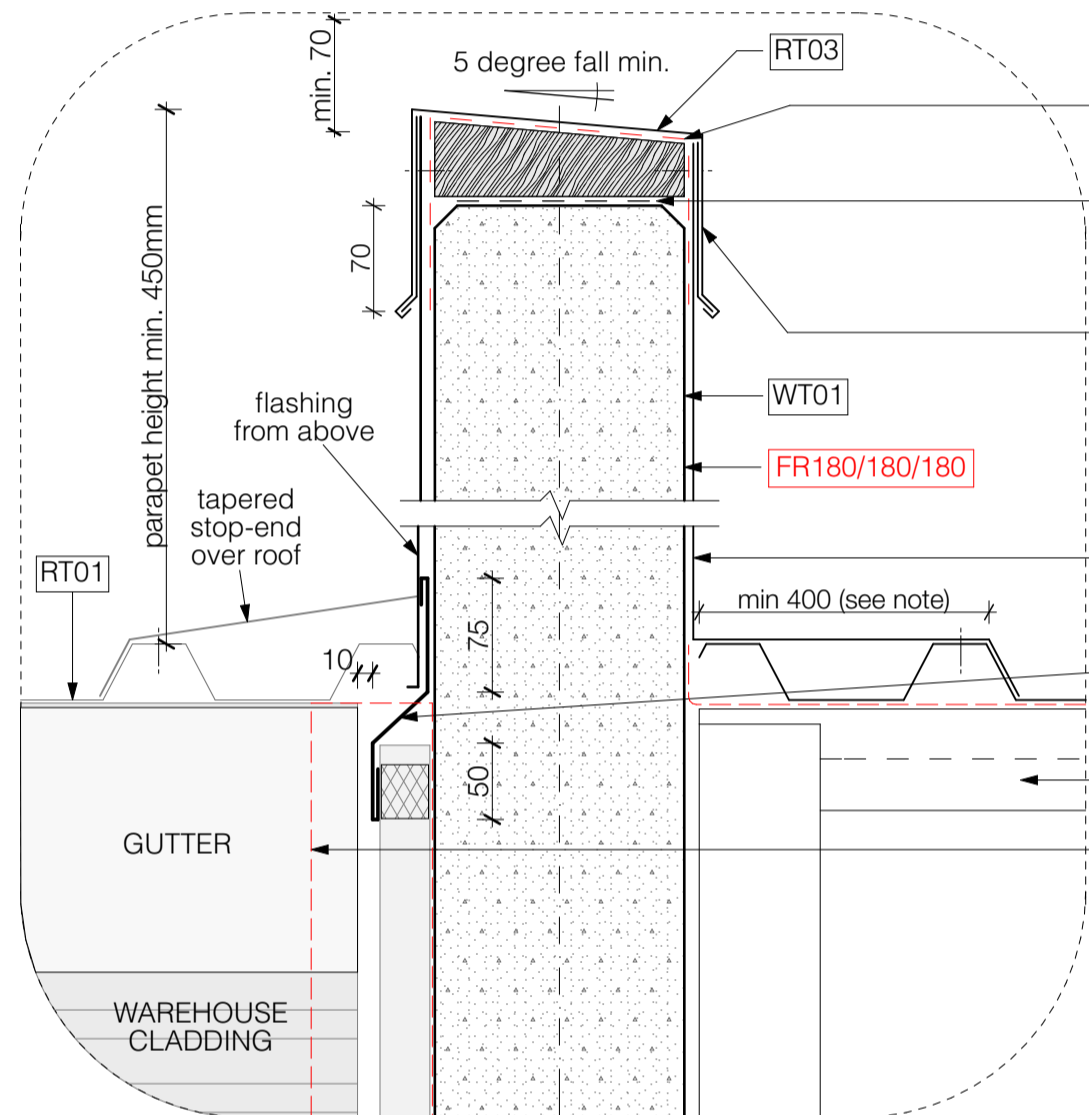


d09a office pop parapet detail
scale 1:5 @ a3

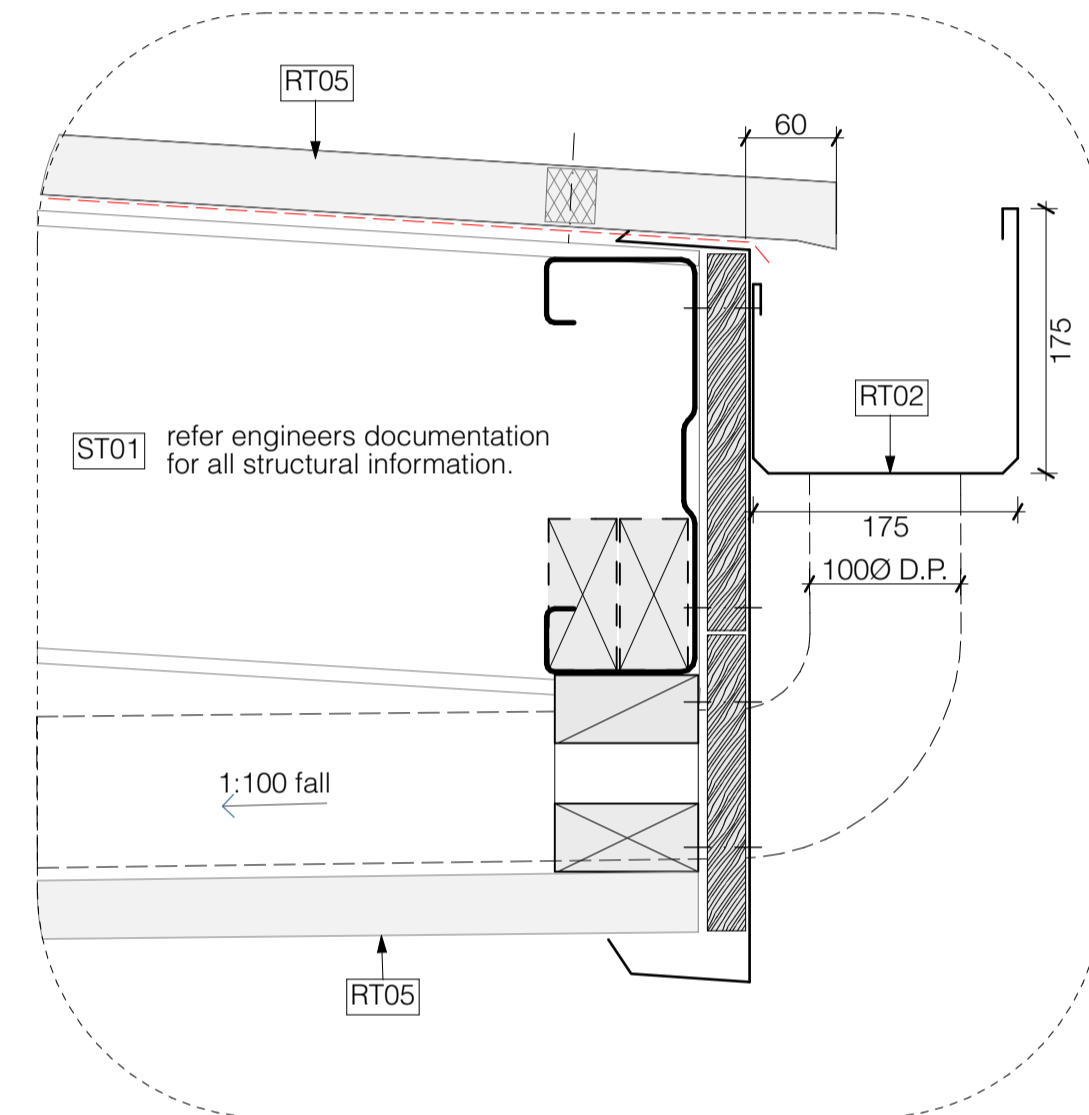


d11 canopy barge detail
scale 1:5 @ a1

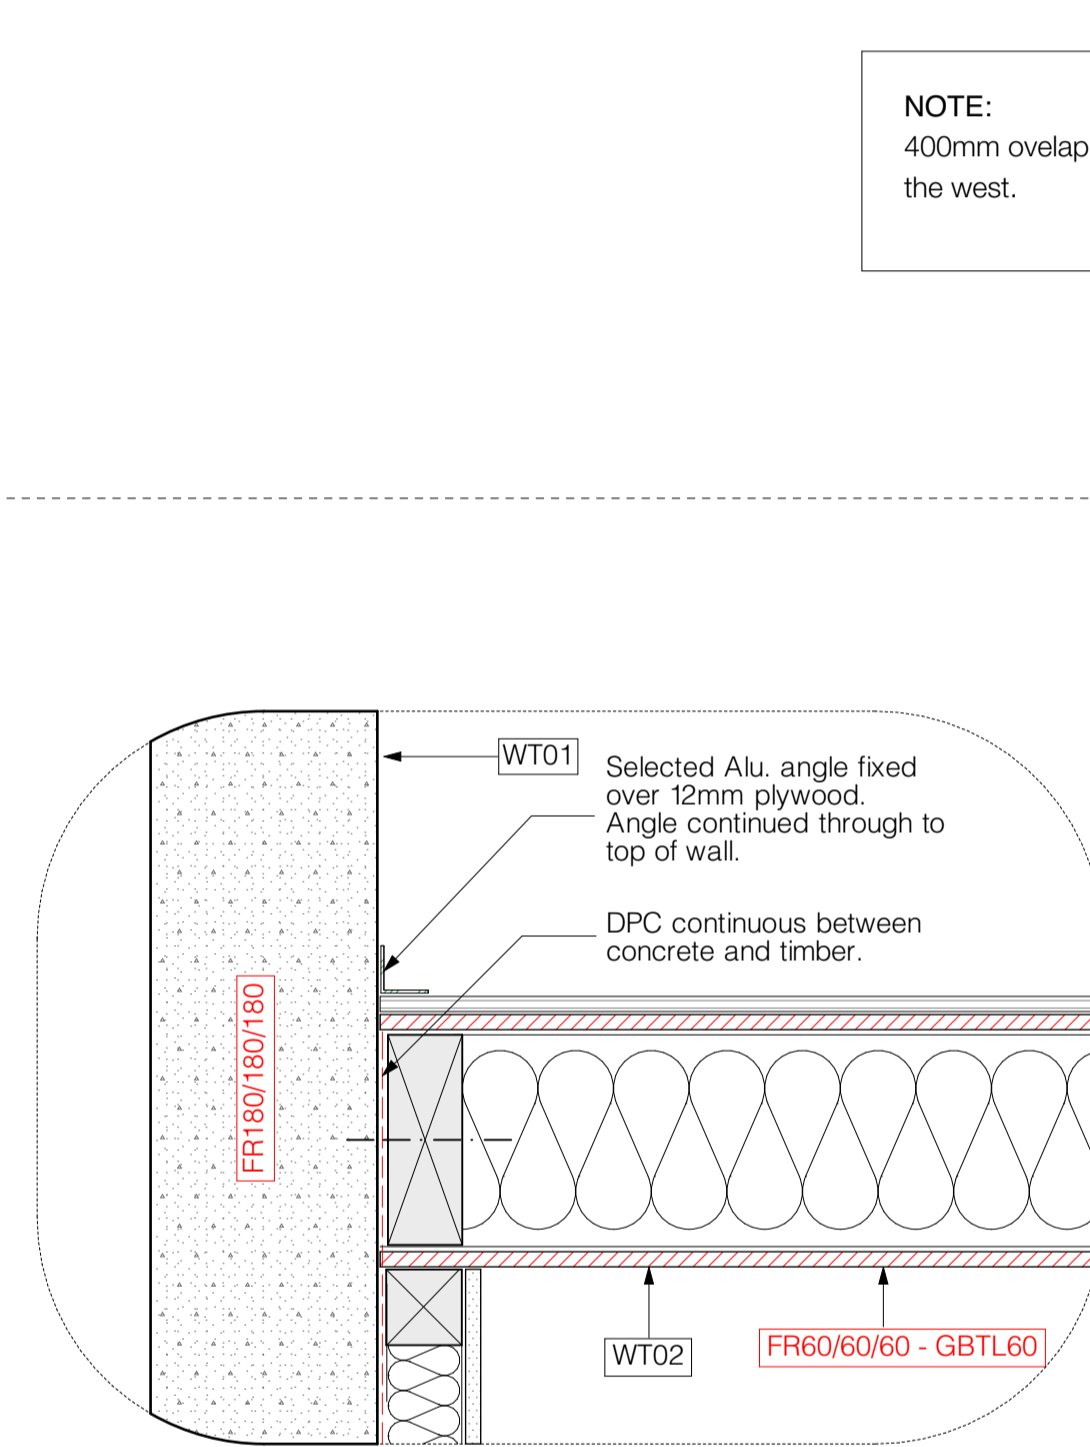


d13b plan view - internal wall junction detail
scale 1:5 @ a1

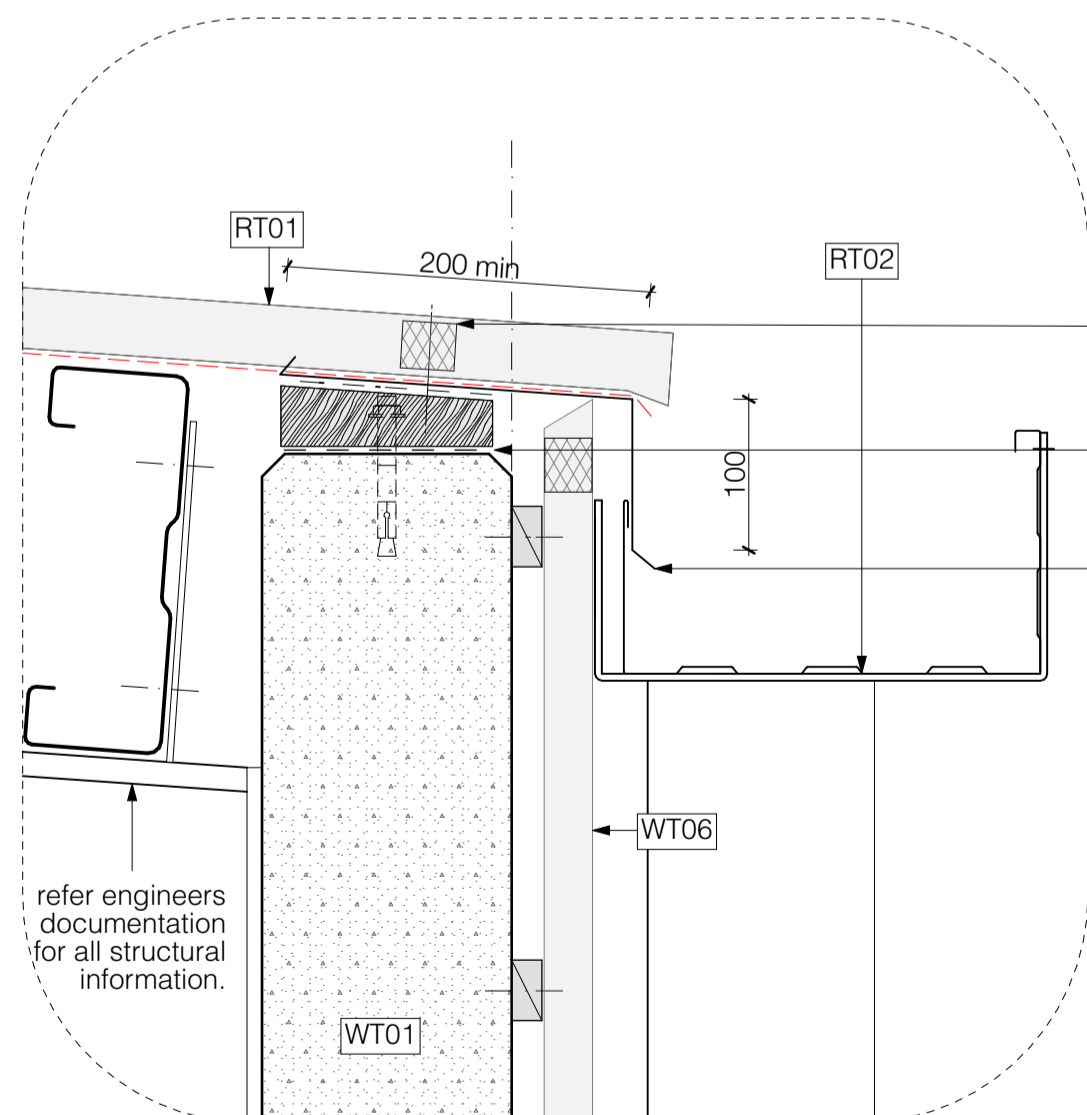

d08 eaves gutter detail
scale 1:5 @ a1

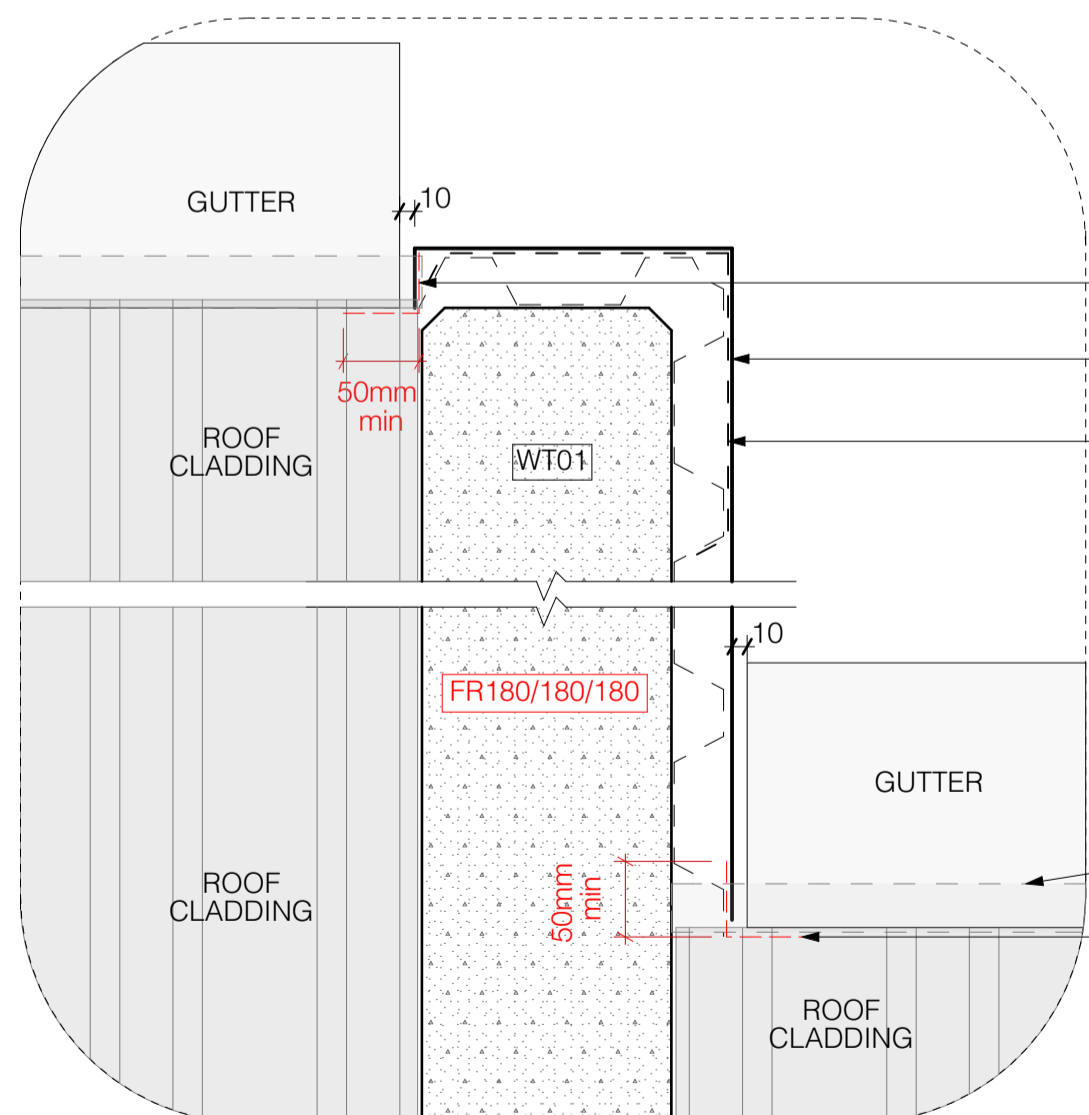

d09b office pop cladding detail
scale 1:5 @ a3

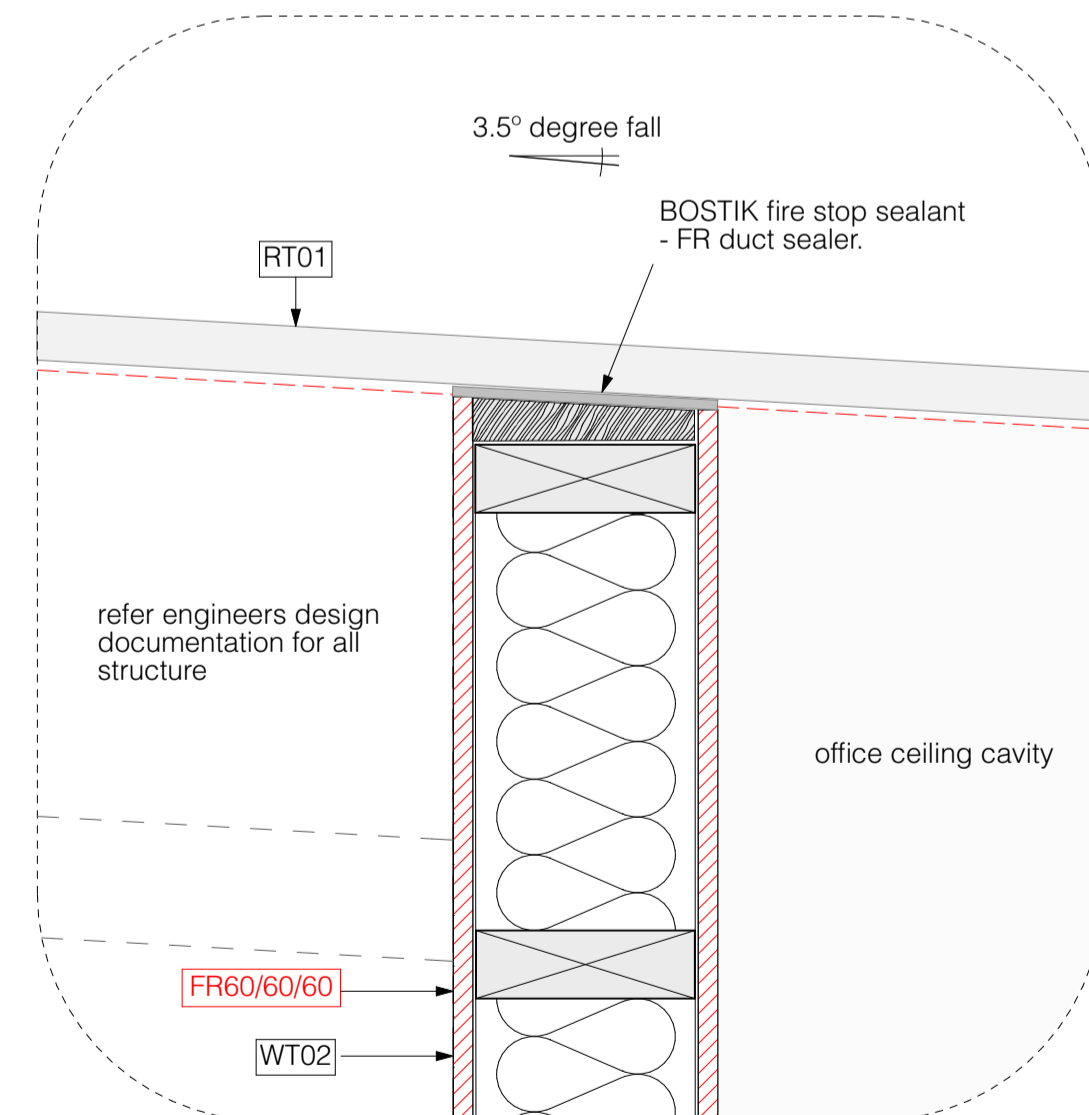

d12 roof junction detail
scale 1:5 @ a1

NOTE:
400mm overlap on all apron flashings exposed to the west.

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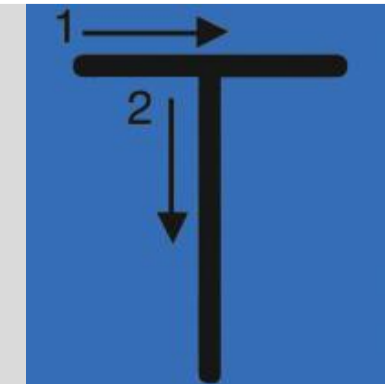
C01

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PROJECT:

Te Rapa Stage 2

CLIENT: Fosters Construction
SITE: Te Rapa Industrial Park, Hamilton

FOR CONSTRUCTION ISSUE

DRAWING TITLE:

DETAILS - ROOF

PROJECT REF:

T0424 TE RAPA S2

DATE:

25/06/19

SHEET:


A33


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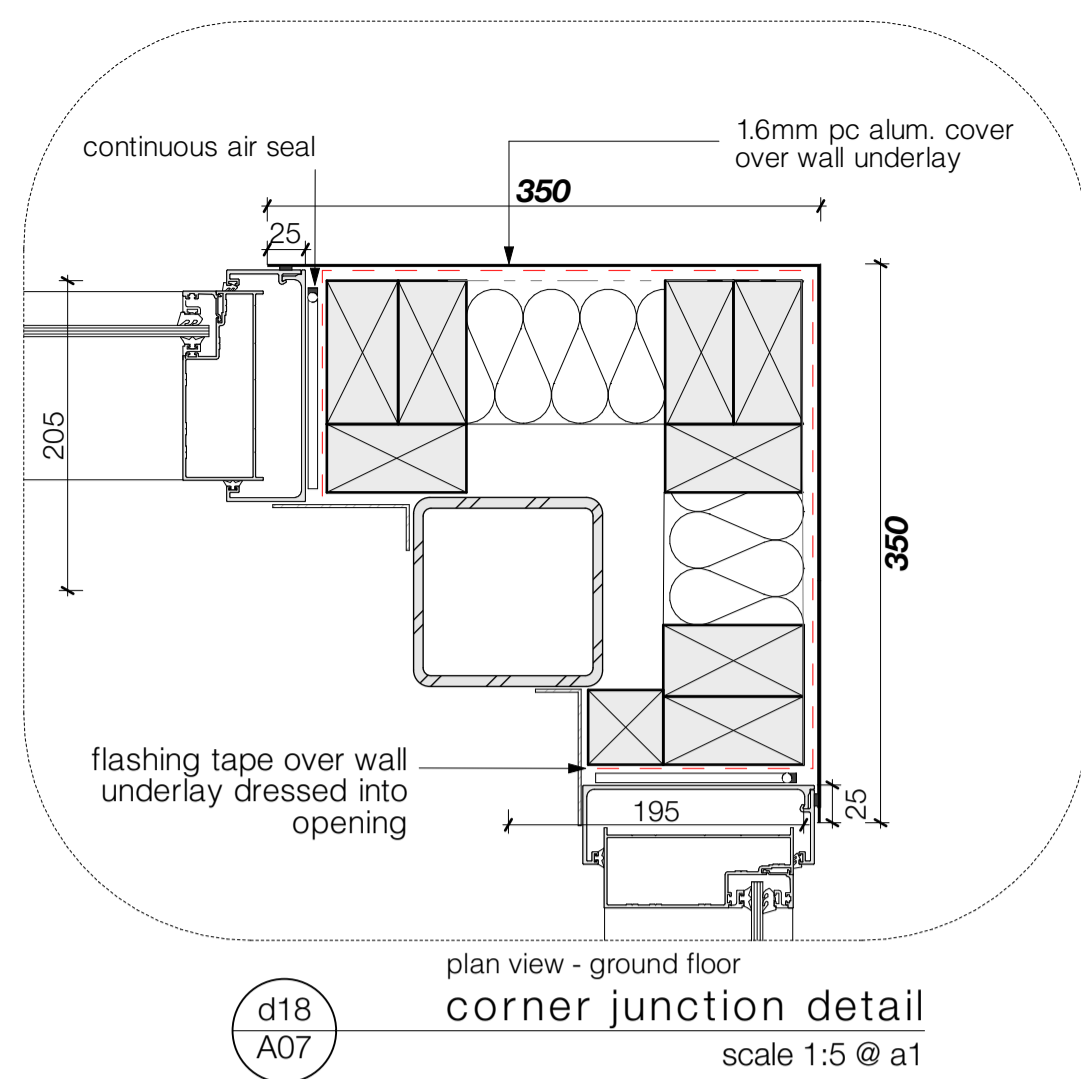
REV:

C01




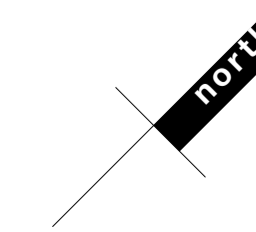


d14 wall junction detail scale 1:5 @ a1

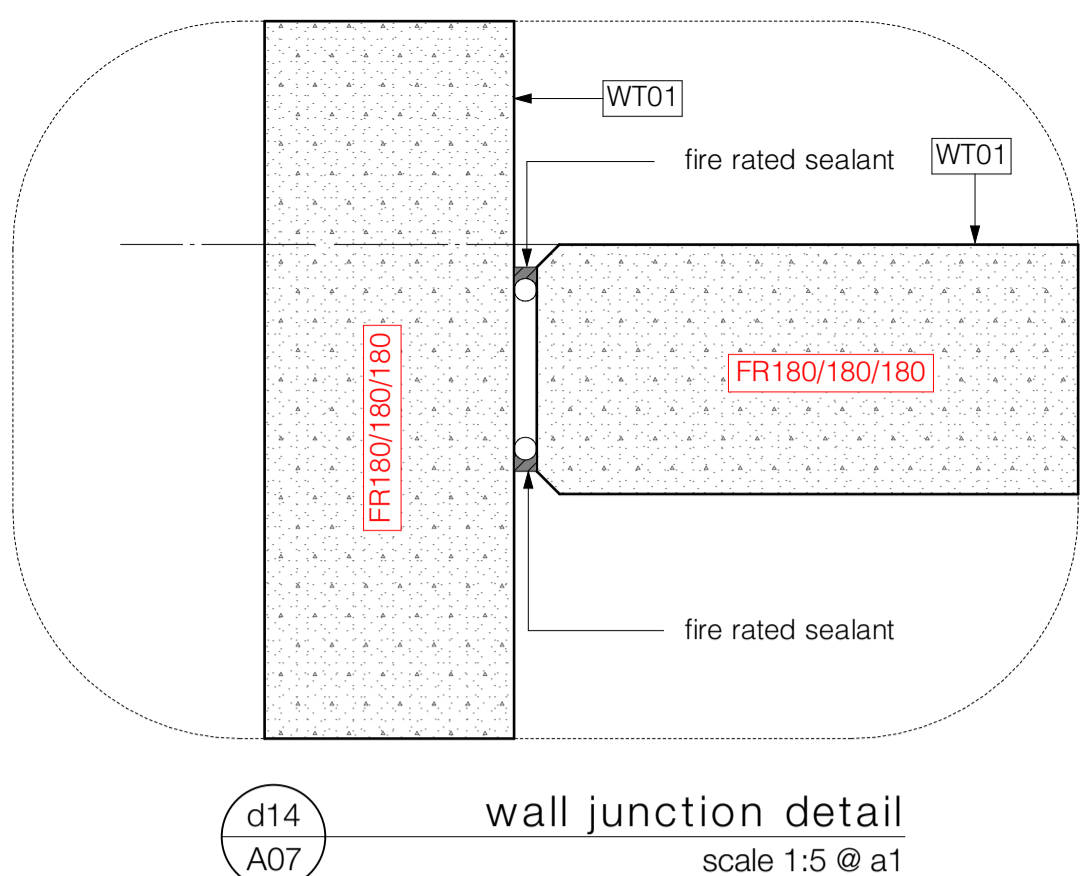


d18 plan view - ground floor corner junction detail scale 1:5 @ a1

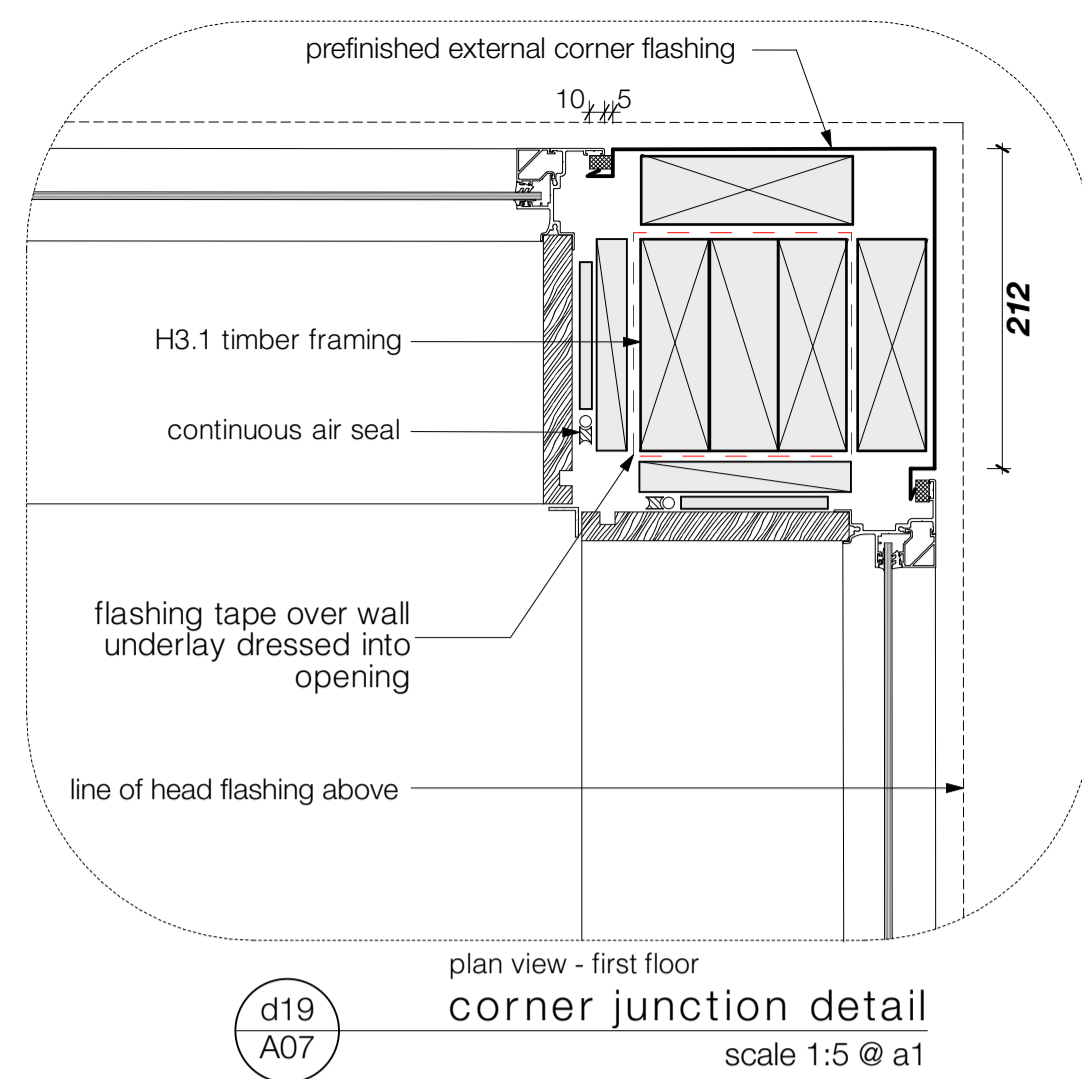


d19 plan view - first floor corner junction detail scale 1:5 @ a1

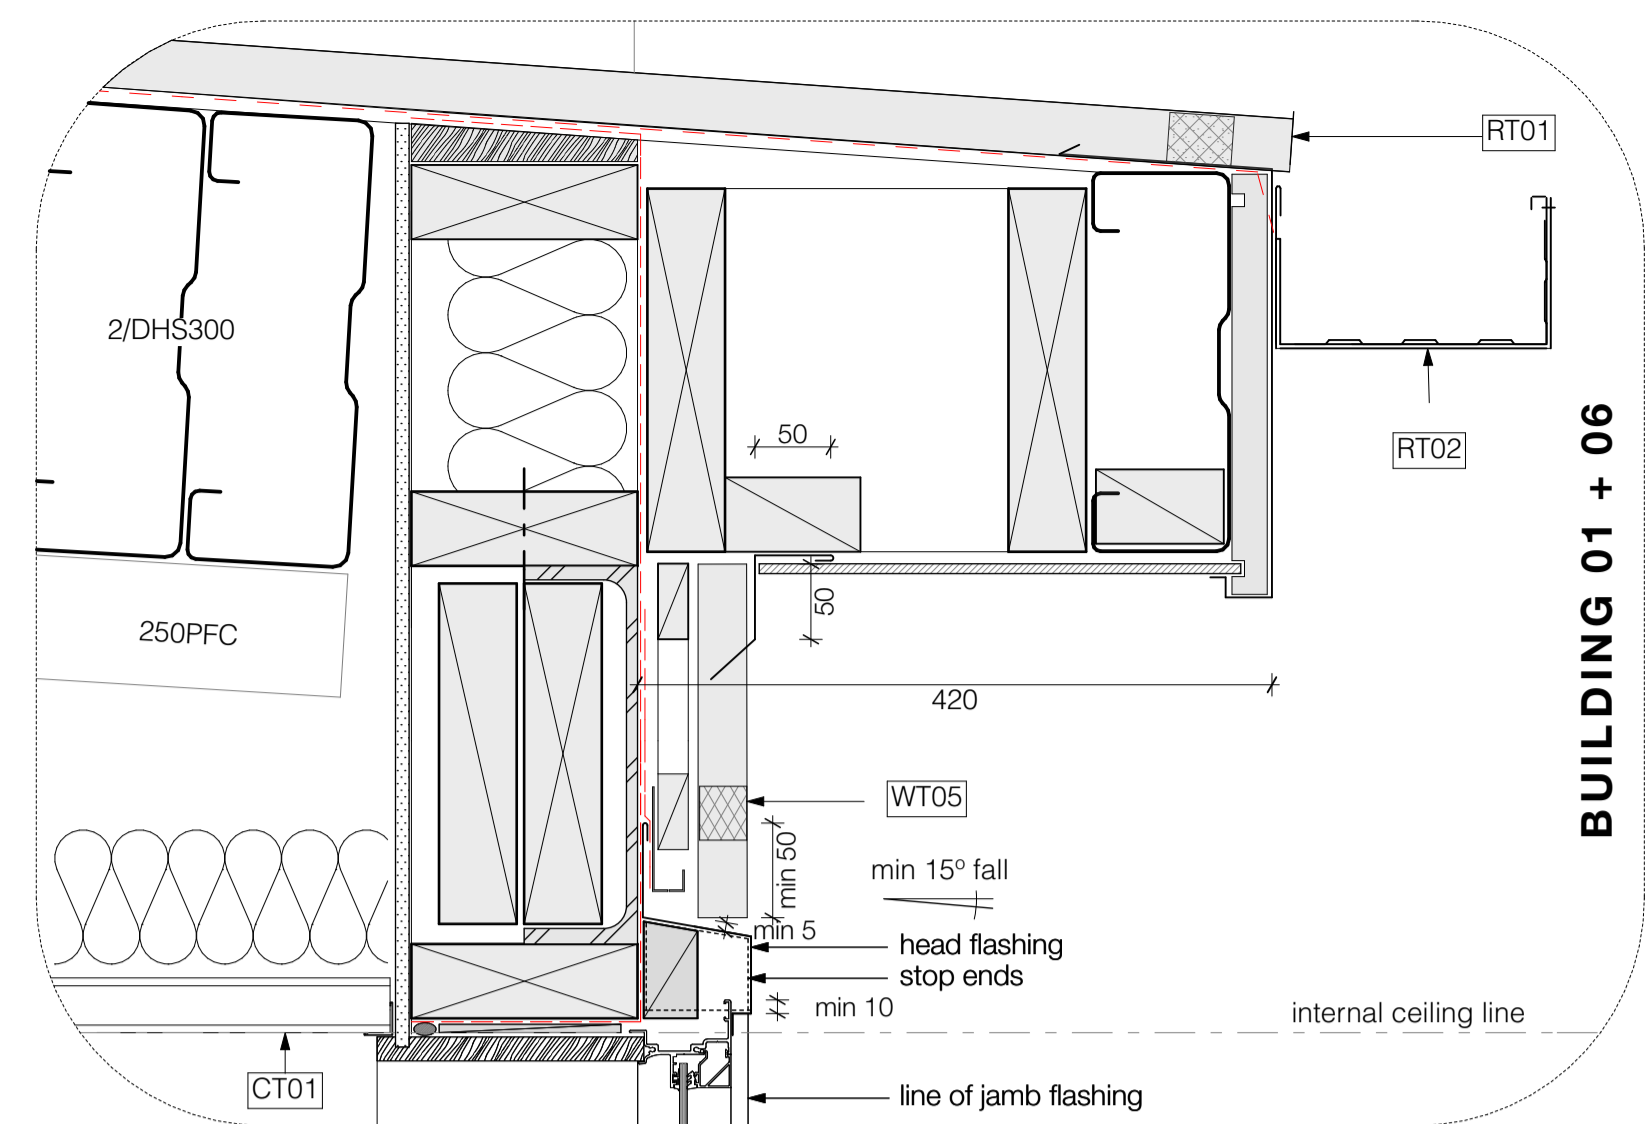


d21 eaves gutter detail scale 1:5 @ a1

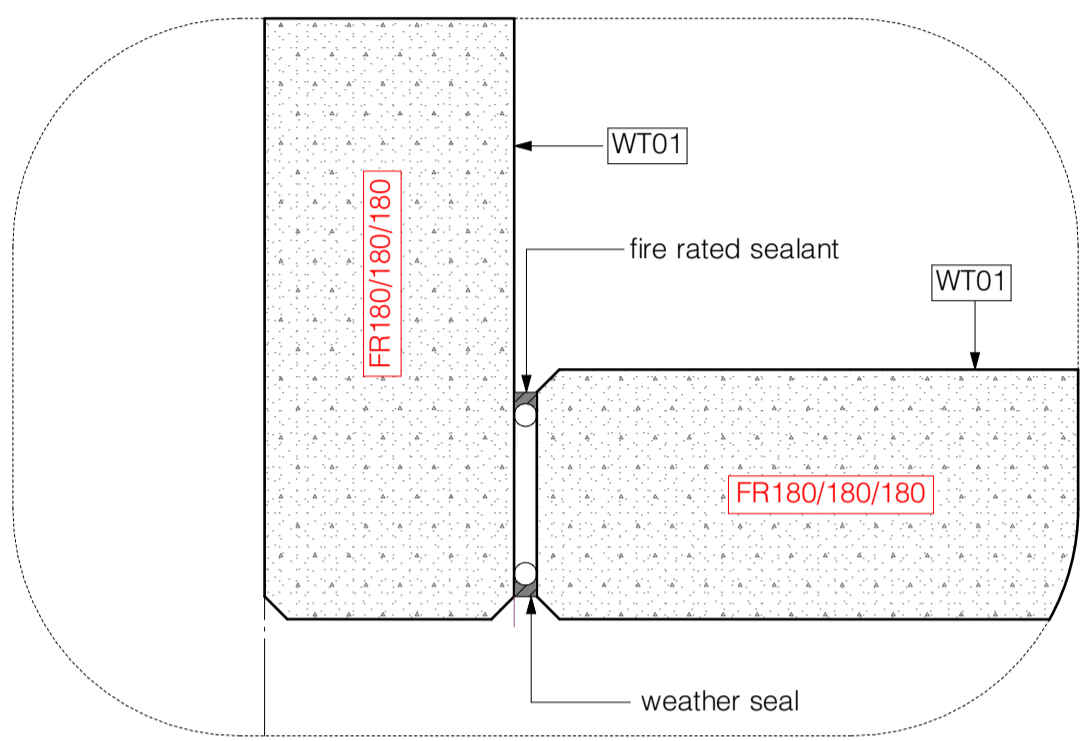


d15 wall junction detail scale 1:5 @ a1

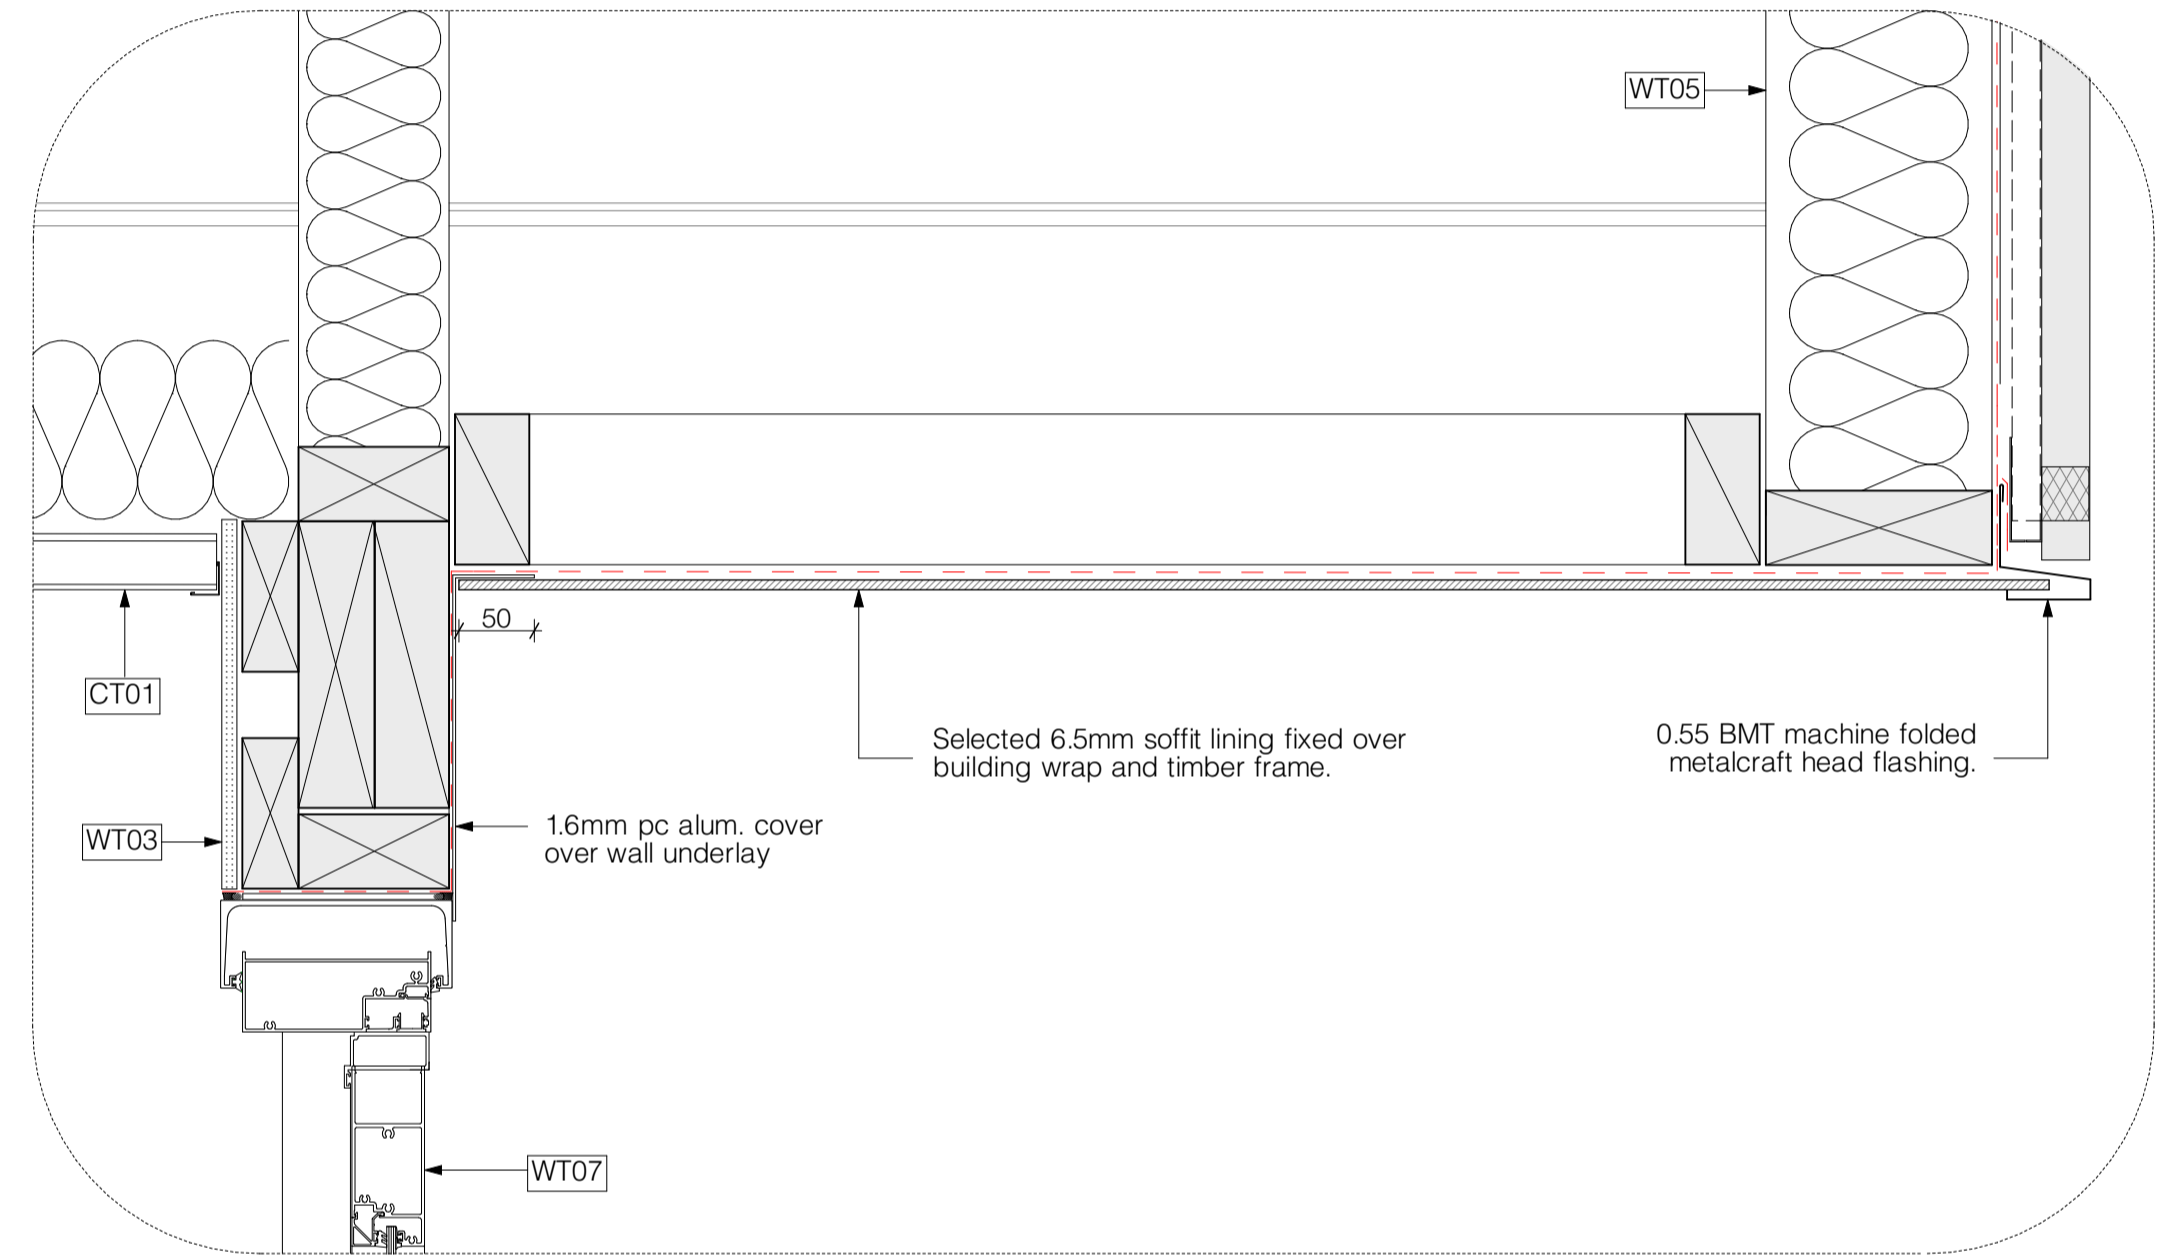


d22 soffit detail scale 1:5 @ a1

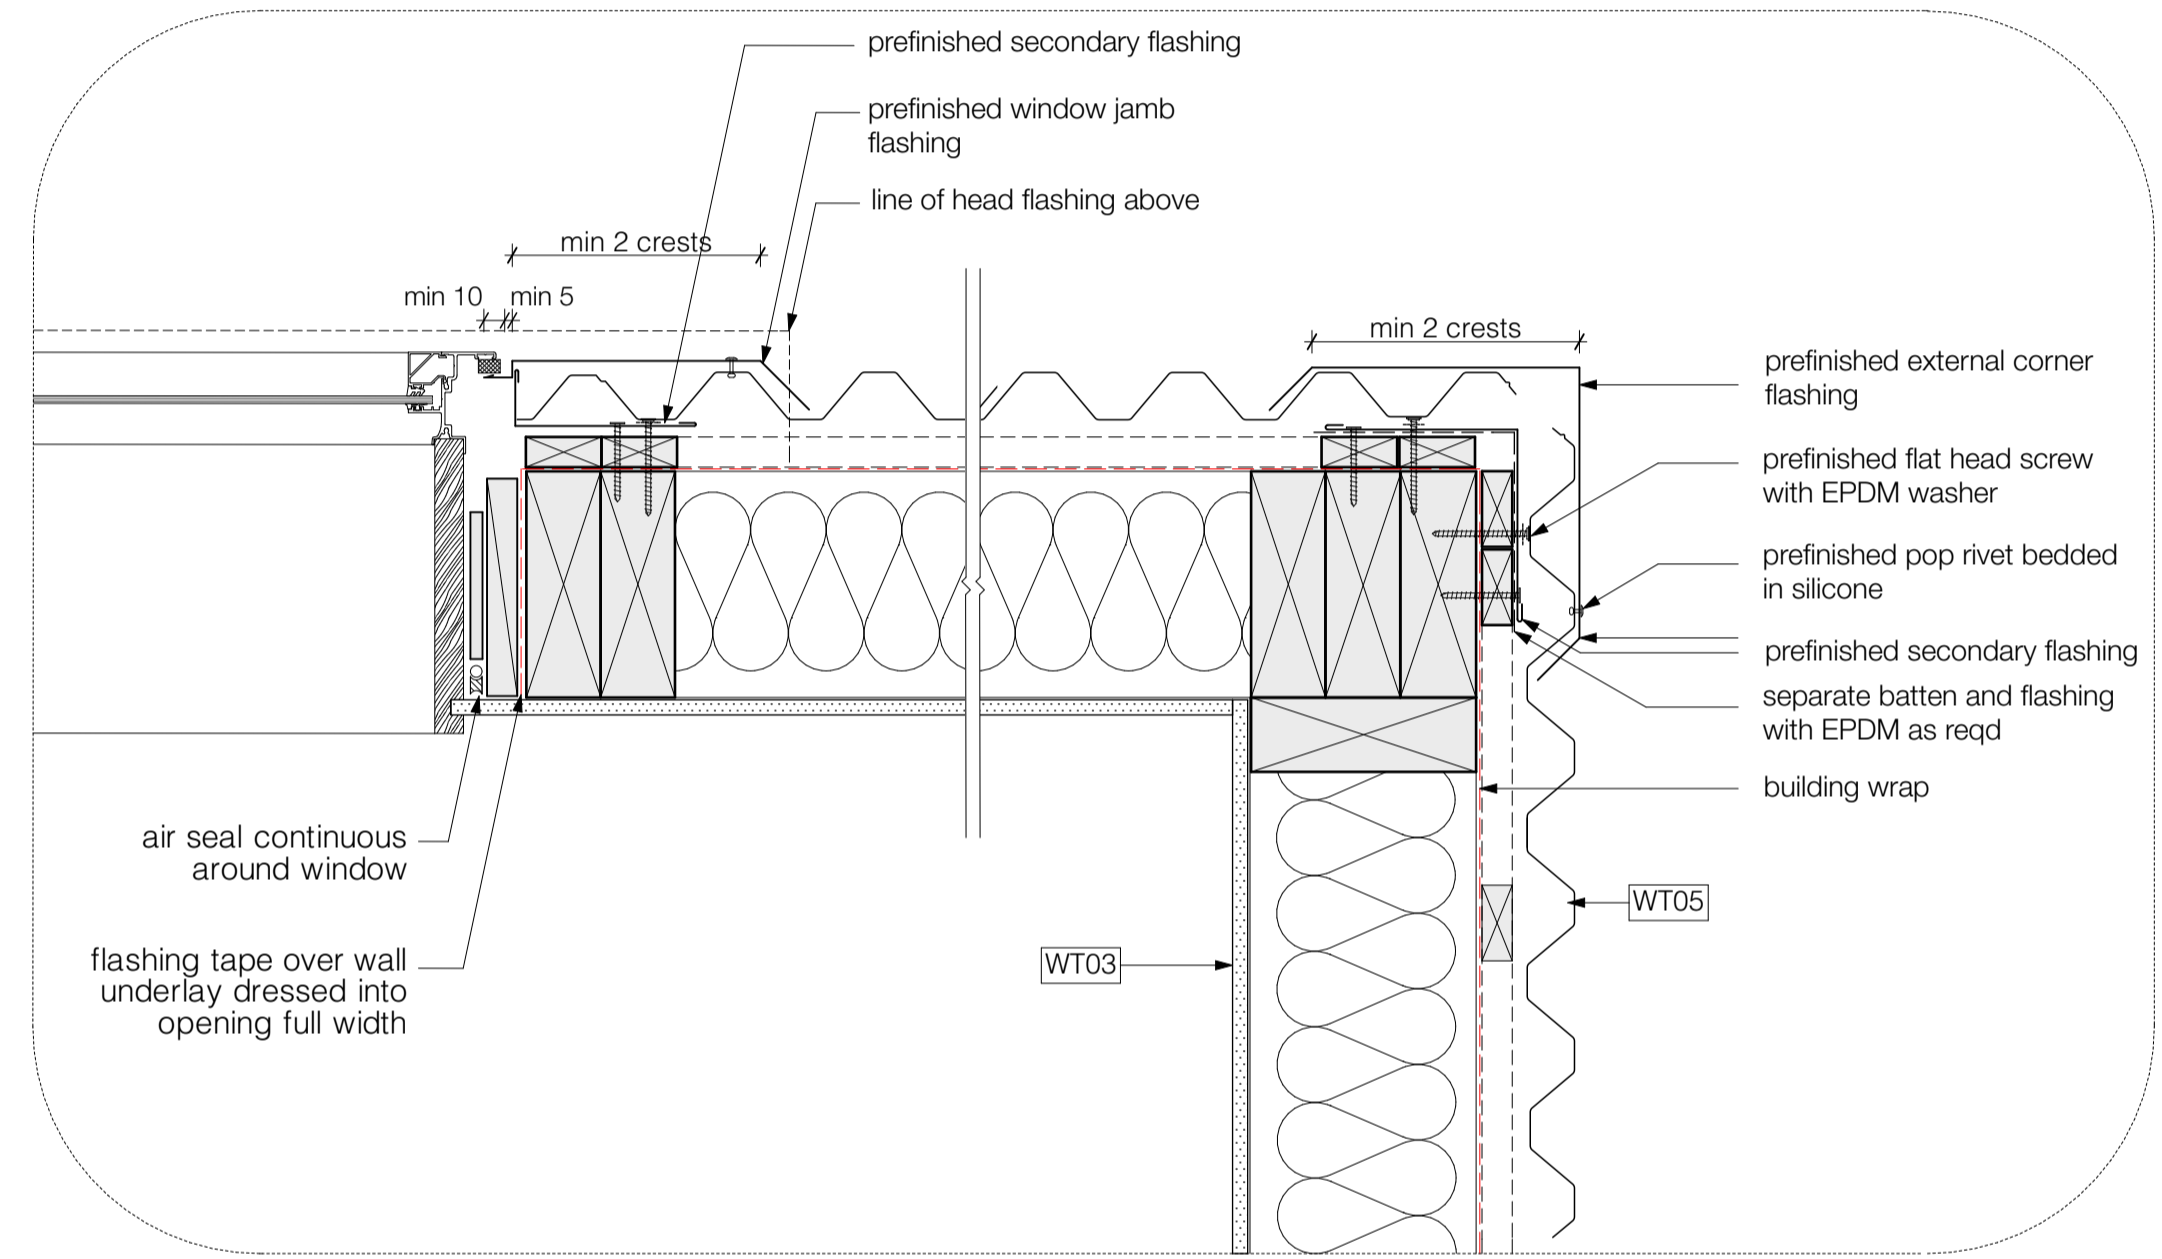


d23 external corner detail scale 1:5 @ a1

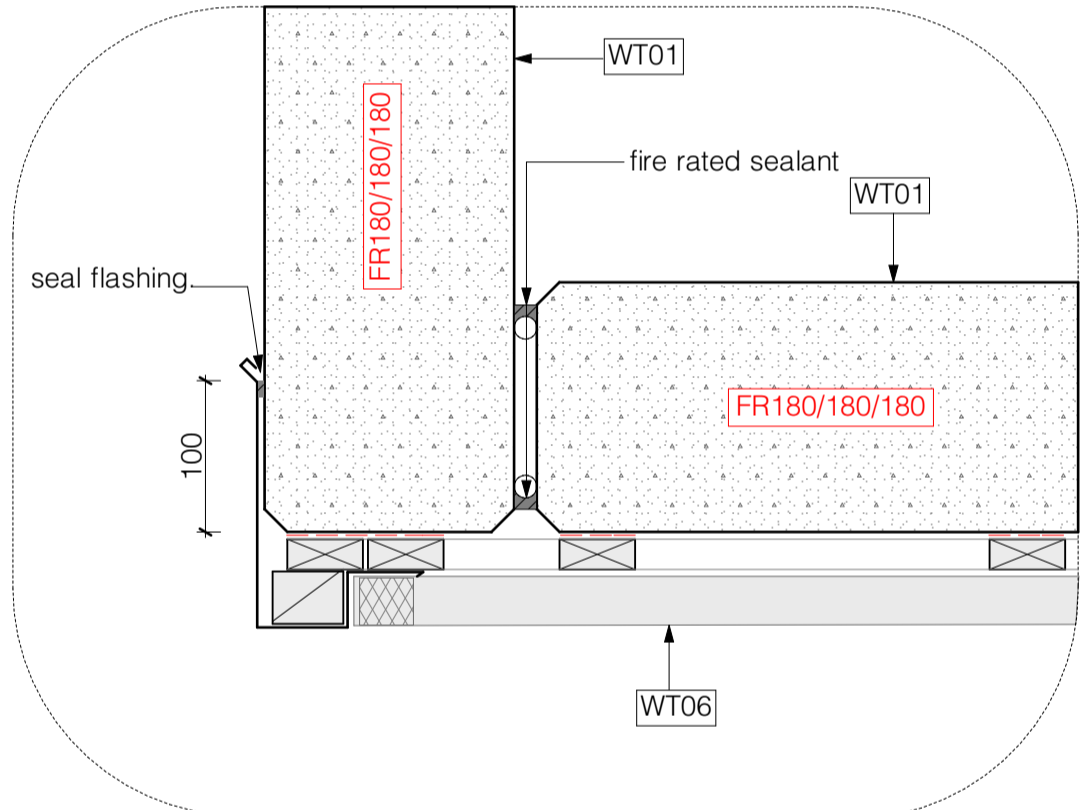


d16 pc cladding detail scale 1:5 @ a1

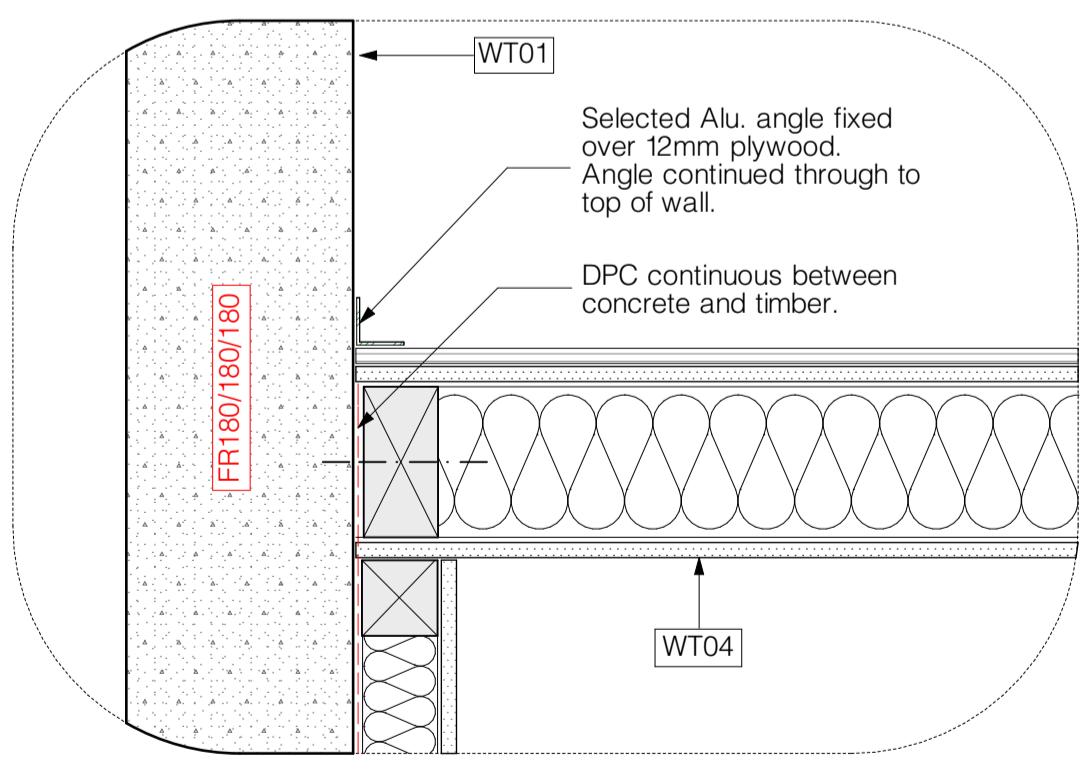


d17 plan view - internal wall junction detail scale 1:5 @ a1

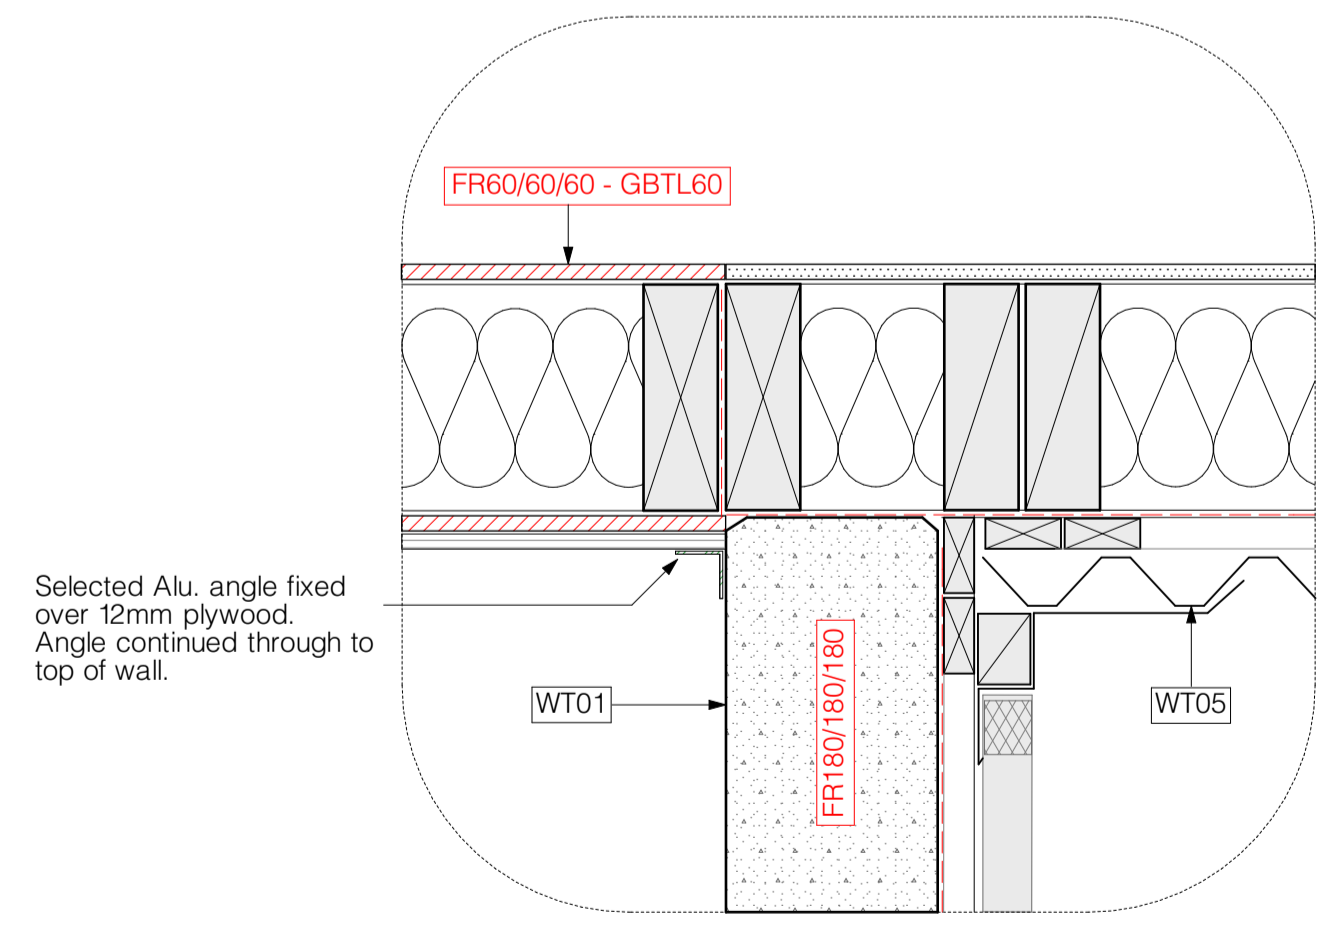

d24 wall junction detail scale 1:5 @ a1

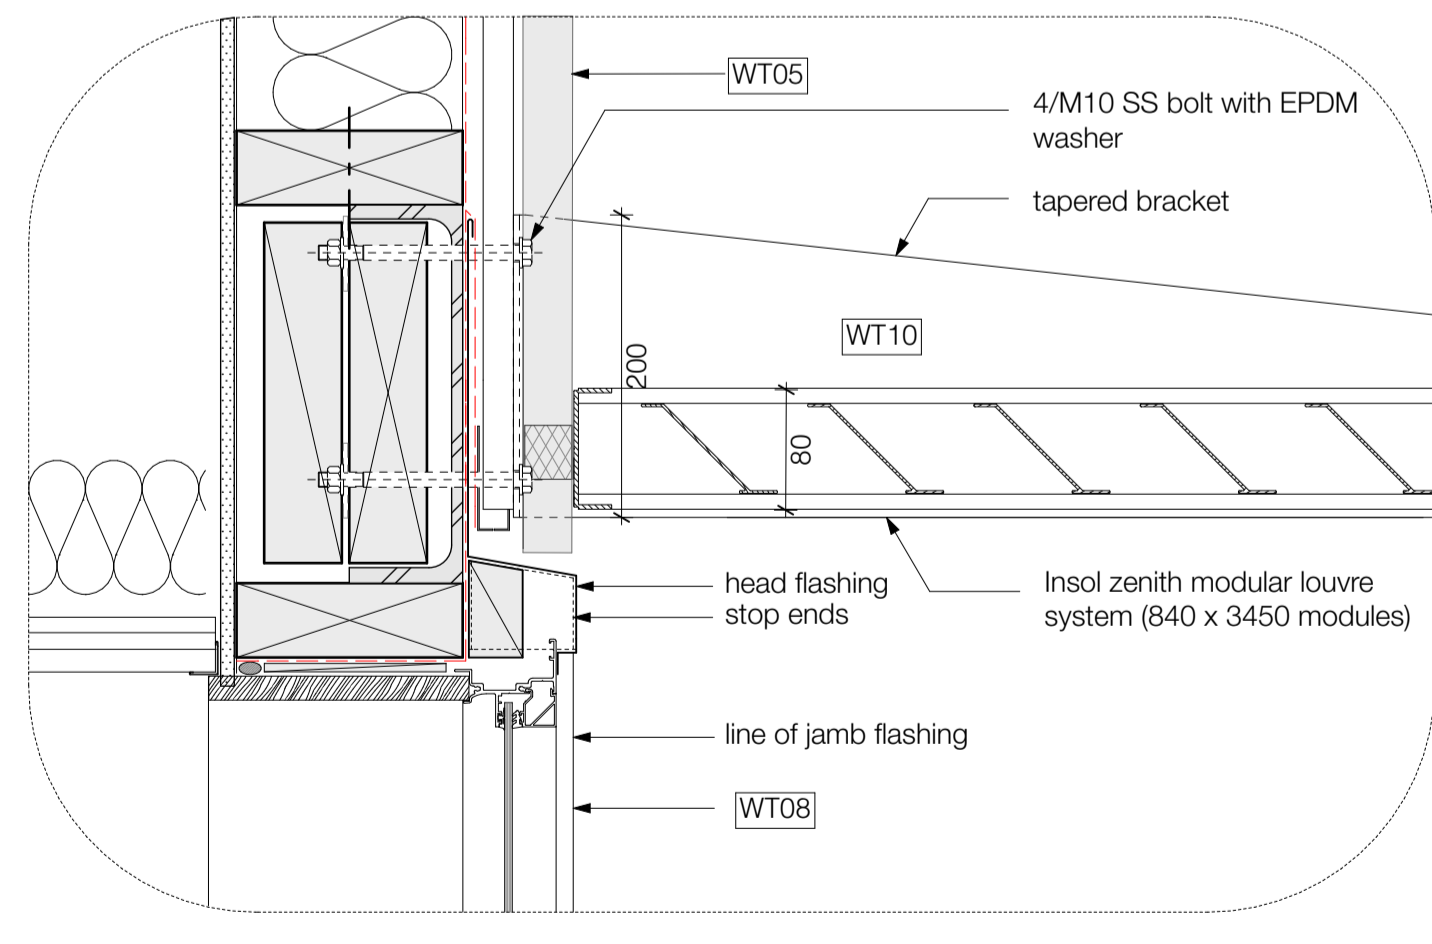

d28 sun screen detail scale 1:5 @ a1

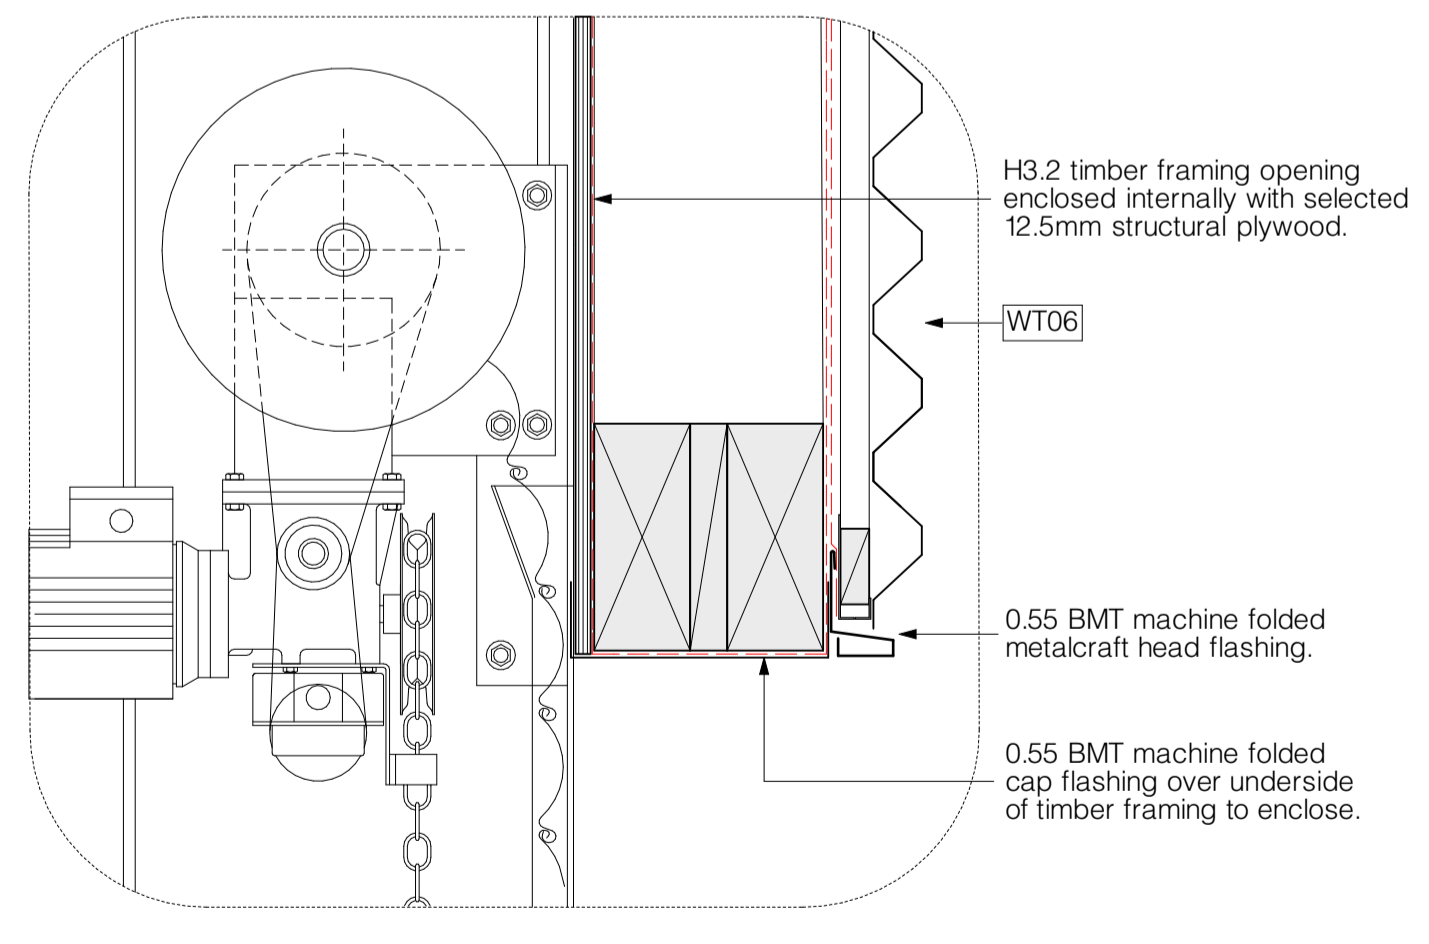

d31 roller door head detail scale 1:5 @ a1

NOTE:
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ISSUE:	DATE:
C01	25/06/19


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PROJECT:
Te Rapa Stage 2
CLIENT: Fosters Construction
SITE: Te Rapa Industrial Park, Hamilton


FOR CONSTRUCTION ISSUE

DRAWING TITLE:
DETAILS - WALLS


PROJECT REF: T0424 TE RAPA S2	
DATE: 25/06/19	SCALE: 1:5 @ A1
SHEET: A34	REV: C01

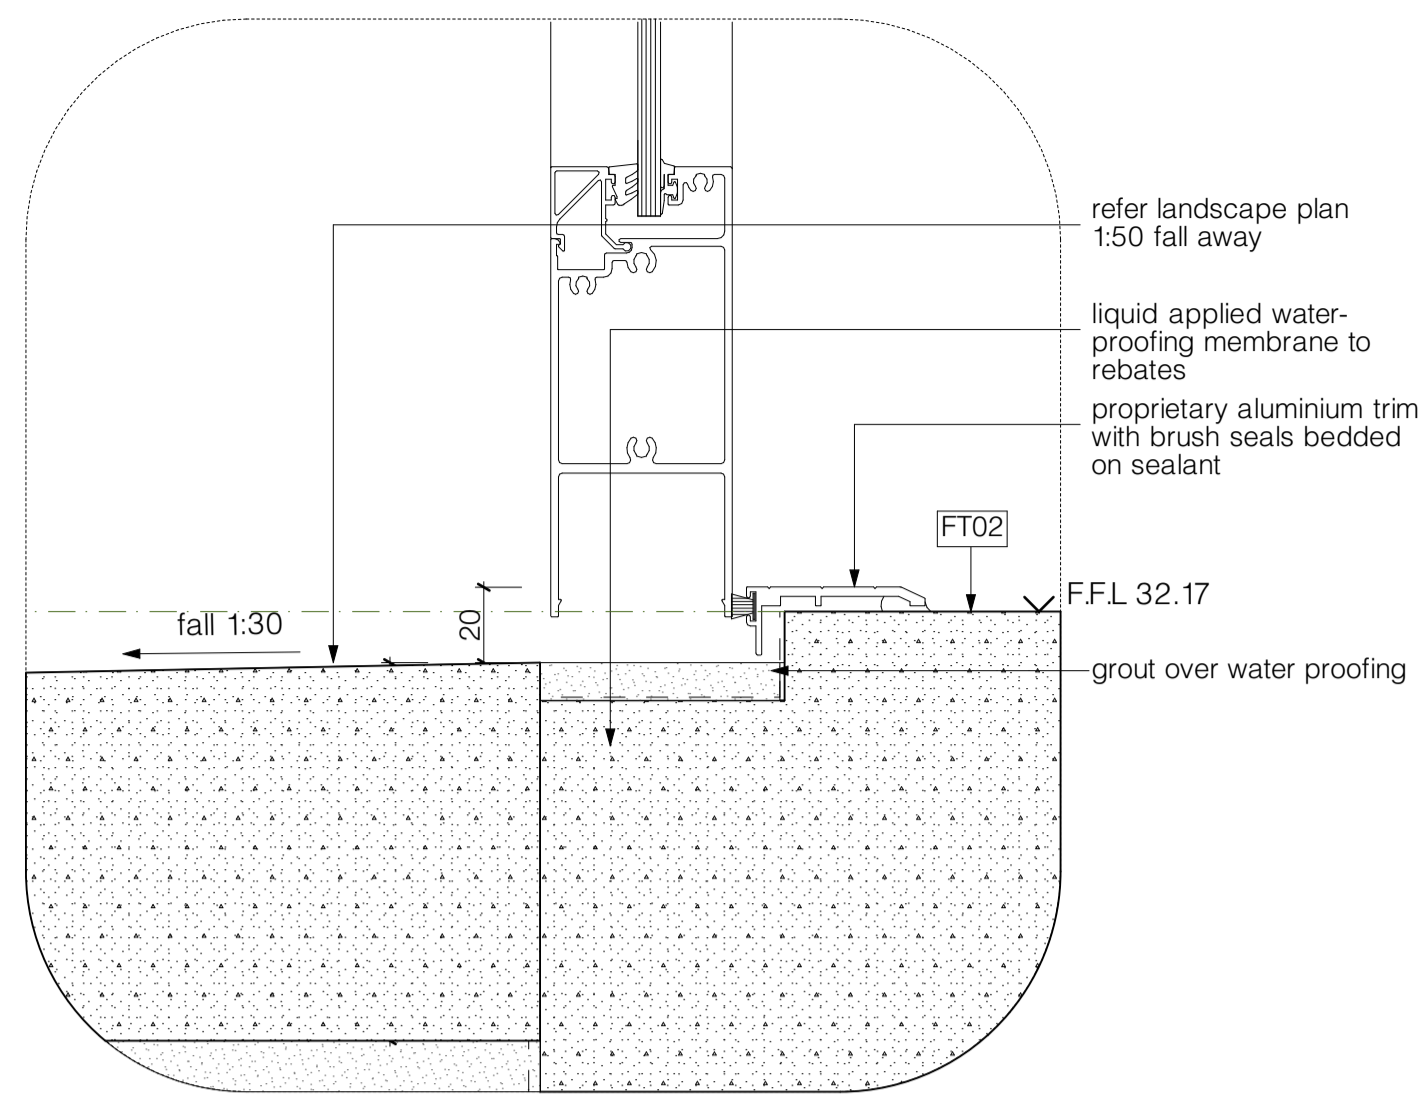


d25 office entry + egress door sill detail
scale 1:2 @ a1

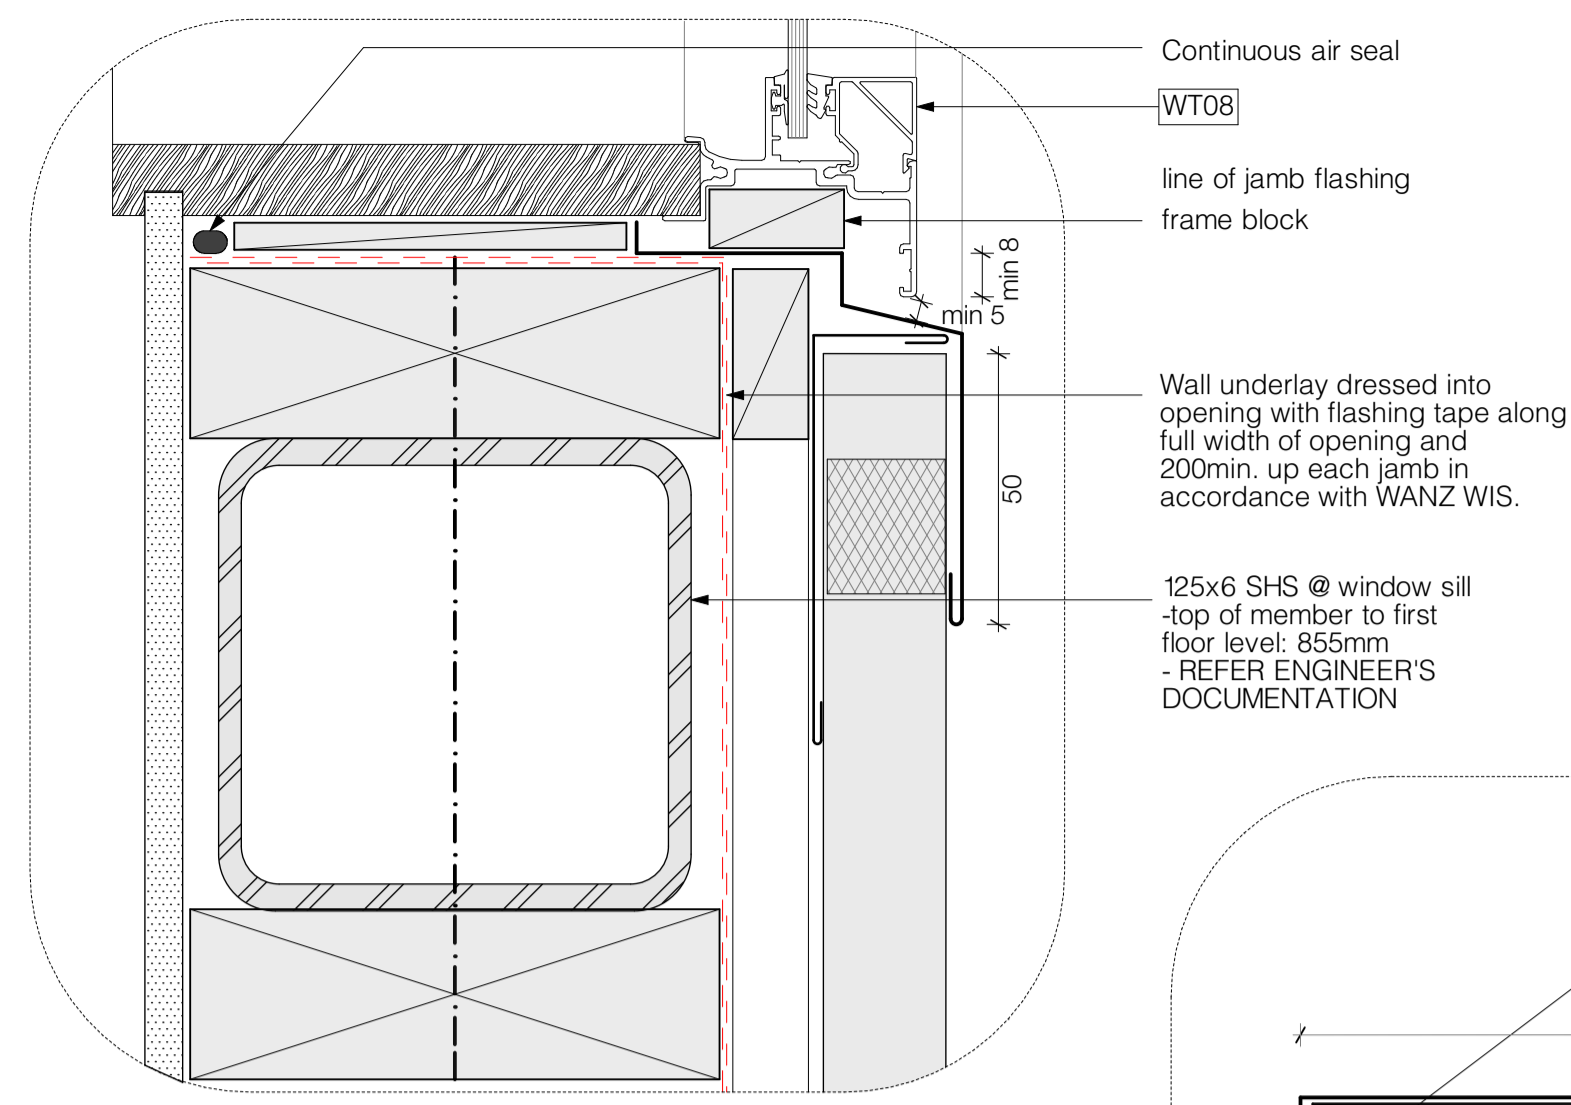


d28 office window sill detail
scale 1:2 @ a1

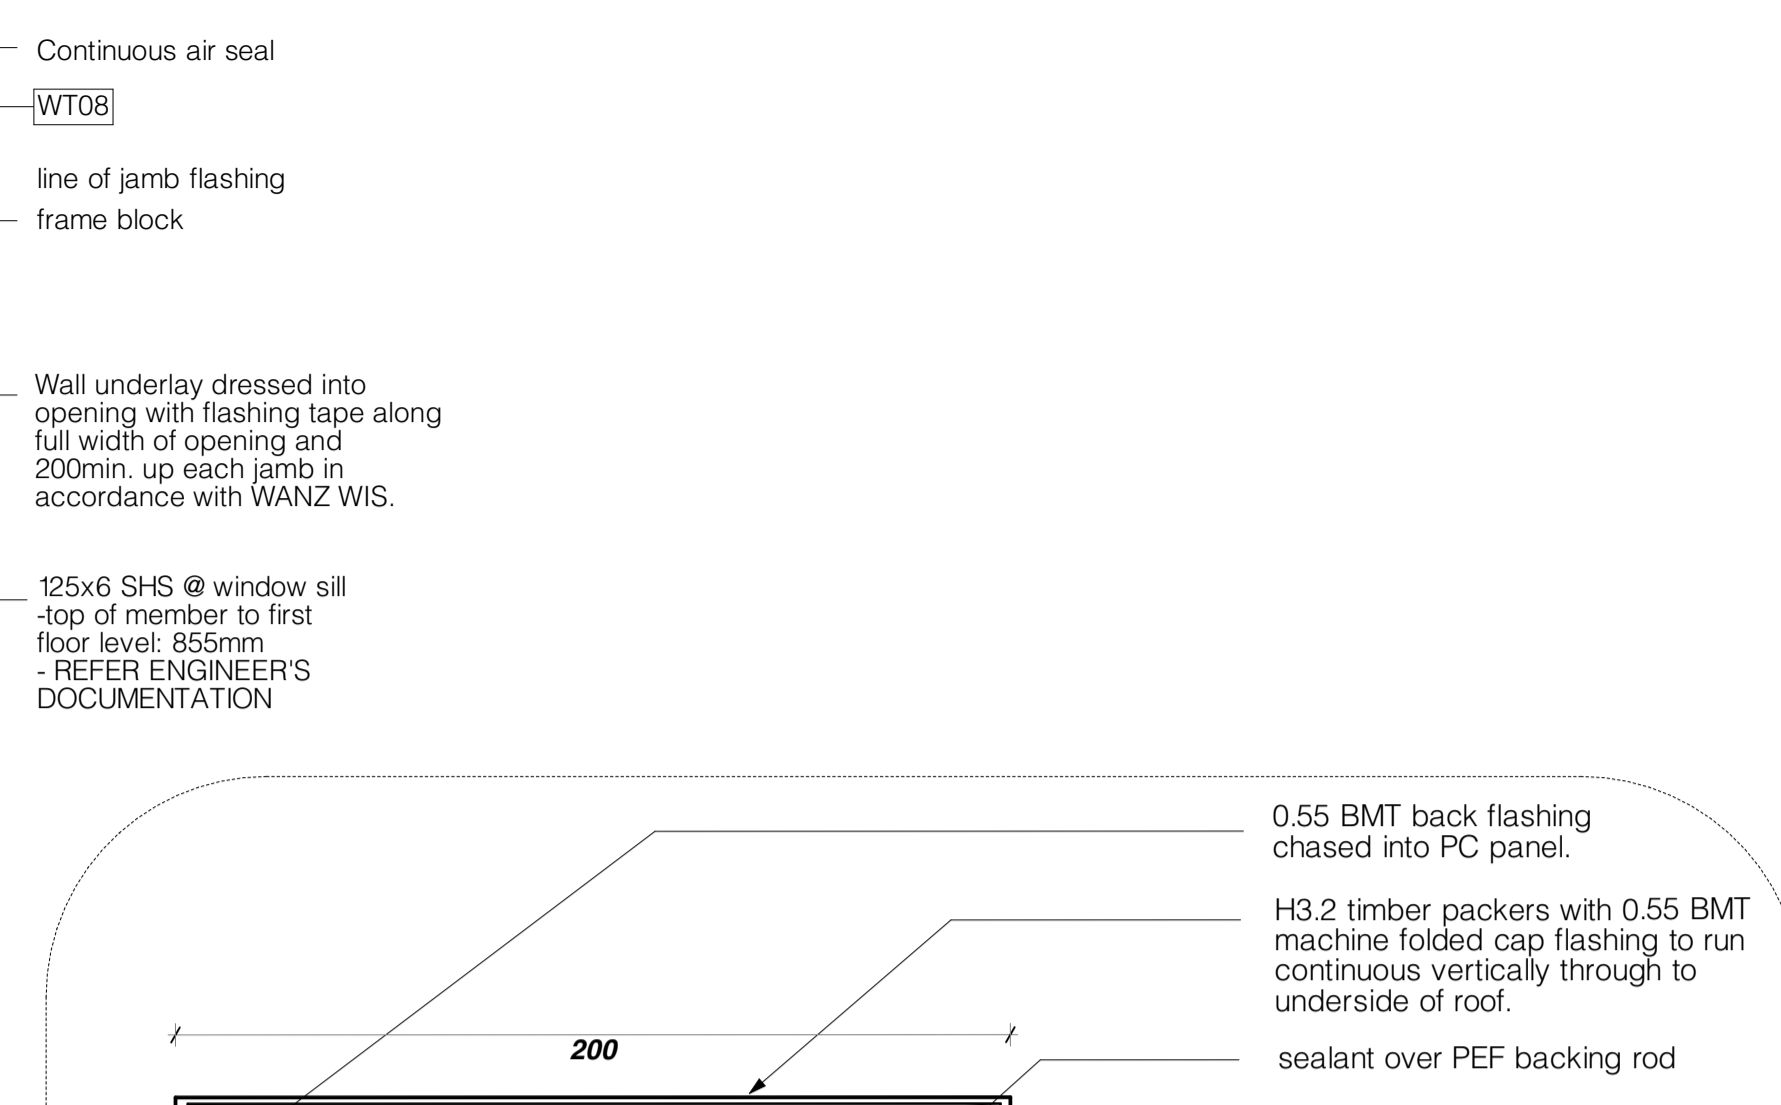


d20 office egress door jamb detail
scale 1:2 @ a1

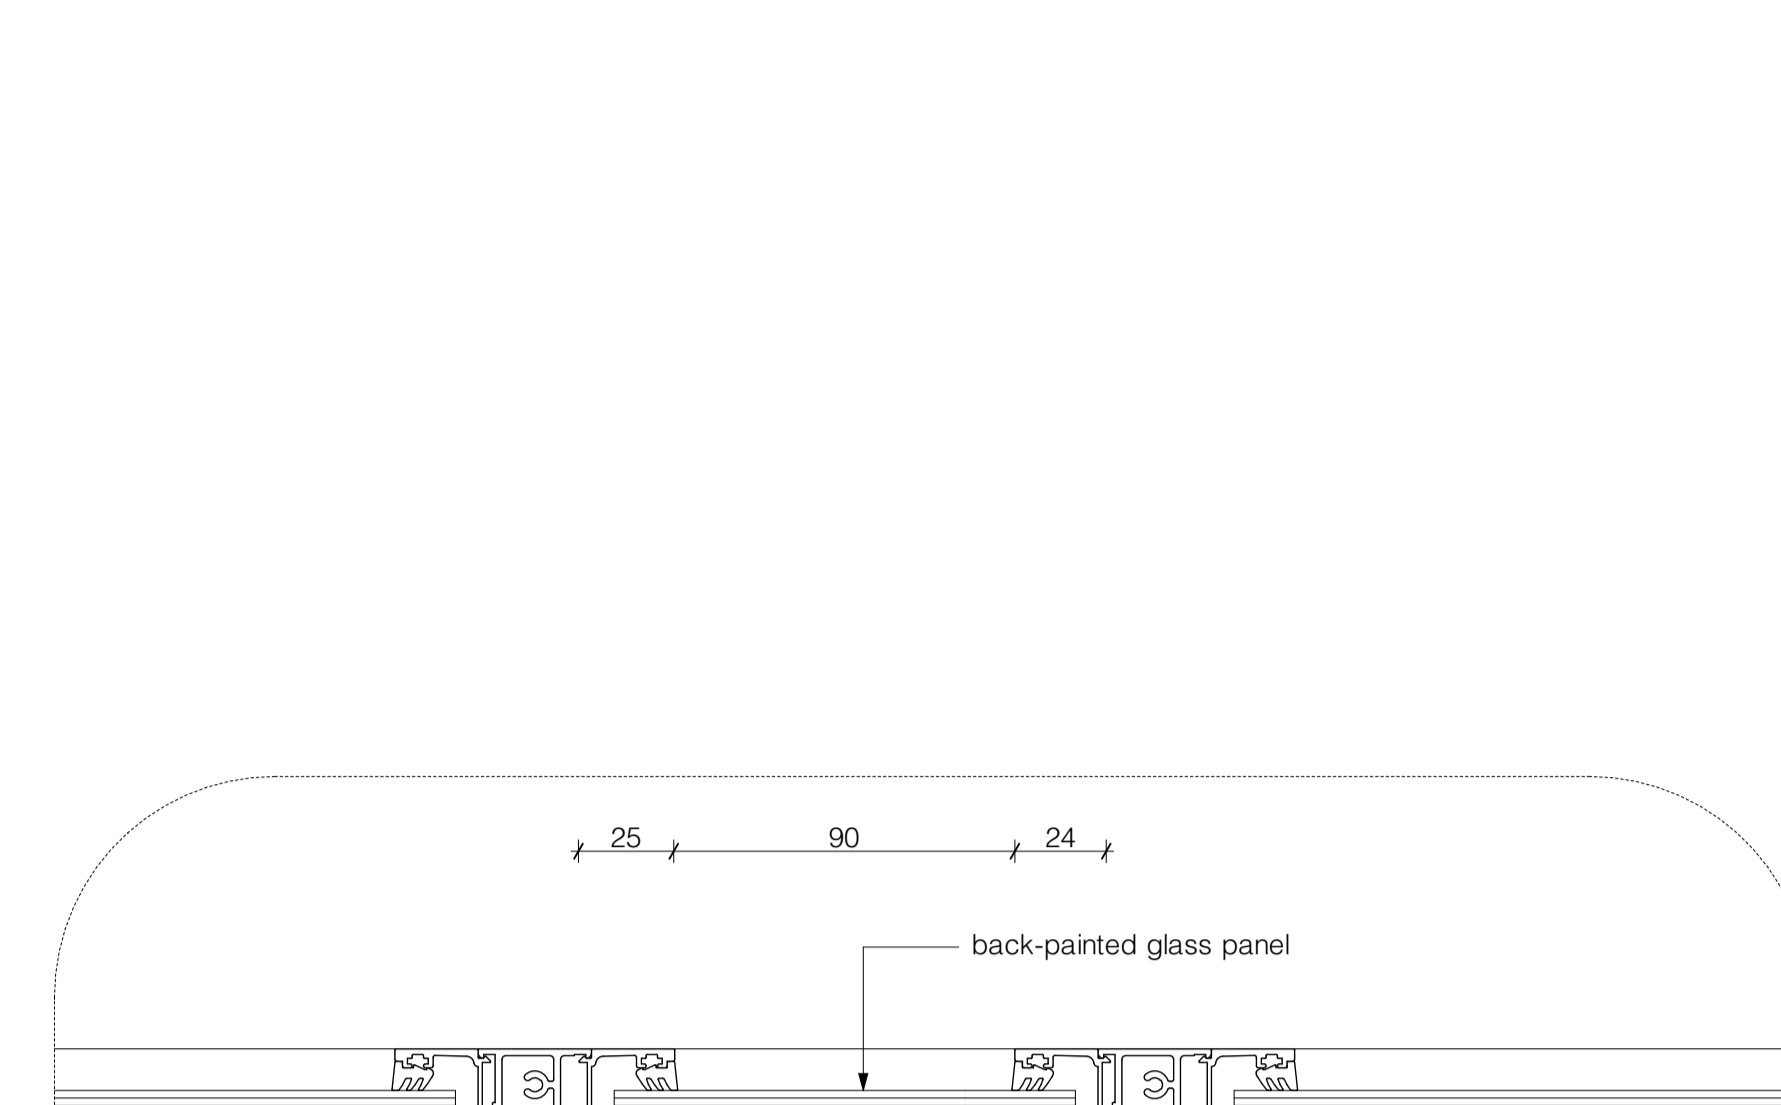


d35 office window wall junction detail
scale 1:2 @ a1

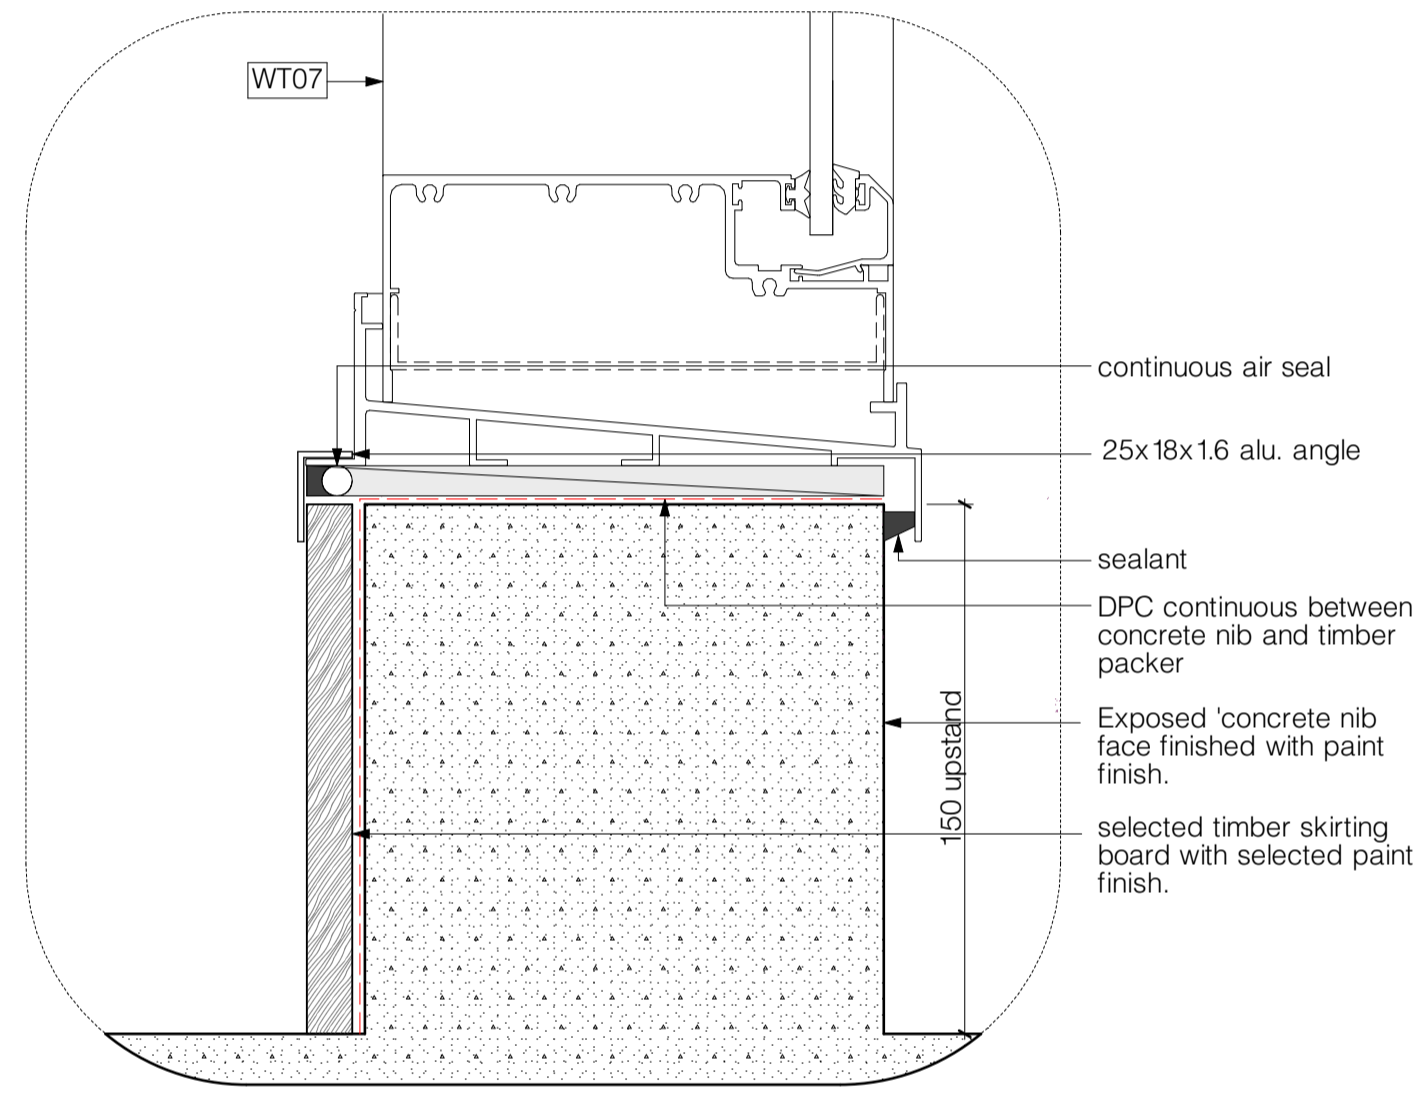


d26 office window sill detail
scale 1:2 @ a1

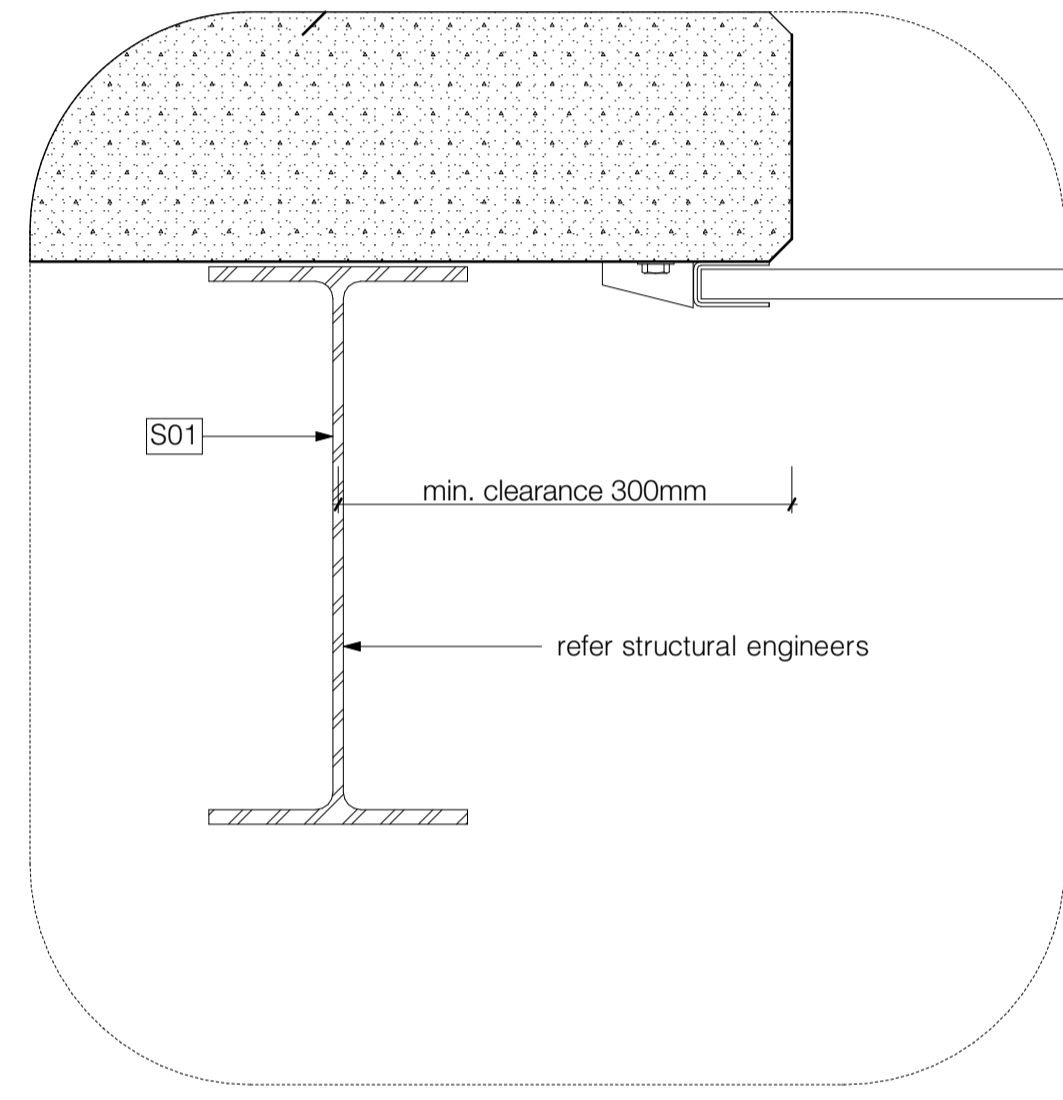


d29 roller door jamb detail
scale 1:2 @ a1

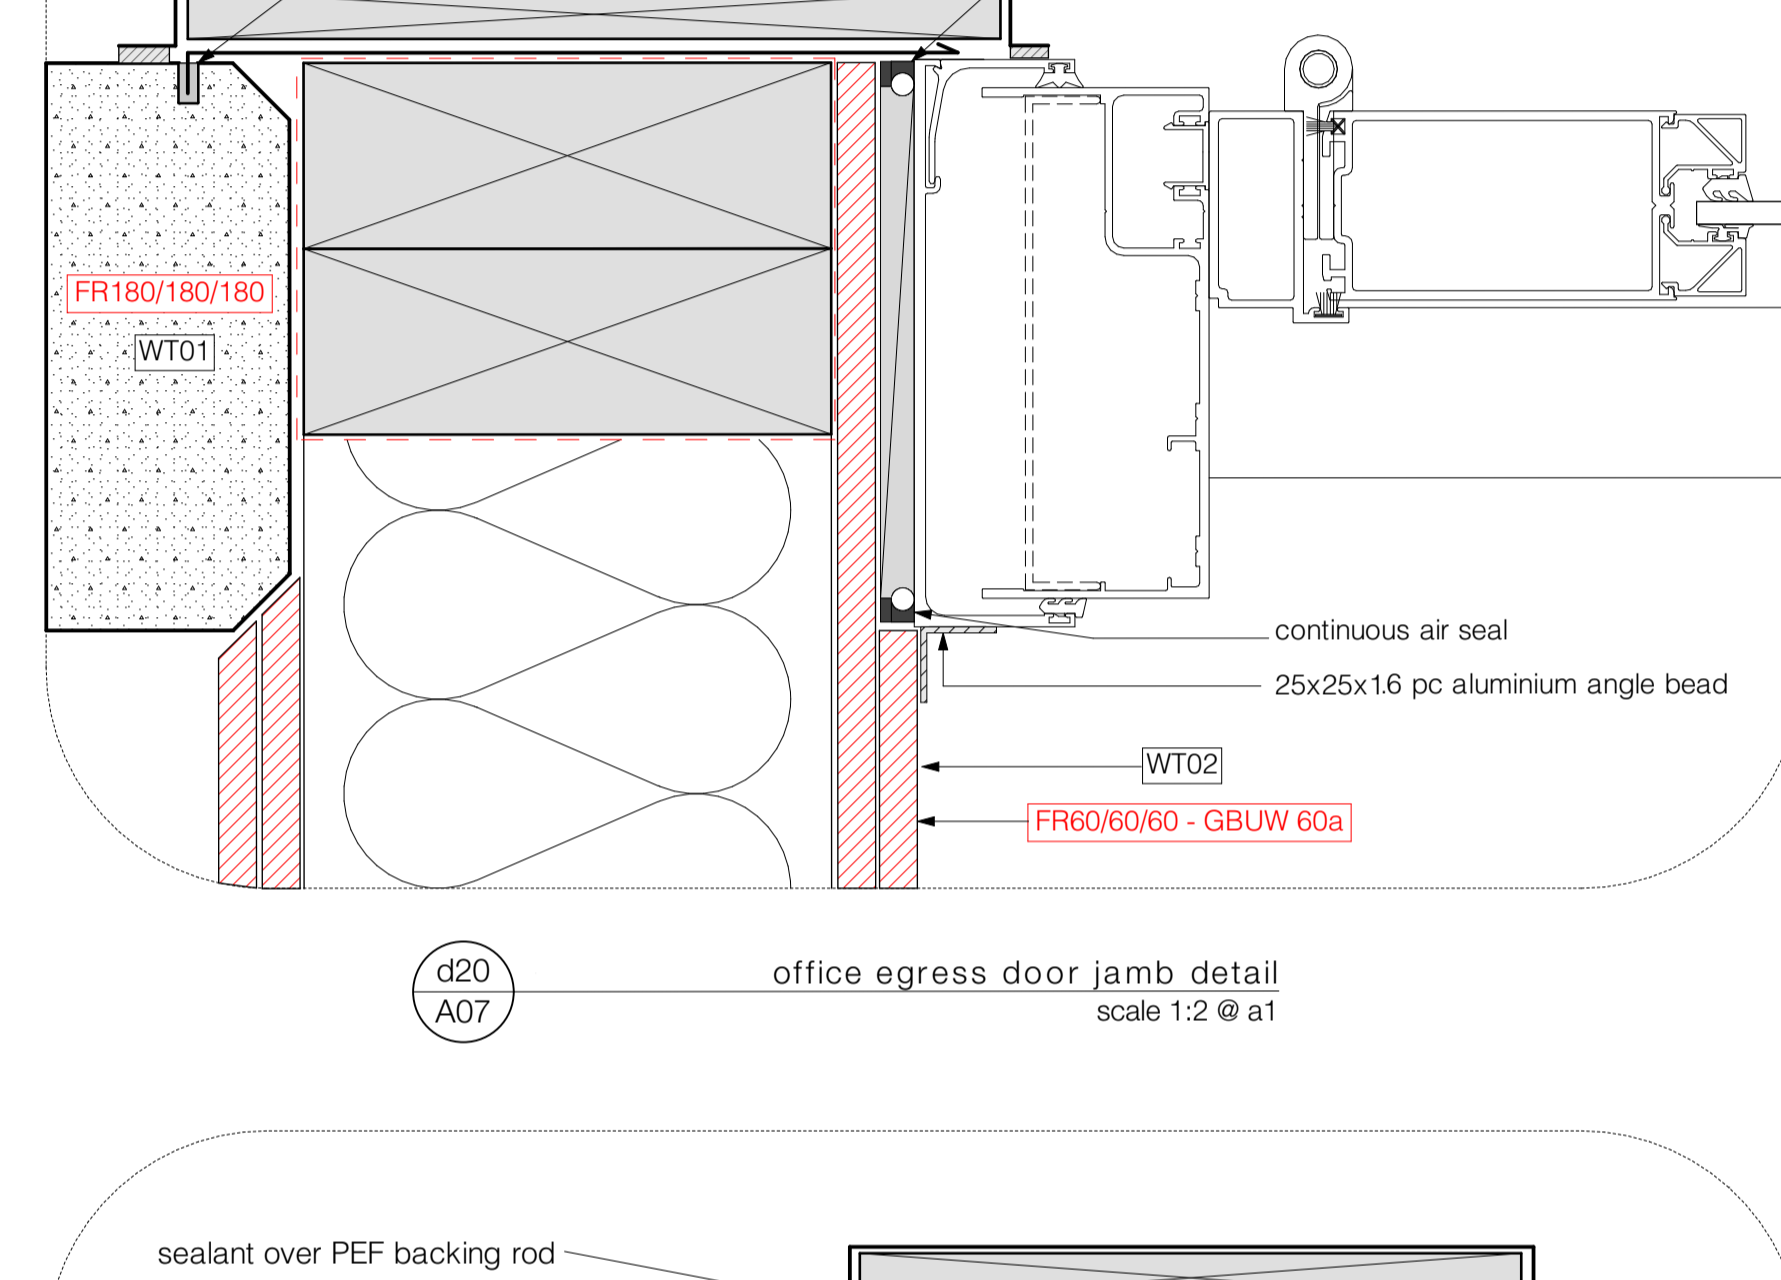


d33 office egress door jamb detail
scale 1:2 @ a1

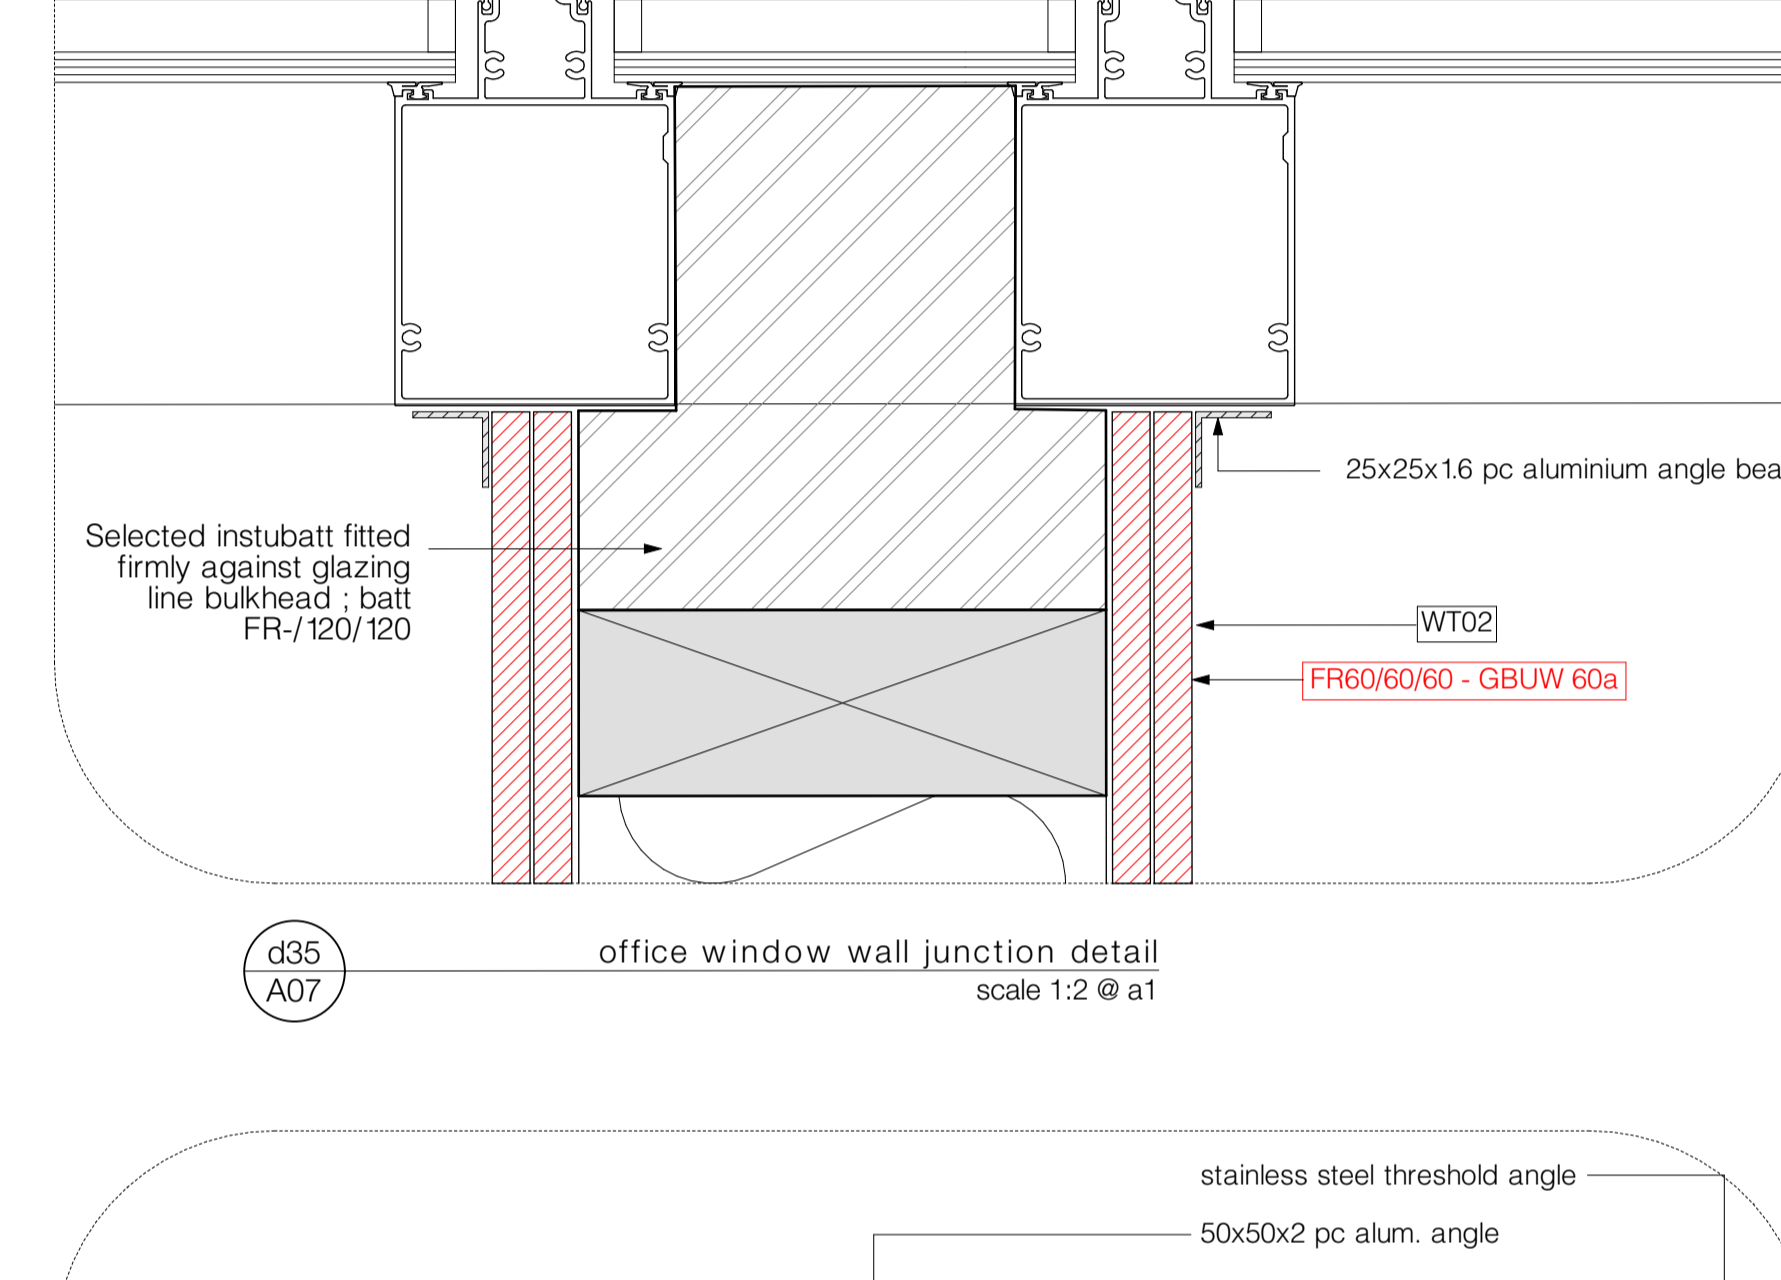


d34 warehouse egress door / PC panel
scale 1:2 @ a1

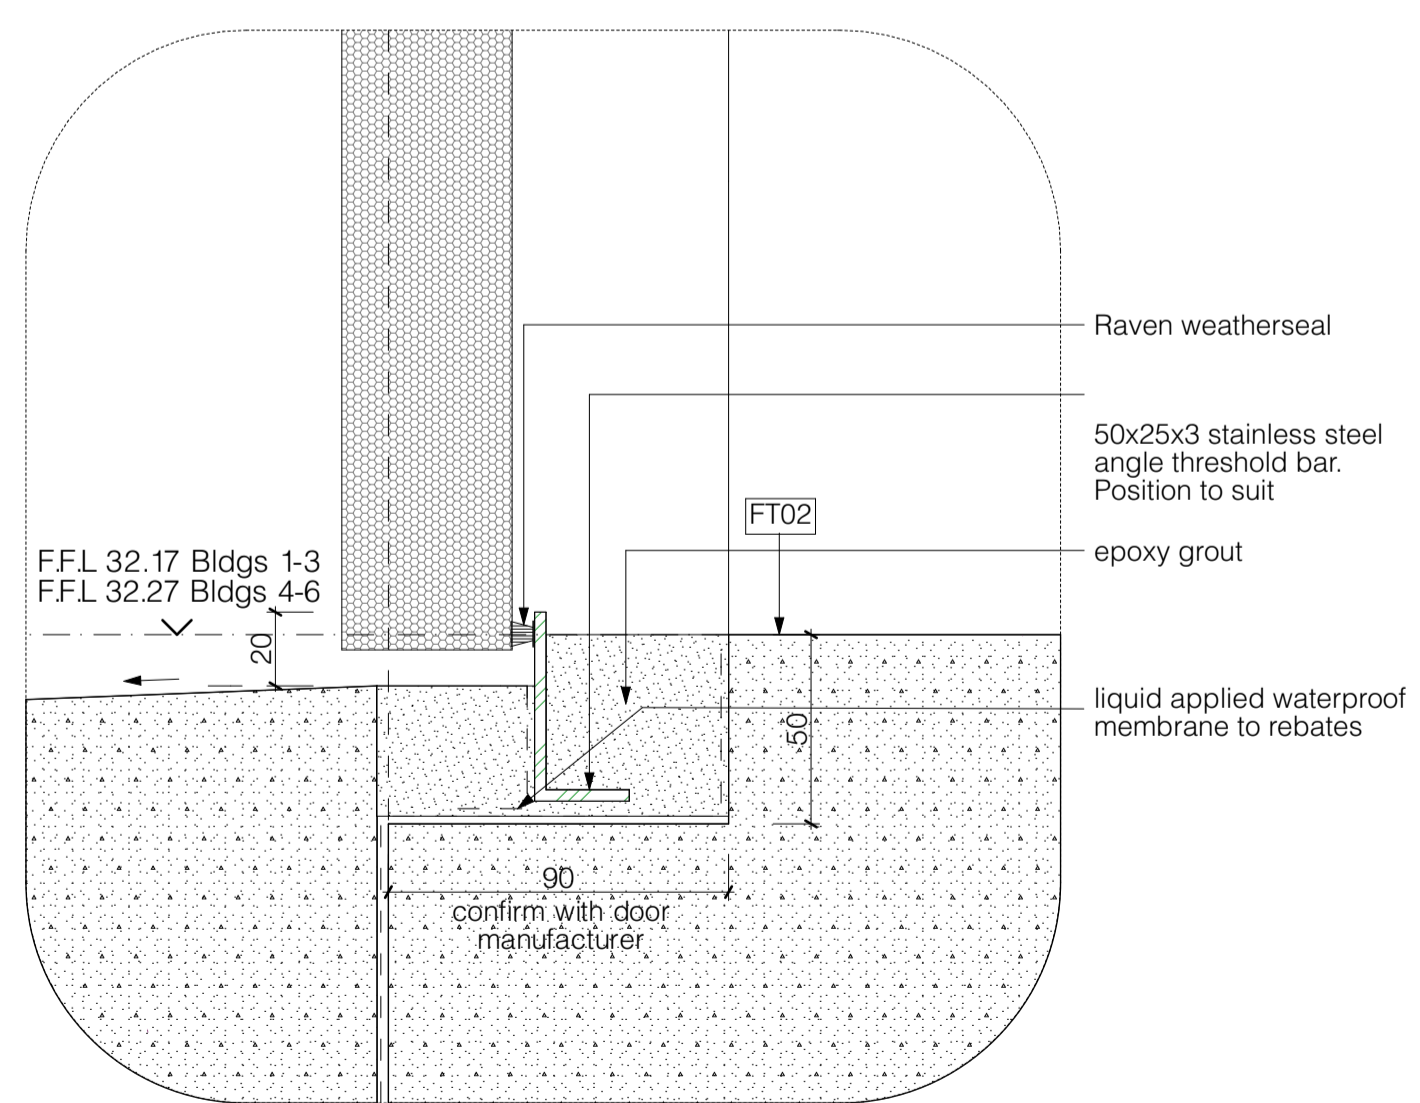


d27 warehouse egress door sill detail
scale 1:2 @ a1

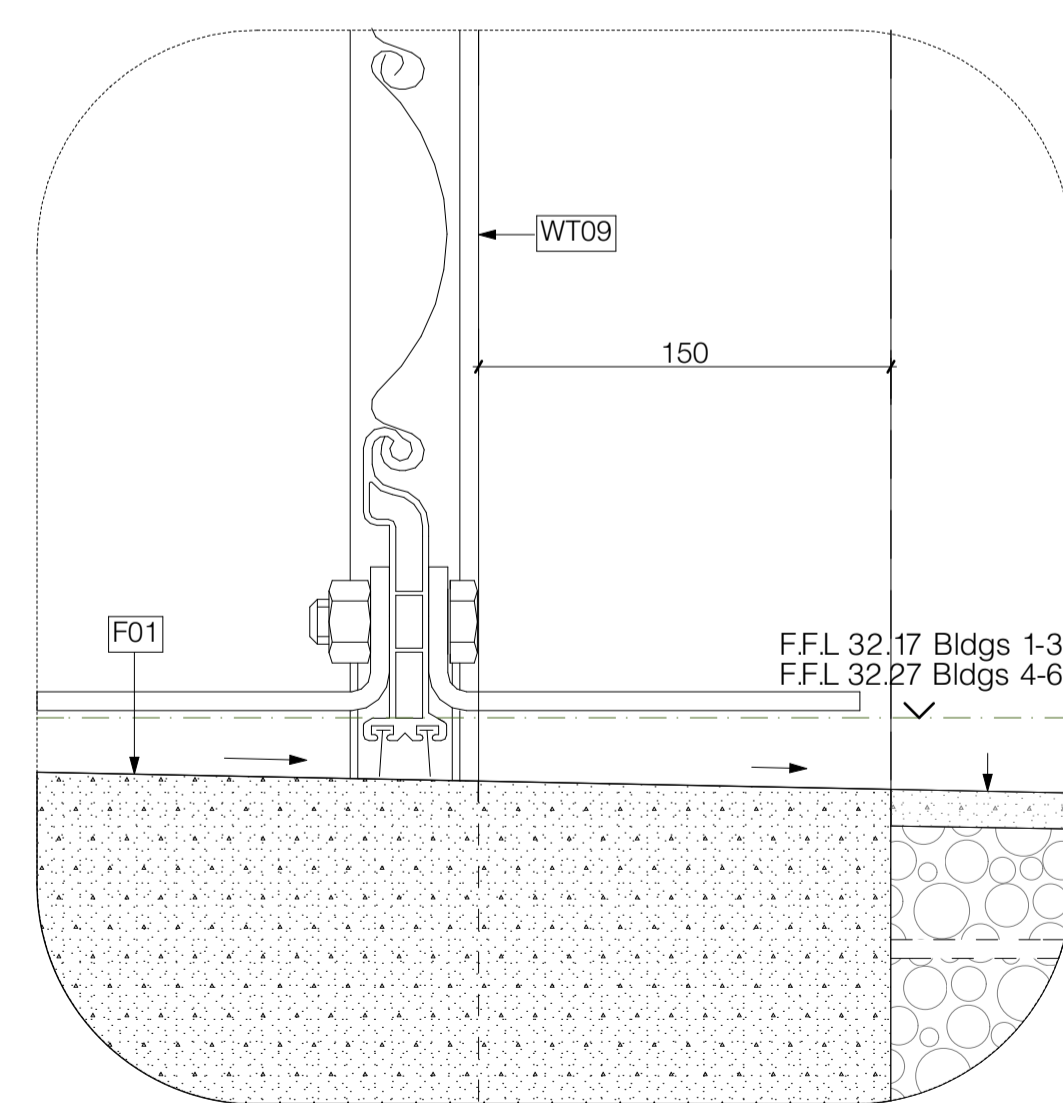

d30 roller door sill detail
scale 1:2 @ a1

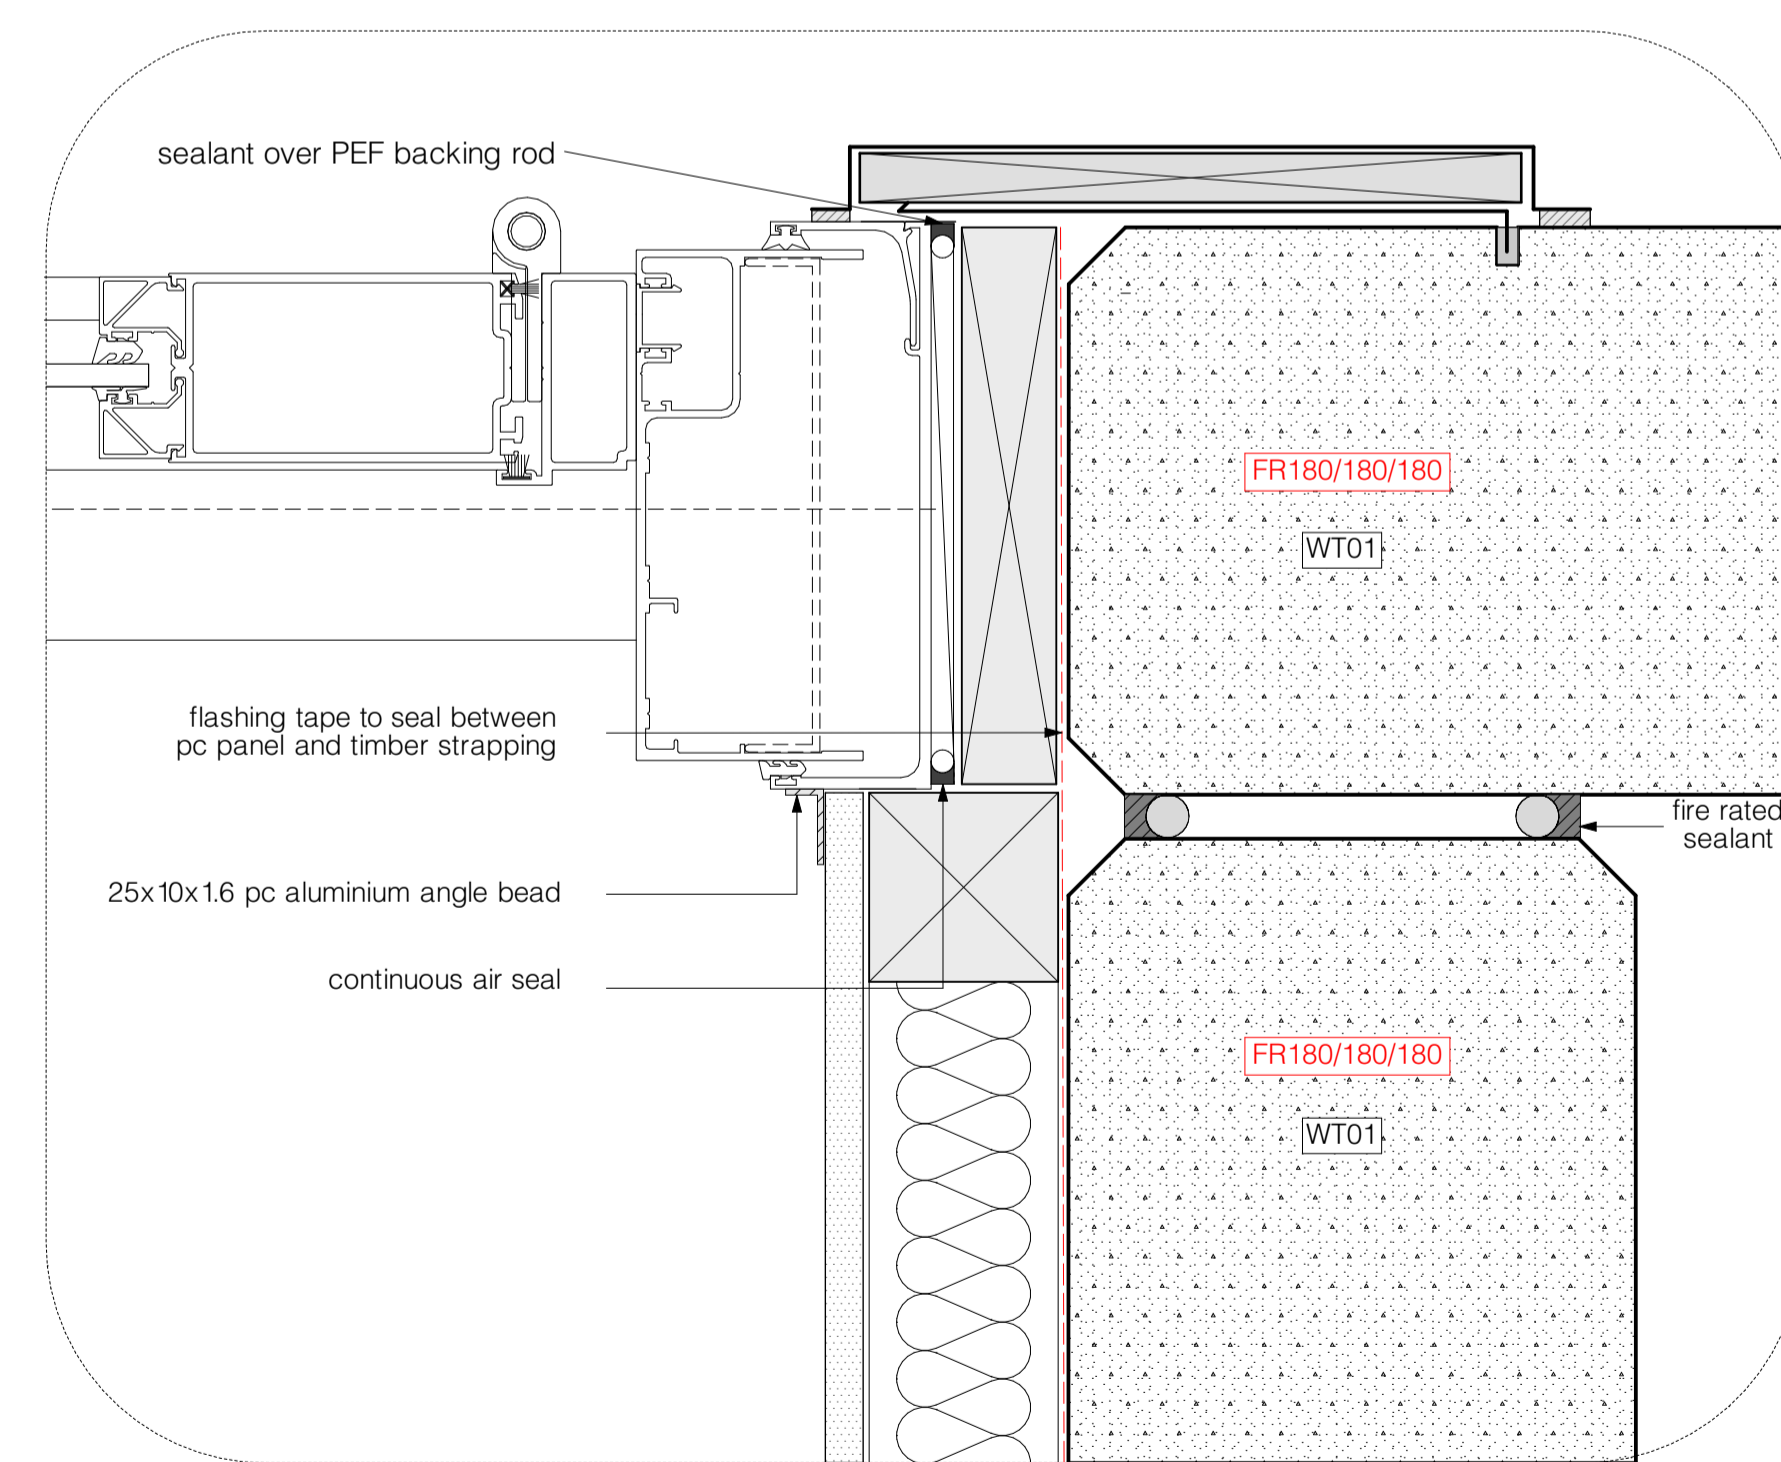

d33 office egress door jamb detail
scale 1:2 @ a1

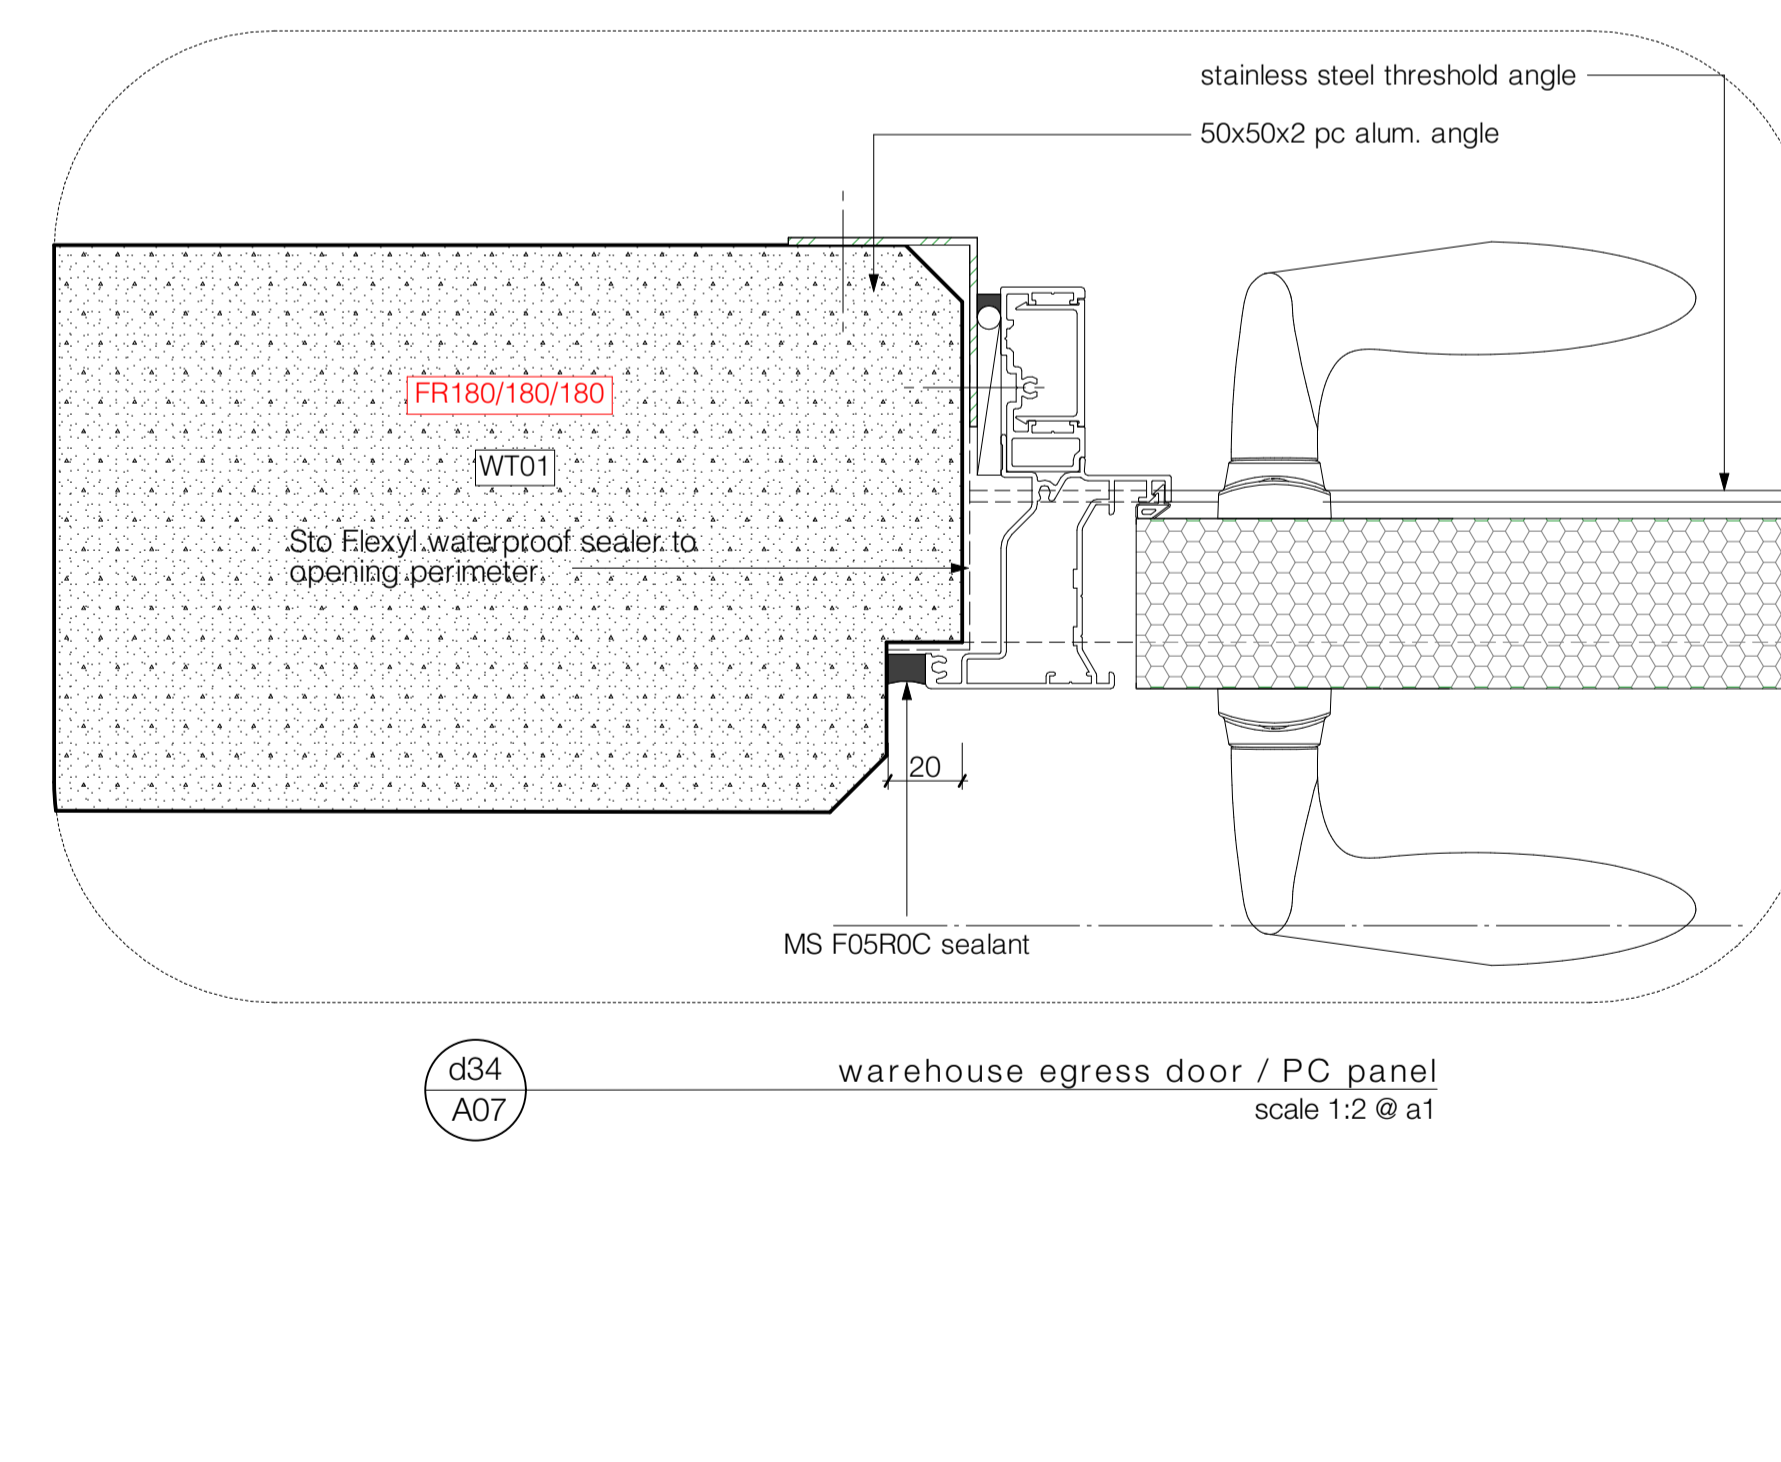

d34 warehouse egress door / PC panel
scale 1:2 @ a1

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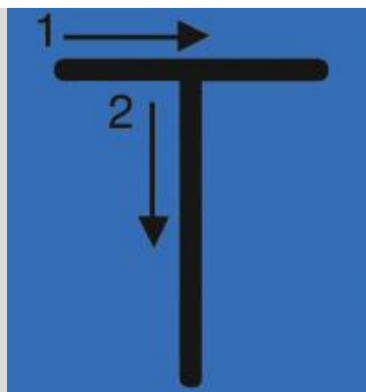
TE RAPA GATEWAY

FOSTER CONSTRUCTION

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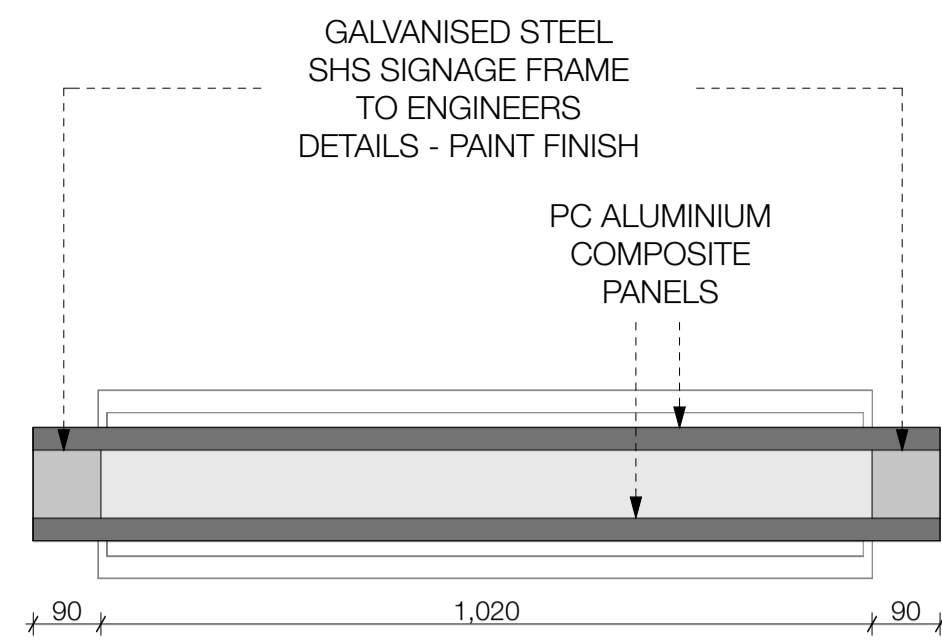
PROJECT:
Te Rapa Stage 2

CLIENT: Fosters Construction
SITE: Te Rapa Industrial Park, Hamilton


FOR CONSTRUCTION ISSUE

DRAWING TITLE:
DETAILS - JOINERY

PROJECT REF: T0424 TE RAPA S2	
DATE: 25/06/19	SCALE: 1:2 @ A1
SHEET: A35	REV: C01



D01 SITE SIGN PLAN
A03 1:10 @ A1

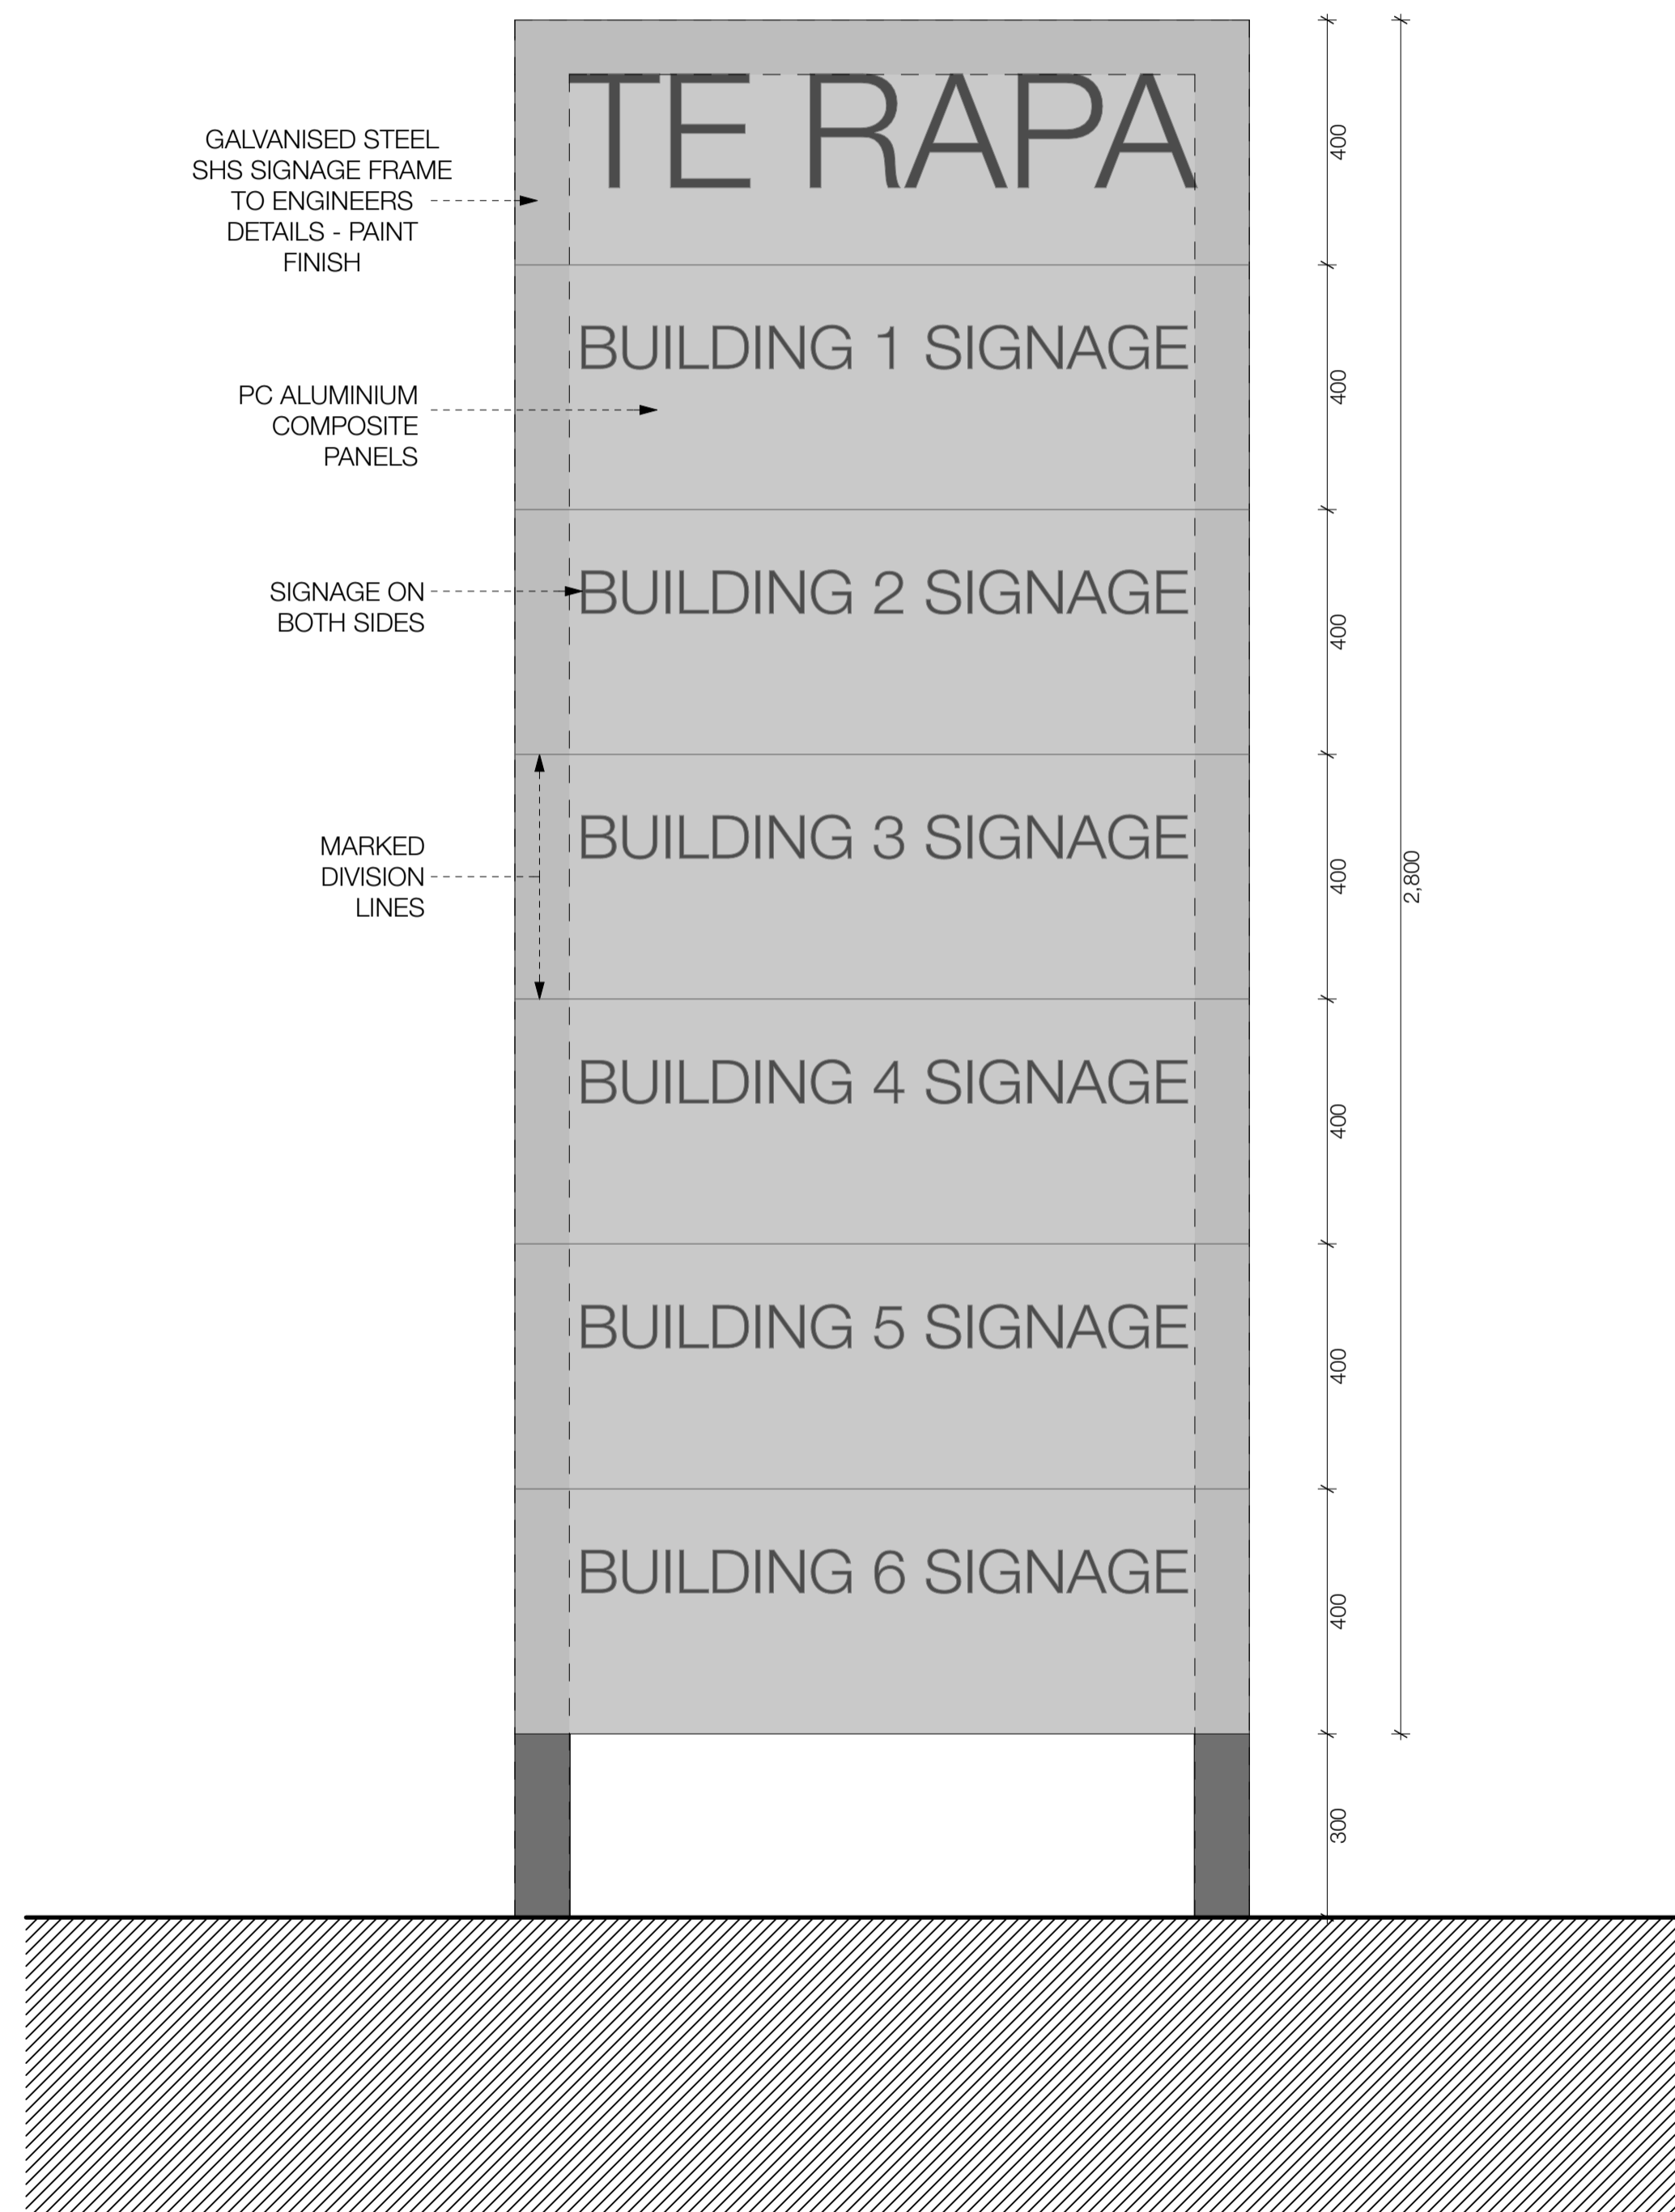

PROPOSED SITE SIGN
- 3.36m²
- DOUBLE SIDED (SAME ON BOTH SIDES)

FOR CONSTRUCTION ISSUE

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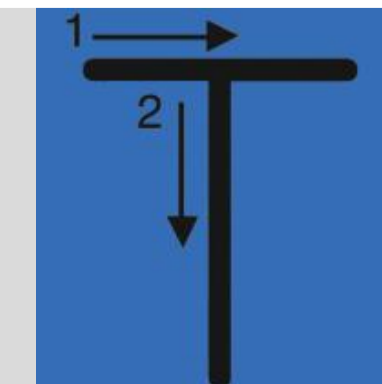
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PROJECT:

Te Rapa Stage 2

CLIENT: Fosters Construction
SITE: Te Rapa Industrial Park, Hamilton

DRAWING TITLE:

DETAILS - SIGNAGE

PROJECT REF:

T0424 TE RAPA S2

DATE:

25/06/19

SCALE:

1:10 @ A1

SHEET:

A36

REV:

C01